#### **GENERAL NOTES:**

- 1. REFERENCE E&S PLAN AND SITE RESTORATION NOTES AND DETAILS FOR ADDITIONAL CONSTRUCTION SEQUENCING, TYPICAL DETAILS AND NOTES (ES-0.01-ES-0.23); AND PLAN SHEETS FOR ADDITIONAL PLANS AND TOPOGRAPHY.
- 2. ALL EXISTING UTILITY INFORMATION IS APPROXIMATE. THE CONTRACTOR IS RESPONSIBLE FOR VERIFYING ALL EXISTING UTILITIES PRIOR TO CONSTRUCTION.
- 3. MAINTAIN 2'-0" MINIMUM VERTICAL SEPARATION BETWEEN THE PROPOSED PIPELINE AND OTHER UTILITIES.
- 4. THE BACKGROUND TOPOGRAPHY WAS OBTAINED FROM TOPOGRAPHIC SURVEYS PERFORMED IN SEPTEMBER 2016.
- 5. THE PROJECT IS LOCATED IN NAD83 PENNSYLVANIA STATE PLANE COORDINATE SYSTEM (SOUTH ZONE), NAVD88.
- 6. EXCAVATION IS LIMITED TO THE CENTERLINE WITH A TYPICAL TRENCH WIDTH OF 4-5'FOR 16/20"PIPELINE.

#### WETLAND CROSSING NOTES:

- 1. REFERENCE NOTES AND DETAILS FOR WETLAND CONSTRUCTION SEQUENCING AND WETLAND RESTORATION (ES-0.03, ES-0.08, ES-0.10, AND ES-0.15).
- 2. A MINIMUM OF 4 FEET COVER UNDER WETLANDS AND UPLANDS IS REQUIRED.
- 3. FOR TEMPORARY TIMBER MAT REFERENCE (ES-0.10)
- 4. EROSION CONTROL BLANKET SHALL BE PLACED A MINIMUM OF 50 FEET EDGE OF WETLAND OR 100 FEET FROM EDGE OF WETLAND FOR SPECIAL PROTECTION WATERS (HQ OR EV).

#### STREAM CROSSING NOTES:

PROFILE LEGEND:

— — EXISTING GRADE

ENGINEERING RECORD

11/30/16

AS NOTED

DRAWN BY RS

CHECKED BY | CDA

APPROVED BY | CDA

OLD DRAWING NO.

DATE

SCALE

SCADA

CHRISTOPHER D. ANTONI PE-057385-E

STV PROJECT No.: 38-17335

— PROPOSED PIPELINE

EXISTING GRADE ELEV.


PROPOSED TOP OF

PIPE ELEV.

- 1. REFERENCE NOTES AND DETAILS FOR STREAM CONSTRUCTION SEQUENCING AND STREAM RESTORATION (ES-0.01-ES-0.17).
- 2. FOR TEMPORARY EQUIPMENT CROSSINGS REFERENCE (ES-0.10).

BANK FOR SPECIAL PROTECTION WATERS (HQ OR EV).

- 3. SITE CONDITIONS MAY ALLOW FOR IMPLEMENTATION OF OTHER APPROVED PIPELINE INSTALLATION METHODS REFERENCED WITH THE NOTES AND DETAILS (ES-0.11-ES-0.14).
- 4. THE PIPELINES SHALL MAINTAIN A MINIMUM OF 5 FEET OF COVER UNDER STREAMS FROM THE TOP OF PIPE TO THE STREAM BED. THIS COVER WILL BE MAINTAINED AT A MINIMUM FROM TOP OF BANK TO TOP OF BANK.
- 5. REFERENCE THE STREAM BANK STABILIZATION DETAIL AND STREAM RESTORATION TABLE IN THE NOTES AND DETAILS WHERE RIP-RAP IS PROPOSED (ES-0.18).
- 6. EROSION CONTROL BLANKET SHALL BE PLACED A MINIMUM OF 50 FEET FROM TOP OF BANK OR 100 FEET FROM TOP OF
- 7. TIMBER MATS SHALL EXTEND A MINIMUM OF 20 FEET BEYOND TOP OF BANK.
- 8. COMPOST FILTER SOCKS SHALL BE INSTALLED ALONG THE TOP OF THE STREAM BANK ACROSS THE RIGHT-OF-WAY WHEN PUMP BYPASS IS NOT IN PLACE.

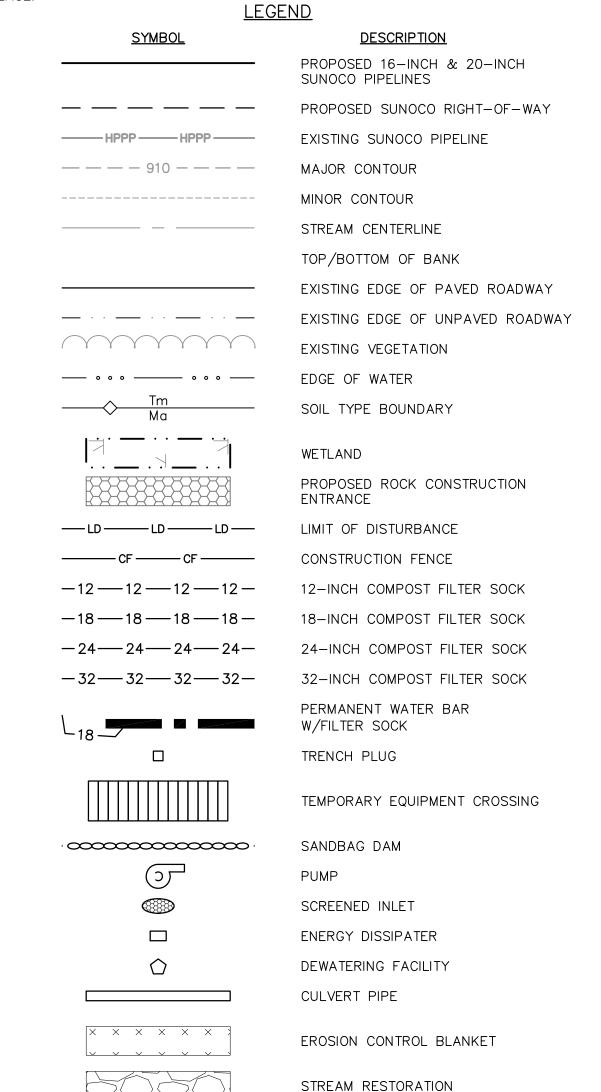

REV. DATE APP# DESCRIPTION
PENNSYLVAN

Sunoco Logistics Partners L.P.

PENNSYLVANIA PIPELINE PROJECT
STREAM S-BB118
EXISTING CONDITIONS/EROSION &
SEDIMENTATION CONTROL PLANS


YORK COUNTY, PA

APPROVAL

S-BB118A


ojects\3817335\3817335\_0001\90\_CAD Models and Sheets\04\_C\_C

RESTORATION PLAN SCALE: 1"=20'

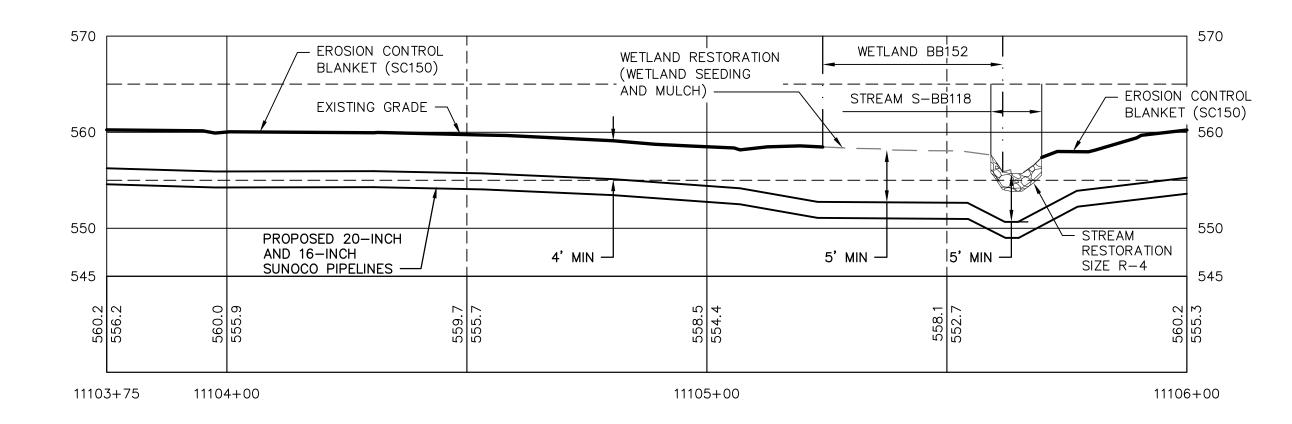

<u>PROFILE</u>

GRAPHIC SCALES

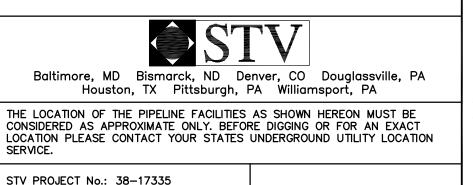

REGISTERED PROFESSIONAL CHRISTOPHER D. ANTONI ENGINEER No. PE−057385−E OLD DRAWING NO. CHRISTOPHER D. ANTONI

PE-057385-E

ENGINEERING RECORD DRAWN BY RS CHECKED BY CDA APPROVED BY | CDA | 11/30/16 DATE SCALE AS NOTED SCADA

PROFILE LEGEND:

— — EXISTING GRADE

— PROPOSED PIPELINE

EXISTING GRADE ELEV.

PROPOSED TOP OF

PIPE ELEV.

**GENERAL NOTES:** 

UTILITIES PRIOR TO CONSTRUCTION.

ES-0.08, ES-0.10, AND ES-0.15).

STREAM CROSSING NOTES:

(ES-0.01-ES-0.17).

3. FOR TEMPORARY TIMBER MAT REFERENCE (ES-0.10)

WETLAND FOR SPECIAL PROTECTION WATERS (HQ OR EV).

2. FOR TEMPORARY EQUIPMENT CROSSINGS REFERENCE (ES-0.10).

WITH THE NOTES AND DETAILS (ES-0.11-ES-0.14).

BANK FOR SPECIAL PROTECTION WATERS (HQ OR EV).

7. TIMBER MATS SHALL EXTEND A MINIMUM OF 20 FEET BEYOND TOP OF BANK.

WHERE RIP-RAP IS PROPOSED (ES-0.18).

WHEN PUMP BYPASS IS NOT IN PLACE.

1. REFERENCE E&S PLAN AND SITE RESTORATION NOTES AND DETAILS FOR ADDITIONAL CONSTRUCTION SEQUENCING, TYPICAL DETAILS AND NOTES (ES-0.01-ES-0.23); AND PLAN SHEETS FOR ADDITIONAL PLANS AND TOPOGRAPHY.

3. MAINTAIN 2'-0" MINIMUM VERTICAL SEPARATION BETWEEN THE PROPOSED PIPELINE AND OTHER UTILITIES.

6. EXCAVATION IS LIMITED TO THE CENTERLINE WITH A TYPICAL TRENCH WIDTH OF 4-5'FOR 16/20"PIPELINE.

1. REFERENCE NOTES AND DETAILS FOR STREAM CONSTRUCTION SEQUENCING AND STREAM RESTORATION

2. A MINIMUM OF 4 FEET COVER UNDER WETLANDS AND UPLANDS IS REQUIRED.

4. THE BACKGROUND TOPOGRAPHY WAS OBTAINED FROM TOPOGRAPHIC SURVEYS PERFORMED IN SEPTEMBER 2016.

5. THE PROJECT IS LOCATED IN NAD83 PENNSYLVANIA STATE PLANE COORDINATE SYSTEM (SOUTH ZONE), NAVD88.

1. REFERENCE NOTES AND DETAILS FOR WETLAND CONSTRUCTION SEQUENCING AND WETLAND RESTORATION (ES-0.03,

4. EROSION CONTROL BLANKET SHALL BE PLACED A MINIMUM OF 50 FEET EDGE OF WETLAND OR 100 FEET FROM EDGE OF

3. SITE CONDITIONS MAY ALLOW FOR IMPLEMENTATION OF OTHER APPROVED PIPELINE INSTALLATION METHODS REFERENCED

4. THE PIPELINES SHALL MAINTAIN A MINIMUM OF 5 FEET OF COVER UNDER STREAMS FROM THE TOP OF PIPE TO THE

5. REFERENCE THE STREAM BANK STABILIZATION DETAIL AND STREAM RESTORATION TABLE IN THE NOTES AND DETAILS

8. COMPOST FILTER SOCKS SHALL BE INSTALLED ALONG THE TOP OF THE STREAM BANK ACROSS THE RIGHT-OF-WAY

<u>SYMBOL</u>

— — — — 910 — — — —

— · · · · — · · · · —

—LD——LD——LD—

-12 --- 12 --- 12 --- 12 ---

—18 ——18 ——18 —

-24—24—24—24—

-32—32—32—32—

6. EROSION CONTROL BLANKET SHALL BE PLACED A MINIMUM OF 50 FEET FROM TOP OF BANK OR 100 FEET FROM TOP OF

**LEGEND** 

**DESCRIPTION** 

EXISTING SUNOCO PIPELINE

SUNOCO PIPELINES

MAJOR CONTOUR

MINOR CONTOUR

STREAM CENTERLINE

TOP/BOTTOM OF BANK

EXISTING VEGETATION

SOIL TYPE BOUNDARY

LIMIT OF DISTURBANCE

CONSTRUCTION FENCE

EDGE OF WATER

WETLAND

ENTRANCE

PROPOSED 16-INCH & 20-INCH

PROPOSED SUNOCO RIGHT-OF-WAY

EXISTING EDGE OF PAVED ROADWAY

PROPOSED ROCK CONSTRUCTION

12-INCH COMPOST FILTER SOCK

18-INCH COMPOST FILTER SOCK

24-INCH COMPOST FILTER SOCK

32-INCH COMPOST FILTER SOCK

TEMPORARY EQUIPMENT CROSSING

PERMANENT WATER BAR

W/FILTER SOCK

TRENCH PLUG

SANDBAG DAM

SCREENED INLET

CULVERT PIPE

ENERGY DISSIPATER

DEWATERING FACILITY

STREAM RESTORATION

EROSION CONTROL BLANKET

PUMP

EXISTING EDGE OF UNPAVED ROADWAY

STREAM BED. THIS COVER WILL BE MAINTAINED AT A MINIMUM FROM TOP OF BANK TO TOP OF BANK.

2. ALL EXISTING UTILITY INFORMATION IS APPROXIMATE. THE CONTRACTOR IS RESPONSIBLE FOR VERIFYING ALL EXISTING

REV. DATE APP# DESCRIPTION

PENNSYLVANIA PIPELINE PROJECT STREAM S-BB118


YORK COUNTY, PA

APPROVAL

DWG. NO. REV. NO. S-BB118-B

**Sunoco Logistics** Partners L.P.

**RESTORATION PLAN** 

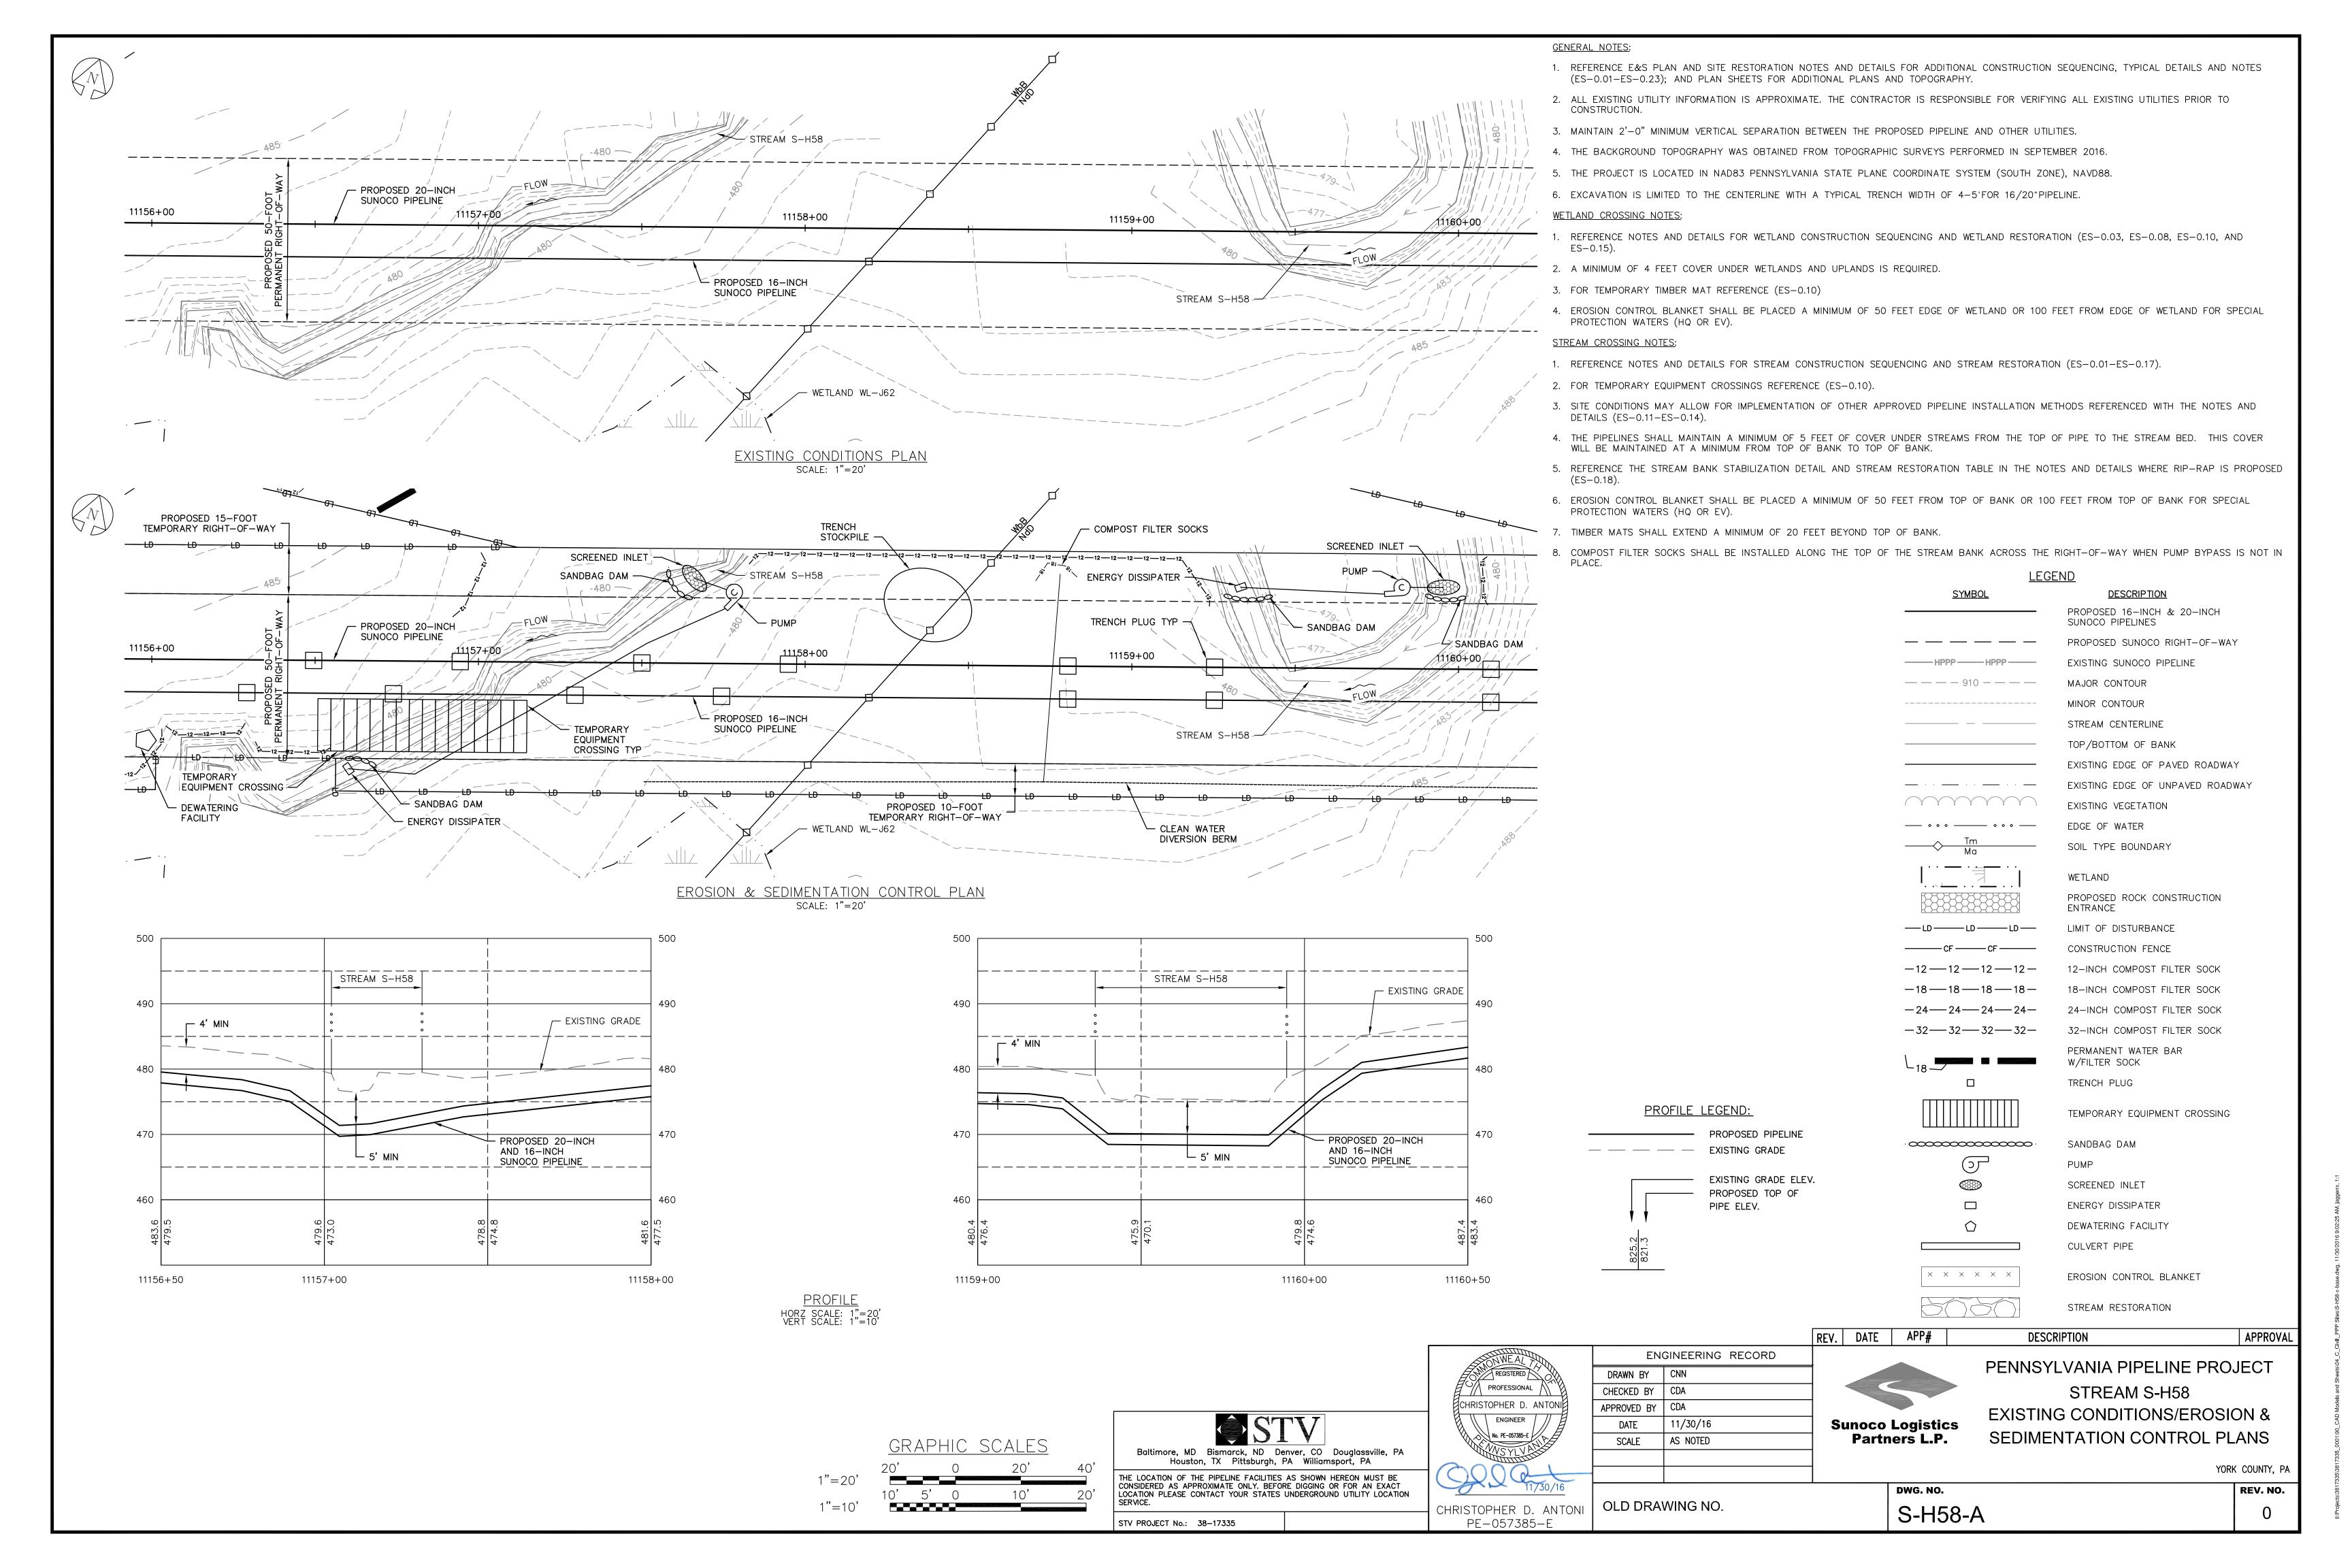

#### **GENERAL NOTES:**

- 1. REFERENCE E&S PLAN AND SITE RESTORATION NOTES AND DETAILS FOR ADDITIONAL CONSTRUCTION SEQUENCING, TYPICAL DETAILS AND NOTES (ES-0.01-ES-0.23); AND PLAN SHEETS FOR ADDITIONAL PLANS AND TOPOGRAPHY.
- 2. ALL EXISTING UTILITY INFORMATION IS APPROXIMATE. THE CONTRACTOR IS RESPONSIBLE FOR VERIFYING ALL EXISTING UTILITIES PRIOR TO
- 3. MAINTAIN 2'-0" MINIMUM VERTICAL SEPARATION BETWEEN THE PROPOSED PIPELINE AND OTHER UTILITIES.
- 4. THE BACKGROUND TOPOGRAPHY WAS OBTAINED FROM TOPOGRAPHIC SURVEYS PERFORMED IN SEPTEMBER 2016.
- 5. THE PROJECT IS LOCATED IN NAD83 PENNSYLVANIA STATE PLANE COORDINATE SYSTEM (SOUTH ZONE), NAVD88.
- 6. EXCAVATION IS LIMITED TO THE CENTERLINE WITH A TYPICAL TRENCH WIDTH OF 4-5'FOR 16/20"PIPELINE.

- 1. REFERENCE NOTES AND DETAILS FOR WETLAND CONSTRUCTION SEQUENCING AND WETLAND RESTORATION (ES-0.03, ES-0.08, ES-0.10, AND
- 2. A MINIMUM OF 4 FEET COVER UNDER WETLANDS AND UPLANDS IS REQUIRED.
- 3. FOR TEMPORARY TIMBER MAT REFERENCE (ES-0.10)
- 4. EROSION CONTROL BLANKET SHALL BE PLACED A MINIMUM OF 50 FEET EDGE OF WETLAND OR 100 FEET FROM EDGE OF WETLAND FOR SPECIAL PROTECTION WATERS (HQ OR EV).
- REFERENCE NOTES AND DETAILS FOR STREAM CONSTRUCTION SEQUENCING AND STREAM RESTORATION (ES-0.01-ES-0.17).
- 2. FOR TEMPORARY EQUIPMENT CROSSINGS REFERENCE (ES-0.10).
- SITE CONDITIONS MAY ALLOW FOR IMPLEMENTATION OF OTHER APPROVED PIPELINE INSTALLATION METHODS REFERENCED WITH THE NOTES AND DETAILS (ES-0.11-ES-0.14).
- THE PIPELINES SHALL MAINTAIN A MINIMUM OF 5 FEET OF COVER UNDER STREAMS FROM THE TOP OF PIPE TO THE STREAM BED. THIS COVER WILL BE MAINTAINED AT A MINIMUM FROM TOP OF BANK TO TOP OF BANK.
- 5. REFERENCE THE STREAM BANK STABILIZATION DETAIL AND STREAM RESTORATION TABLE IN THE NOTES AND DETAILS WHERE RIP-RAP IS PROPOSED
- EROSION CONTROL BLANKET SHALL BE PLACED A MINIMUM OF 50 FEET FROM TOP OF BANK OR 100 FEET FROM TOP OF BANK FOR SPECIAL PROTECTION WATERS (HQ OR EV).
- TIMBER MATS SHALL EXTEND A MINIMUM OF 20 FEET BEYOND TOP OF BANK.


PROPOSED PIPELINE

EXISTING GRADE ELEV.

PROPOSED TOP OF

PIPE ELEV.

COMPOST FILTER SOCKS SHALL BE INSTALLED ALONG THE TOP OF THE STREAM BANK ACROSS THE RIGHT-OF-WAY WHEN PUMP BYPASS IS NOT IN

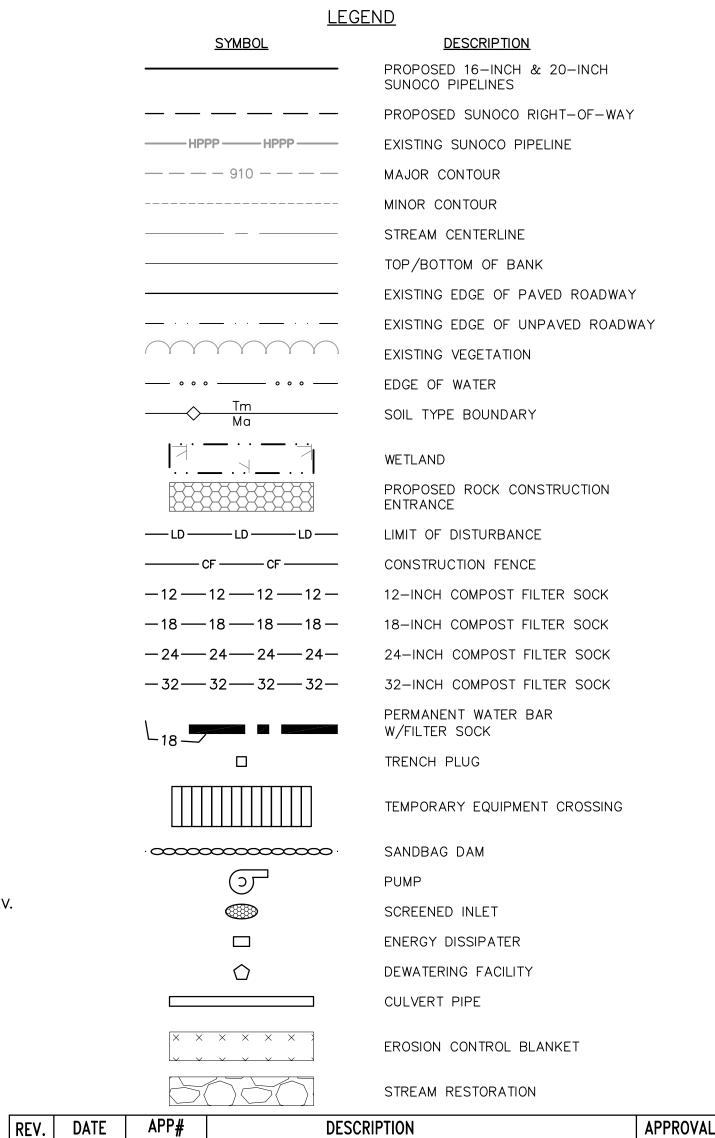

CONSIDERED AS APPROXIMATE ONLY. BEFORE DIGGING OR FOR AN EXACT

STV PROJECT No.: 38-17335

LOCATION PLEASE CONTACT YOUR STATES UNDERGROUND UTILITY LOCATION CHRISTOPHER D. ANTONI

PE-057385-E

11/30/16 AS NOTED

Sunoco Logistics Partners L.P.

DWG. NO.

PENNSYLVANIA PIPELINE PROJECT STREAM S-H58 RESTORATION PLAN

YORK COUNTY, PA

S-H58-B

OLD DRAWING NO.

REV. NO.

#### **GENERAL NOTES:**

- 1. REFERENCE E&S PLAN AND SITE RESTORATION NOTES AND DETAILS FOR ADDITIONAL CONSTRUCTION SEQUENCING, TYPICAL DETAILS AND NOTES (ES-0.01-ES-0.23); AND PLAN SHEETS FOR ADDITIONAL PLANS AND TOPOGRAPHY.
- 2. ALL EXISTING UTILITY INFORMATION IS APPROXIMATE. THE CONTRACTOR IS RESPONSIBLE FOR VERIFYING ALL EXISTING UTILITIES PRIOR TO CONSTRUCTION.
- 3. MAINTAIN 2'-0" MINIMUM VERTICAL SEPARATION BETWEEN THE PROPOSED PIPELINE AND OTHER UTILITIES.
- 4. THE BACKGROUND TOPOGRAPHY WAS OBTAINED FROM TOPOGRAPHIC SURVEYS PERFORMED IN SEPTEMBER 2016.
- 5. THE PROJECT IS LOCATED IN NAD83 PENNSYLVANIA STATE PLANE COORDINATE SYSTEM (SOUTH ZONE), NAVD88.
- 6. EXCAVATION IS LIMITED TO THE CENTERLINE WITH A TYPICAL TRENCH WIDTH OF 4-5'FOR 16/20"PIPELINE.

### WETLAND CROSSING NOTES:

- 1. REFERENCE NOTES AND DETAILS FOR WETLAND CONSTRUCTION SEQUENCING AND WETLAND RESTORATION (ES-0.03, ES-0.08, ES-0.10, AND ES-0.15).
- 2. A MINIMUM OF 4 FEET COVER UNDER WETLANDS AND UPLANDS IS REQUIRED.
- 3. FOR TEMPORARY TIMBER MAT REFERENCE (ES-0.10)
- 4. EROSION CONTROL BLANKET SHALL BE PLACED A MINIMUM OF 50 FEET EDGE OF WETLAND OR 100 FEET FROM EDGE OF WETLAND FOR SPECIAL PROTECTION WATERS (HQ OR EV).

#### STREAM CROSSING NOTES:

- 1. REFERENCE NOTES AND DETAILS FOR STREAM CONSTRUCTION SEQUENCING AND STREAM RESTORATION (ES-0.01-ES-0.17).
- 2. FOR TEMPORARY EQUIPMENT CROSSINGS REFERENCE (ES-0.10).
- 3. SITE CONDITIONS MAY ALLOW FOR IMPLEMENTATION OF OTHER APPROVED PIPELINE INSTALLATION METHODS REFERENCED WITH THE NOTES AND DETAILS (ES-0.11-ES-0.14).
- 4. THE PIPELINES SHALL MAINTAIN A MINIMUM OF 5 FEET OF COVER UNDER STREAMS FROM THE TOP OF PIPE TO THE STREAM BED. THIS COVER WILL BE MAINTAINED AT A MINIMUM FROM TOP OF BANK TO TOP OF BANK.
- 5. REFERENCE THE STREAM BANK STABILIZATION DETAIL AND STREAM RESTORATION TABLE IN THE NOTES AND DETAILS WHERE RIP-RAP IS PROPOSED (ES-0.18).
- 6. EROSION CONTROL BLANKET SHALL BE PLACED A MINIMUM OF 50 FEET FROM TOP OF BANK OR 100 FEET FROM TOP OF BANK FOR SPECIAL PROTECTION WATERS (HQ OR EV).
- 7. TIMBER MATS SHALL EXTEND A MINIMUM OF 20 FEET BEYOND TOP OF BANK.
- 8. COMPOST FILTER SOCKS SHALL BE INSTALLED ALONG THE TOP OF THE STREAM BANK ACROSS THE RIGHT-OF-WAY WHEN PUMP BYPASS IS NOT IN PLACE.

<u>LEGEND</u> <u>SYMBOL</u> **DESCRIPTION** PROPOSED 16-INCH & 20-INCH SUNOCO PIPELINES PROPOSED SUNOCO RIGHT-OF-WAY EXISTING SUNOCO PIPELINE — — — — 910 — — — — MAJOR CONTOUR MINOR CONTOUR STREAM CENTERLINE TOP/BOTTOM OF BANK EXISTING EDGE OF PAVED ROADWAY EXISTING EDGE OF UNPAVED ROADWAY EXISTING VEGETATION SOIL TYPE BOUNDARY WETLAND PROPOSED ROCK CONSTRUCTION ENTRANCE LIMIT OF DISTURBANCE —LD — LD — LD — CONSTRUCTION FENCE 12-INCH COMPOST FILTER SOCK 18-INCH COMPOST FILTER SOCK -24—24—24—24— 24-INCH COMPOST FILTER SOCK 32-INCH COMPOST FILTER SOCK PERMANENT WATER BAR W/FILTER SOCK TRENCH PLUG TEMPORARY EQUIPMENT CROSSING SANDBAG DAM  $\cdot$ PUMP SCREENED INLET ENERGY DISSIPATER DEWATERING FACILITY CULVERT PIPE  $\times$   $\times$   $\times$   $\times$   $\times$ EROSION CONTROL BLANKET STREAM RESTORATION

REGISTERED PROFESSIONAL CHRISTOPHER D. ANTONI ENGINEER No. PE-057385-E OLD DRAWING NO.

STV PROJECT No.: 38-17335

ENGINEERING RECORD DRAWN BY PDZ CHECKED BY | CDA APPROVED BY | CDA 11/30/16 DATE AS NOTED SCALE

PROFILE LEGEND:

— — — EXISTING GRADE

PROPOSED PIPELINE

EXISTING GRADE ELEV.

PROPOSED TOP OF

PIPE ELEV.

**Sunoco Logistics** Partners L.P.

DWG. NO.

REV. DATE APP#

PENNSYLVANIA PIPELINE PROJECT STREAM S-H56 **EXISTING CONDITIONS/EROSION &** SEDIMENTATION CONTROL PLANS

DESCRIPTION

YORK COUNTY, PA REV. NO.


APPROVA

S-H56A

RESTORED GRADE PROFILE

HORZ SCALE: 1"=20' VERT SCALE: 1"=10'

# GRAPHIC SCALES 10' 5' 0 10'

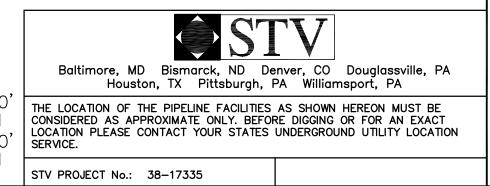

REGISTERED PROFESSIONAL CHRISTOPHER D. ANTONI ENGINEER No. PE-057385-E CHRISTOPHER D. ANTONI PE-057385-E

ENGINEERING RECORD DRAWN BY PDZ CHECKED BY | CDA APPROVED BY | CDA 11/30/16 SCALE AS NOTED OLD DRAWING NO.

PROFILE LEGEND:

— — — EXISTING GRADE

PROPOSED PIPELINE

PIPE ELEV.

EXISTING GRADE ELEV.

PROPOSED TOP OF

REV. DATE APP# **Sunoco Logistics** Partners L.P.

DWG. NO.

S-H56B

## PENNSYLVANIA PIPELINE PROJECT STREAM S-H56 RESTORATION PLAN

YORK COUNTY, PA REV. NO.

**GENERAL NOTES:** 

1. REFERENCE E&S PLAN AND SITE RESTORATION NOTES AND DETAILS FOR ADDITIONAL CONSTRUCTION SEQUENCING, TYPICAL DETAILS AND NOTES (ES-0.01-ES-0.23); AND PLAN SHEETS FOR ADDITIONAL PLANS AND TOPOGRAPHY.

2. ALL EXISTING UTILITY INFORMATION IS APPROXIMATE. THE CONTRACTOR IS RESPONSIBLE FOR VERIFYING ALL EXISTING UTILITIES PRIOR TO CONSTRUCTION.

3. MAINTAIN 2'-0" MINIMUM VERTICAL SEPARATION BETWEEN THE PROPOSED PIPELINE AND OTHER UTILITIES. 4. THE BACKGROUND TOPOGRAPHY WAS OBTAINED FROM TOPOGRAPHIC SURVEYS PERFORMED IN SEPTEMBER 2016.

5. THE PROJECT IS LOCATED IN NAD83 PENNSYLVANIA STATE PLANE COORDINATE SYSTEM (SOUTH ZONE), NAVD88.

6. EXCAVATION IS LIMITED TO THE CENTERLINE WITH A TYPICAL TRENCH WIDTH OF 4-5'FOR 16/20" PIPELINE.

### WETLAND CROSSING NOTES:

1. REFERENCE NOTES AND DETAILS FOR WETLAND CONSTRUCTION SEQUENCING AND WETLAND RESTORATION (ES-0.03, ES-0.08, ES-0.10, AND ES-0.15).

- 2. A MINIMUM OF 4 FEET COVER UNDER WETLANDS AND UPLANDS IS REQUIRED.
- 3. FOR TEMPORARY TIMBER MAT REFERENCE (ES-0.10)
- 4. EROSION CONTROL BLANKET SHALL BE PLACED A MINIMUM OF 50 FEET EDGE OF WETLAND OR 100 FEET FROM EDGE OF WETLAND FOR SPECIAL PROTECTION WATERS (HQ OR EV).

#### STREAM CROSSING NOTES:

- 1. REFERENCE NOTES AND DETAILS FOR STREAM CONSTRUCTION SEQUENCING AND STREAM RESTORATION (ES-0.01-ES-0.17).
- 2. FOR TEMPORARY EQUIPMENT CROSSINGS REFERENCE (ES-0.10).
- 3. SITE CONDITIONS MAY ALLOW FOR IMPLEMENTATION OF OTHER APPROVED PIPELINE INSTALLATION METHODS REFERENCED WITH THE NOTES AND DETAILS (ES-0.11-ES-0.14).
- 4. THE PIPELINES SHALL MAINTAIN A MINIMUM OF 5 FEET OF COVER UNDER STREAMS FROM THE TOP OF PIPE TO THE STREAM BED. THIS COVER WILL BE MAINTAINED AT A MINIMUM FROM TOP OF BANK TO TOP OF BANK.
- 5. REFERENCE THE STREAM BANK STABILIZATION DETAIL AND STREAM RESTORATION TABLE IN THE NOTES AND DETAILS WHERE RIP-RAP IS PROPOSED (ES-0.18).
- 6. EROSION CONTROL BLANKET SHALL BE PLACED A MINIMUM OF 50 FEET FROM TOP OF BANK OR 100 FEET FROM TOP OF BANK FOR SPECIAL PROTECTION WATERS (HQ OR EV).
- 7. TIMBER MATS SHALL EXTEND A MINIMUM OF 20 FEET BEYOND TOP OF BANK.
- 8. COMPOST FILTER SOCKS SHALL BE INSTALLED ALONG THE TOP OF THE STREAM BANK ACROSS THE RIGHT-OF-WAY WHEN PUMP BYPASS IS NOT IN PLACE.

<u>SYMBOL</u>

PROPOSED 16-INCH & 20-INCH SUNOCO PIPELINES PROPOSED SUNOCO RIGHT-OF-WAY EXISTING SUNOCO PIPELINE — — — — 910 — — — — MAJOR CONTOUR MINOR CONTOUR STREAM CENTERLINE TOP/BOTTOM OF BANK EXISTING EDGE OF PAVED ROADWAY EXISTING EDGE OF UNPAVED ROADWAY EXISTING VEGETATION SOIL TYPE BOUNDARY WETLAND PROPOSED ROCK CONSTRUCTION ENTRANCE —LD — LD — LD — LIMIT OF DISTURBANCE CONSTRUCTION FENCE 12-INCH COMPOST FILTER SOCK 18-INCH COMPOST FILTER SOCK -24-24-24-24-24-INCH COMPOST FILTER SOCK -32 - 32 - 32 - 32 -32-INCH COMPOST FILTER SOCK PERMANENT WATER BAR W/FILTER SOCK TRENCH PLUG TEMPORARY EQUIPMENT CROSSING SANDBAG DAM  $\cdot$ PUMP SCREENED INLET ENERGY DISSIPATER DEWATERING FACILITY CULVERT PIPE  $\times$   $\times$   $\times$   $\times$   $\times$ EROSION CONTROL BLANKET 

<u>LEGEND</u>

**DESCRIPTION** 

STREAM RESTORATION DESCRIPTION

APPROVAL