


- 1. REFERENCE E&S PLAN AND SITE RESTORATION NOTES AND DETAILS FOR ADDITIONAL CONSTRUCTION SEQUENCING, TYPICAL DETAILS AND NOTES (ES-0.01-ES-0.23); AND PLAN SHEETS FOR ADDITIONAL PLANS AND TOPOGRAPHY.
- 2. ALL EXISTING UTILITY INFORMATION IS APPROXIMATE. THE CONTRACTOR IS RESPONSIBLE FOR VERIFYING ALL EXISTING UTILITIES PRIOR TO CONSTRUCTION.
- 3. MAINTAIN 2'-0" MINIMUM VERTICAL SEPARATION BETWEEN THE PROPOSED PIPELINE AND OTHER UTILITIES.
- 4. THE BACKGROUND TOPOGRAPHY WAS OBTAINED FROM TOPOGRAPHIC SURVEYS PERFORMED IN SEPTEMBER 2016.
- 5. THE PROJECT IS LOCATED IN NAD83 PENNSYLVANIA STATE PLANE COORDINATE SYSTEM (SOUTH ZONE), NAVD88.
- 6. EXCAVATION IS LIMITED TO THE CENTERLINE WITH A TYPICAL TRENCH WIDTH OF 4-5'FOR 16/20"PIPELINE.


### WETLAND CROSSING NOTES:


- 1. REFERENCE NOTES AND DETAILS FOR WETLAND CONSTRUCTION SEQUENCING AND WETLAND RESTORATION (ES-0.03, ES-0.08, ES-0.10, AND ES-0.15).
- 2. A MINIMUM OF 4 FEET COVER UNDER WETLANDS AND UPLANDS IS REQUIRED.
- 3. FOR TEMPORARY TIMBER MAT REFERENCE (ES-0.10)
- 4. EROSION CONTROL BLANKET SHALL BE PLACED A MINIMUM OF 50 FEET EDGE OF WETLAND OR 100 FEET FROM EDGE OF WETLAND FOR SPECIAL PROTECTION WATERS (HQ OR EV).

### STREAM CROSSING NOTES:

- 1. REFERENCE NOTES AND DETAILS FOR STREAM CONSTRUCTION SEQUENCING AND STREAM RESTORATION (ES-0.01-ES-0.17).
- 2. FOR TEMPORARY EQUIPMENT CROSSINGS REFERENCE (ES-0.10).
- 3. SITE CONDITIONS MAY ALLOW FOR IMPLEMENTATION OF OTHER APPROVED PIPELINE INSTALLATION METHODS REFERENCED WITH THE NOTES AND DETAILS (ES-0.11-ES-0.14).
- 4. THE PIPELINES SHALL MAINTAIN A MINIMUM OF 5 FEET OF COVER UNDER STREAMS FROM THE TOP OF PIPE TO THE STREAM BED. THIS COVER WILL BE MAINTAINED AT A MINIMUM FROM TOP OF BANK TO TOP OF BANK.
- 5. REFERENCE THE STREAM BANK STABILIZATION DETAIL AND STREAM RESTORATION TABLE IN THE NOTES AND DETAILS WHERE RIP-RAP IS PROPOSED (ES-0.18).
- 6. EROSION CONTROL BLANKET SHALL BE PLACED A MINIMUM OF 50 FEET FROM TOP OF BANK OR 100 FEET FROM TOP OF BANK FOR SPECIAL PROTECTION WATERS (HQ OR EV).
- 7. TIMBER MATS SHALL EXTEND A MINIMUM OF 20 FEET BEYOND TOP OF BANK.
- 8. COMPOST FILTER SOCKS SHALL BE INSTALLED ALONG THE TOP OF THE STREAM BANK ACROSS THE RIGHT-OF-WAY WHEN PUMP BYPASS IS NOT IN

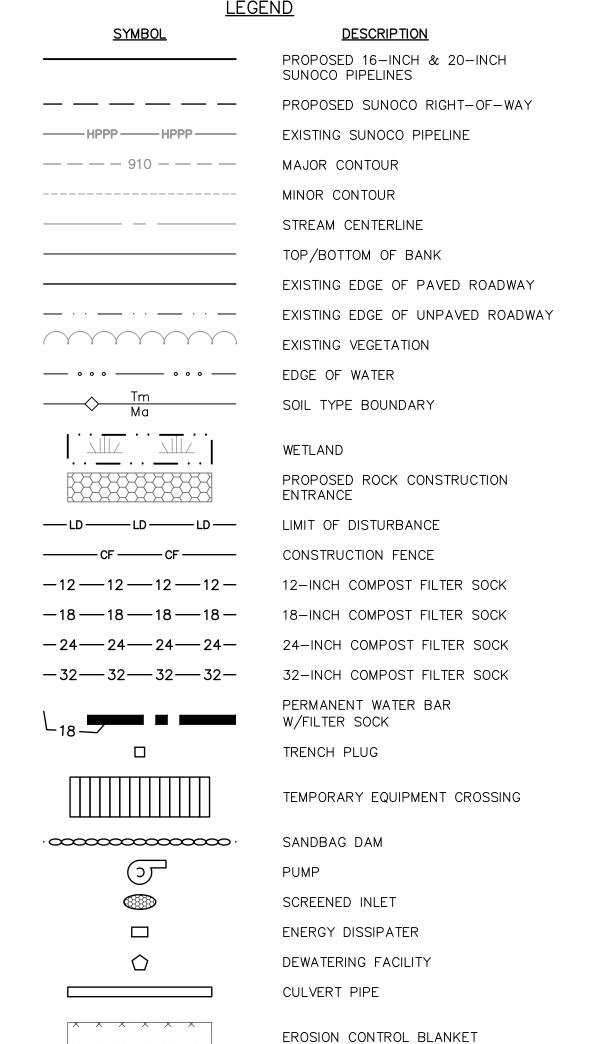

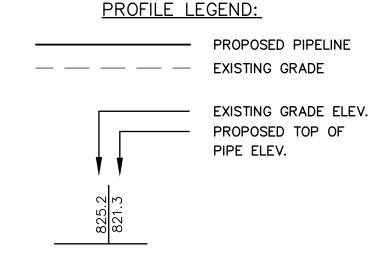

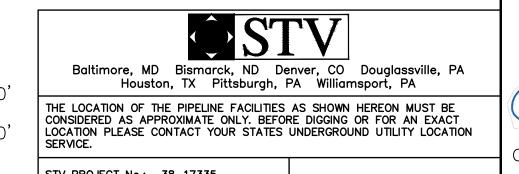

REV. DATE ENGINEERING RECORD DRAWN BY DLH PROFESSIONAL CHECKED BY | CDA CHRISTOPHER D. ANTONI APPROVED BY CDA ENGINEER 11/30/16 DATE No. PE-057385-E AS NOTED SCALE

PENNSYLVANIA PIPELINE PROJECT STREAM S-J43 RESTORATION PLAN **Sunoco Logistics** Partners L.P.

DESCRIPTION

APP#

DWG. NO.

CUMBERLAND COUNTY, PA

APPROVAL

REV. NO.

CHRISTOPHER D. ANTONI PE-057385-E


OLD DRAWING NO.


S-J43-B

STREAM RESTORATION

STV PROJECT No.: 38-17335

GRAPHIC SCALES

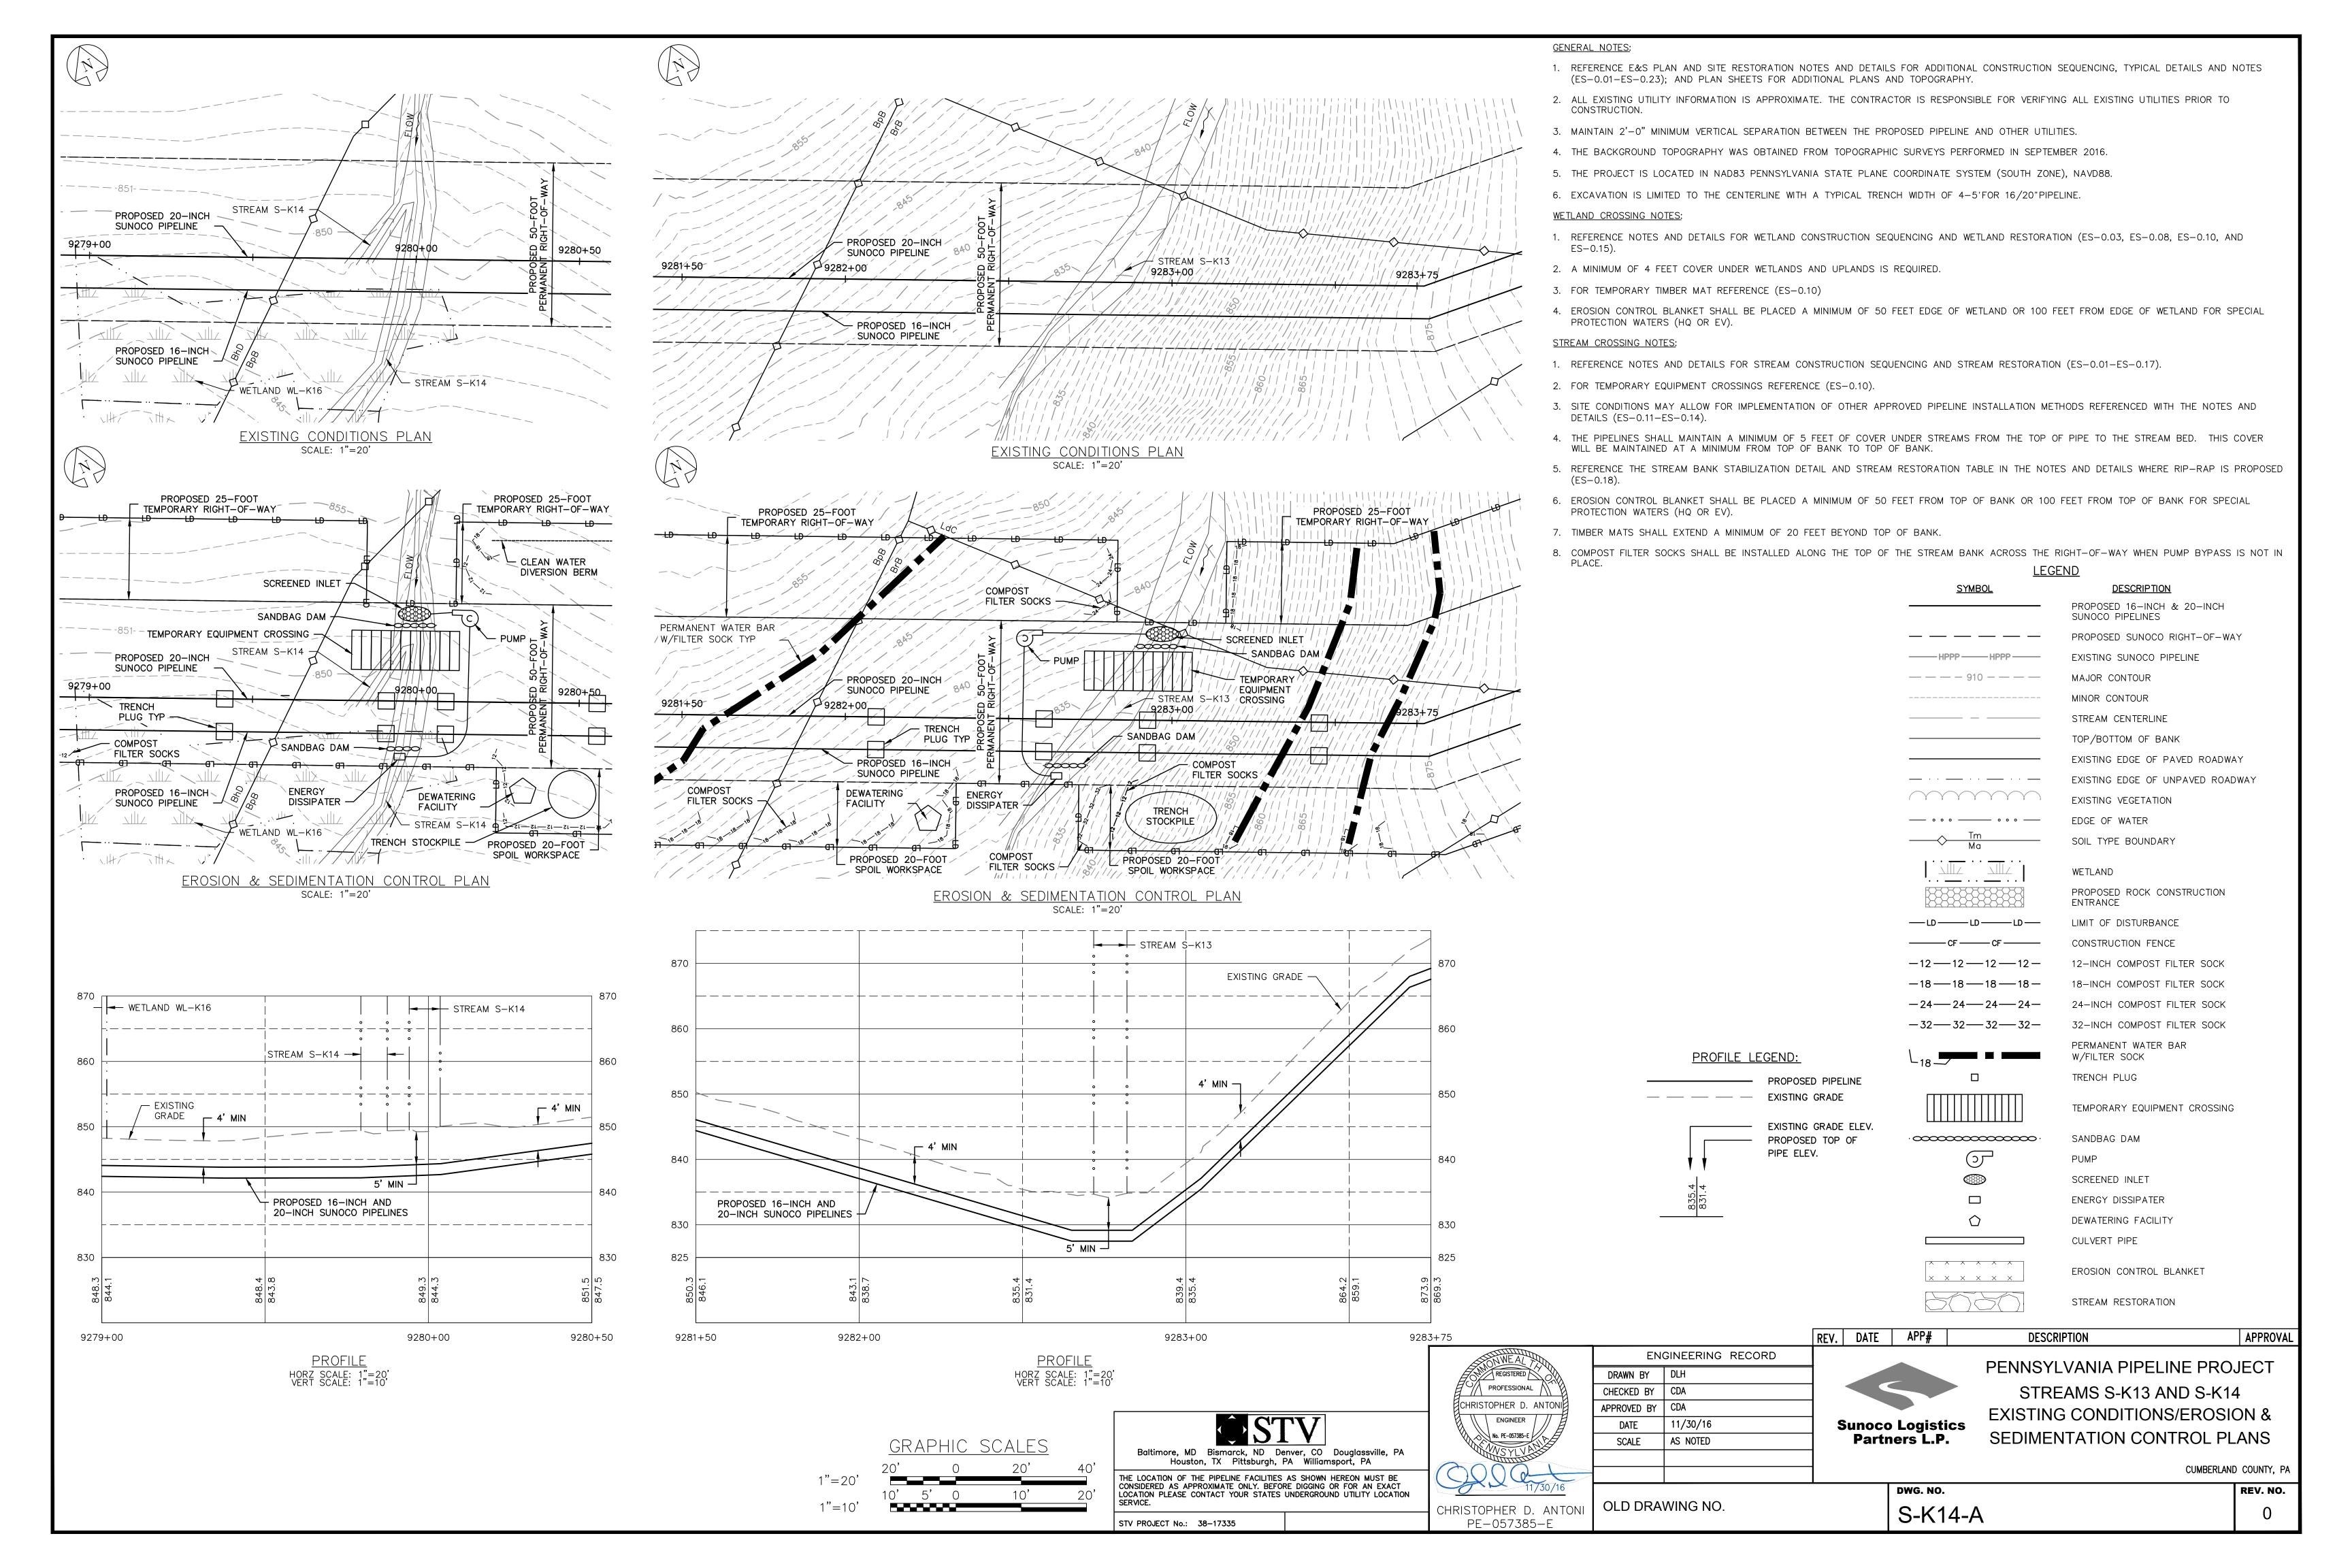

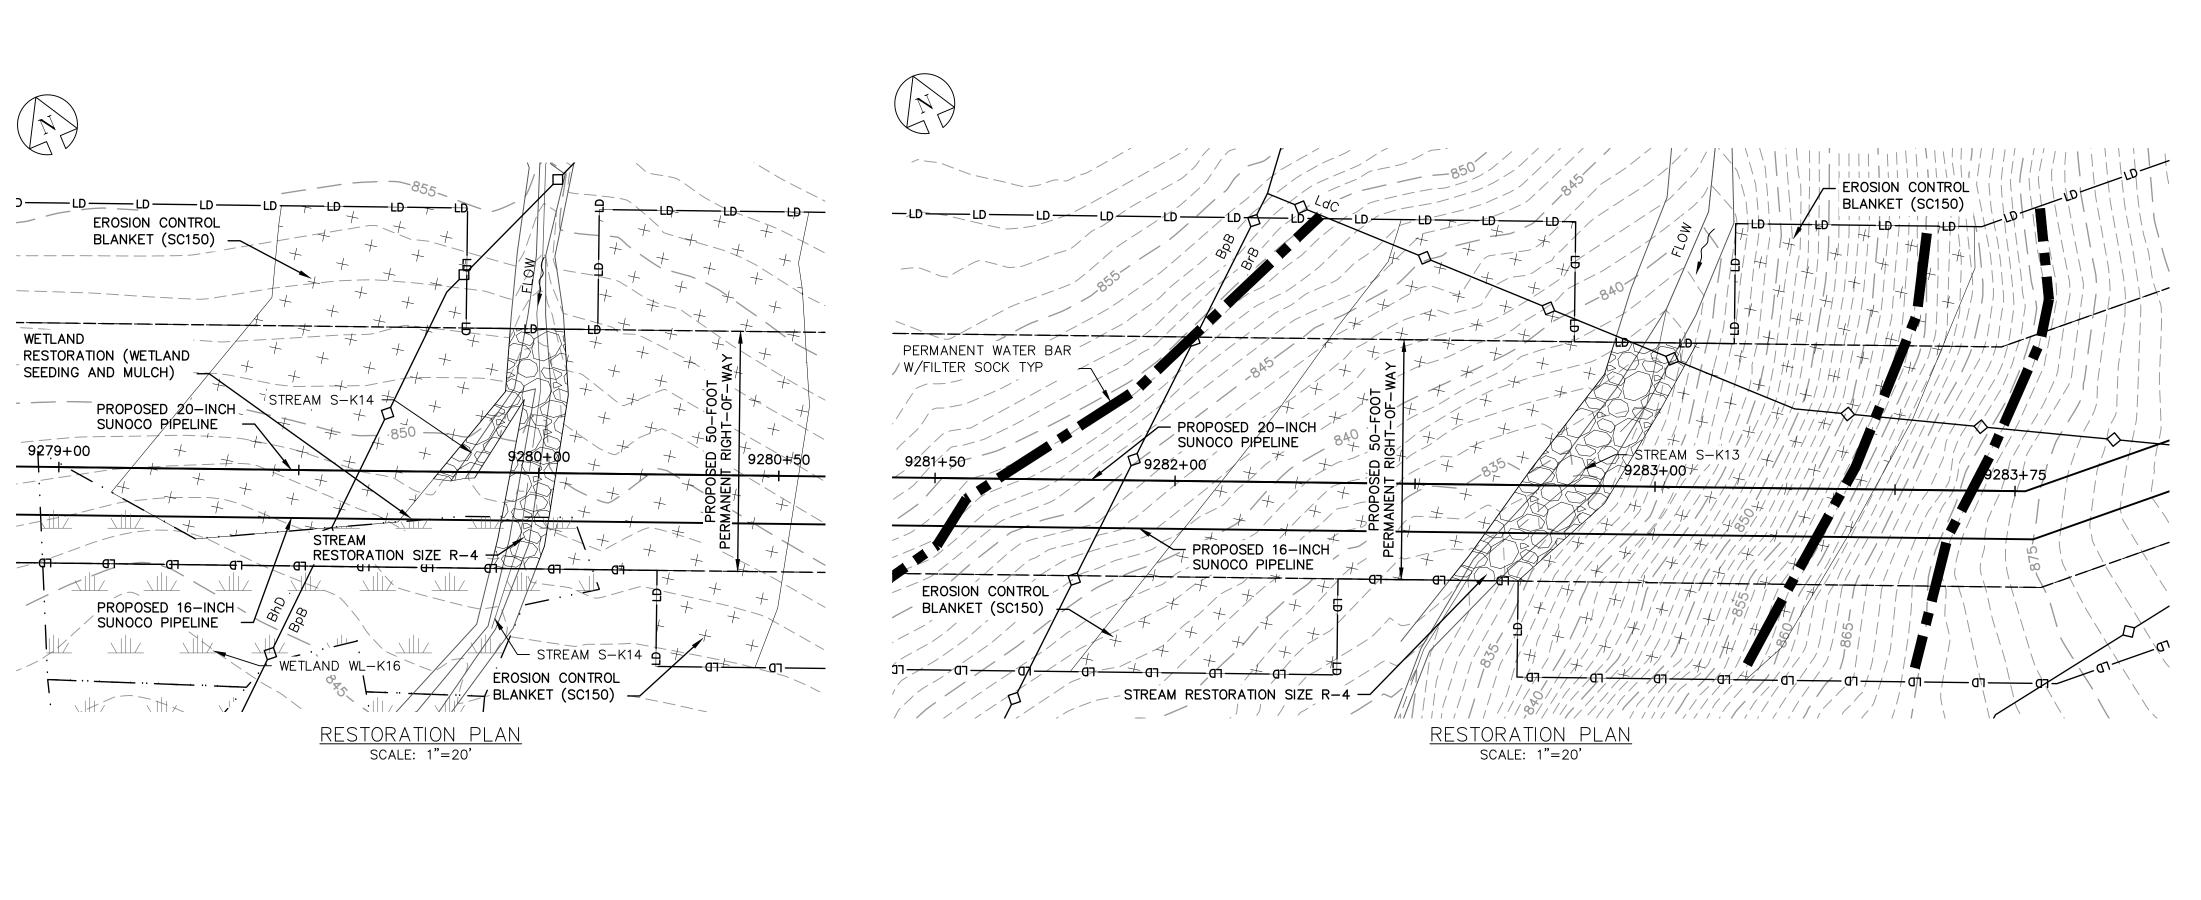

H← WETLAND WL-K16

GRADE

**EROSION CONTROL** 

BLANKET (SC150)

860

840

830

9279+00

STREAM S-K14

STREAM

RESTORATION

SIZE R-4 TYP

- EROSION CONTROL

BLANKET (SC150)

840

9280+50

STREAM S-K14 -

- PROPOSED 16-INCH AND

20-INCH SUNOCO PIPELINES

RESTORED GRADE PROFILE

HORZ SCALE: 1"=20'
VERT SCALE: 1"=10'

5' MIN —

9280+00

### STREAM S-K13 EXISTING GRADE -**EROSION CONTROL** BLANKET (SC150) EROSION CONTROL BLANKET (SC150) 840 PROPOSED 16-INCH AND 20-INCH SUNOCO PIPELINES + 830 **RESTORATION** SIZE R-4 825 9281 + 509282+00 9283+00 9283+75 RESTORED GRADE PROFILE HORZ SCALE: 1"=20' VERT SCALE: 1"=10'

### **GENERAL NOTES:**

- 1. REFERENCE E&S PLAN AND SITE RESTORATION NOTES AND DETAILS FOR ADDITIONAL CONSTRUCTION SEQUENCING, TYPICAL DETAILS AND NOTES (ES-0.01-ES-0.23); AND PLAN SHEETS FOR ADDITIONAL PLANS AND TOPOGRAPHY.
- 2. ALL EXISTING UTILITY INFORMATION IS APPROXIMATE. THE CONTRACTOR IS RESPONSIBLE FOR VERIFYING ALL EXISTING UTILITIES PRIOR TO CONSTRUCTION.
- 3. MAINTAIN 2'-0" MINIMUM VERTICAL SEPARATION BETWEEN THE PROPOSED PIPELINE AND OTHER UTILITIES.
- 4. THE BACKGROUND TOPOGRAPHY WAS OBTAINED FROM TOPOGRAPHIC SURVEYS PERFORMED IN SEPTEMBER 2016.
- 5. THE PROJECT IS LOCATED IN NAD83 PENNSYLVANIA STATE PLANE COORDINATE SYSTEM (SOUTH ZONE), NAVD88.
- 6. EXCAVATION IS LIMITED TO THE CENTERLINE WITH A TYPICAL TRENCH WIDTH OF 4-5'FOR 16/20"PIPELINE.

### WETLAND CROSSING NOTES:

- 1. REFERENCE NOTES AND DETAILS FOR WETLAND CONSTRUCTION SEQUENCING AND WETLAND RESTORATION (ES-0.03, ES-0.08, ES-0.10, AND ES-0.15).
- 2. A MINIMUM OF 4 FEET COVER UNDER WETLANDS AND UPLANDS IS REQUIRED.
- 3. FOR TEMPORARY TIMBER MAT REFERENCE (ES-0.10)
- 4. EROSION CONTROL BLANKET SHALL BE PLACED A MINIMUM OF 50 FEET EDGE OF WETLAND OR 100 FEET FROM EDGE OF WETLAND FOR SPECIAL PROTECTION WATERS (HQ OR EV).

### STREAM CROSSING NOTES:


- REFERENCE NOTES AND DETAILS FOR STREAM CONSTRUCTION SEQUENCING AND STREAM RESTORATION (ES-0.01-ES-0.17).
- 2. FOR TEMPORARY EQUIPMENT CROSSINGS REFERENCE (ES-0.10).
- 3. SITE CONDITIONS MAY ALLOW FOR IMPLEMENTATION OF OTHER APPROVED PIPELINE INSTALLATION METHODS REFERENCED WITH THE NOTES AND DETAILS (ES-0.11-ES-0.14).
- 4. THE PIPELINES SHALL MAINTAIN A MINIMUM OF 5 FEET OF COVER UNDER STREAMS FROM THE TOP OF PIPE TO THE STREAM BED. THIS COVER WILL BE MAINTAINED AT A MINIMUM FROM TOP OF BANK TO TOP OF BANK.
- REFERENCE THE STREAM BANK STABILIZATION DETAIL AND STREAM RESTORATION TABLE IN THE NOTES AND DETAILS WHERE RIP-RAP IS PROPOSED (ES-0.18).
- EROSION CONTROL BLANKET SHALL BE PLACED A MINIMUM OF 50 FEET FROM TOP OF BANK OR 100 FEET FROM TOP OF BANK FOR SPECIAL PROTECTION WATERS (HQ OR EV).
- 7. TIMBER MATS SHALL EXTEND A MINIMUM OF 20 FEET BEYOND TOP OF BANK.


PROFILE LEGEND:


EXISTING GRADE


PIPE ELEV.

8. COMPOST FILTER SOCKS SHALL BE INSTALLED ALONG THE TOP OF THE STREAM BANK ACROSS THE RIGHT-OF-WAY WHEN PUMP BYPASS IS NOT IN

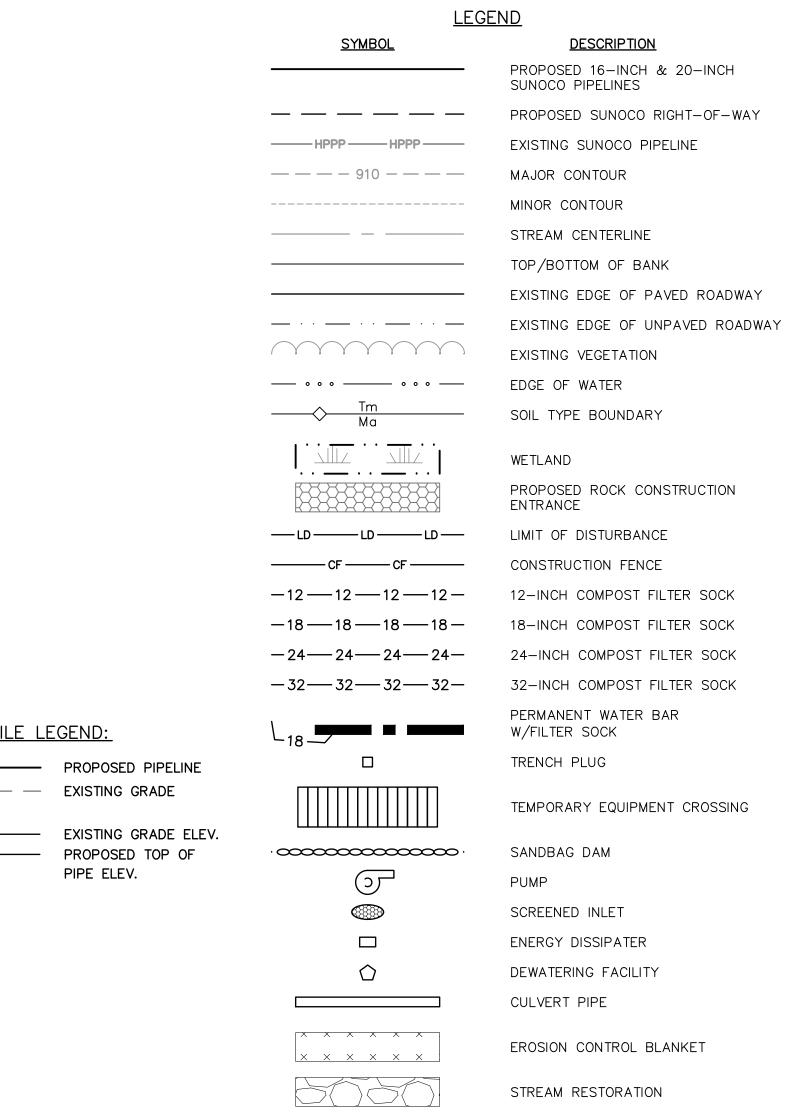

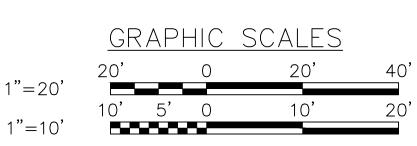

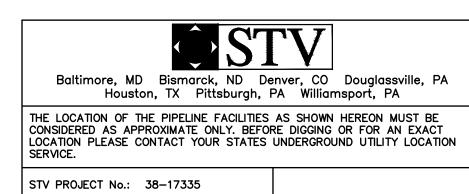

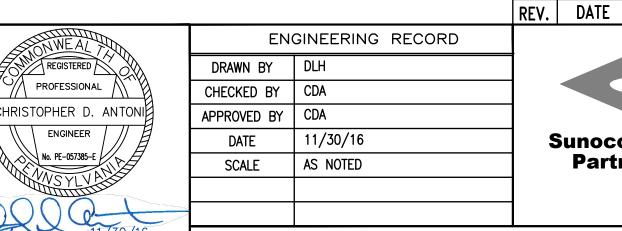

OLD DRAWING NO.

REGISTERED

ENGINEER

CHRISTOPHER D. ANTONI

PE-057385-E



APPROVAL PENNSYLVANIA PIPELINE PROJECT STREAMS S-K13 AND S-K14 **RESTORATION PLAN** 


CUMBERLAND COUNTY, PA


DWG. NO. S-K14-B


APP#


REV. NO.


**DESCRIPTION** 

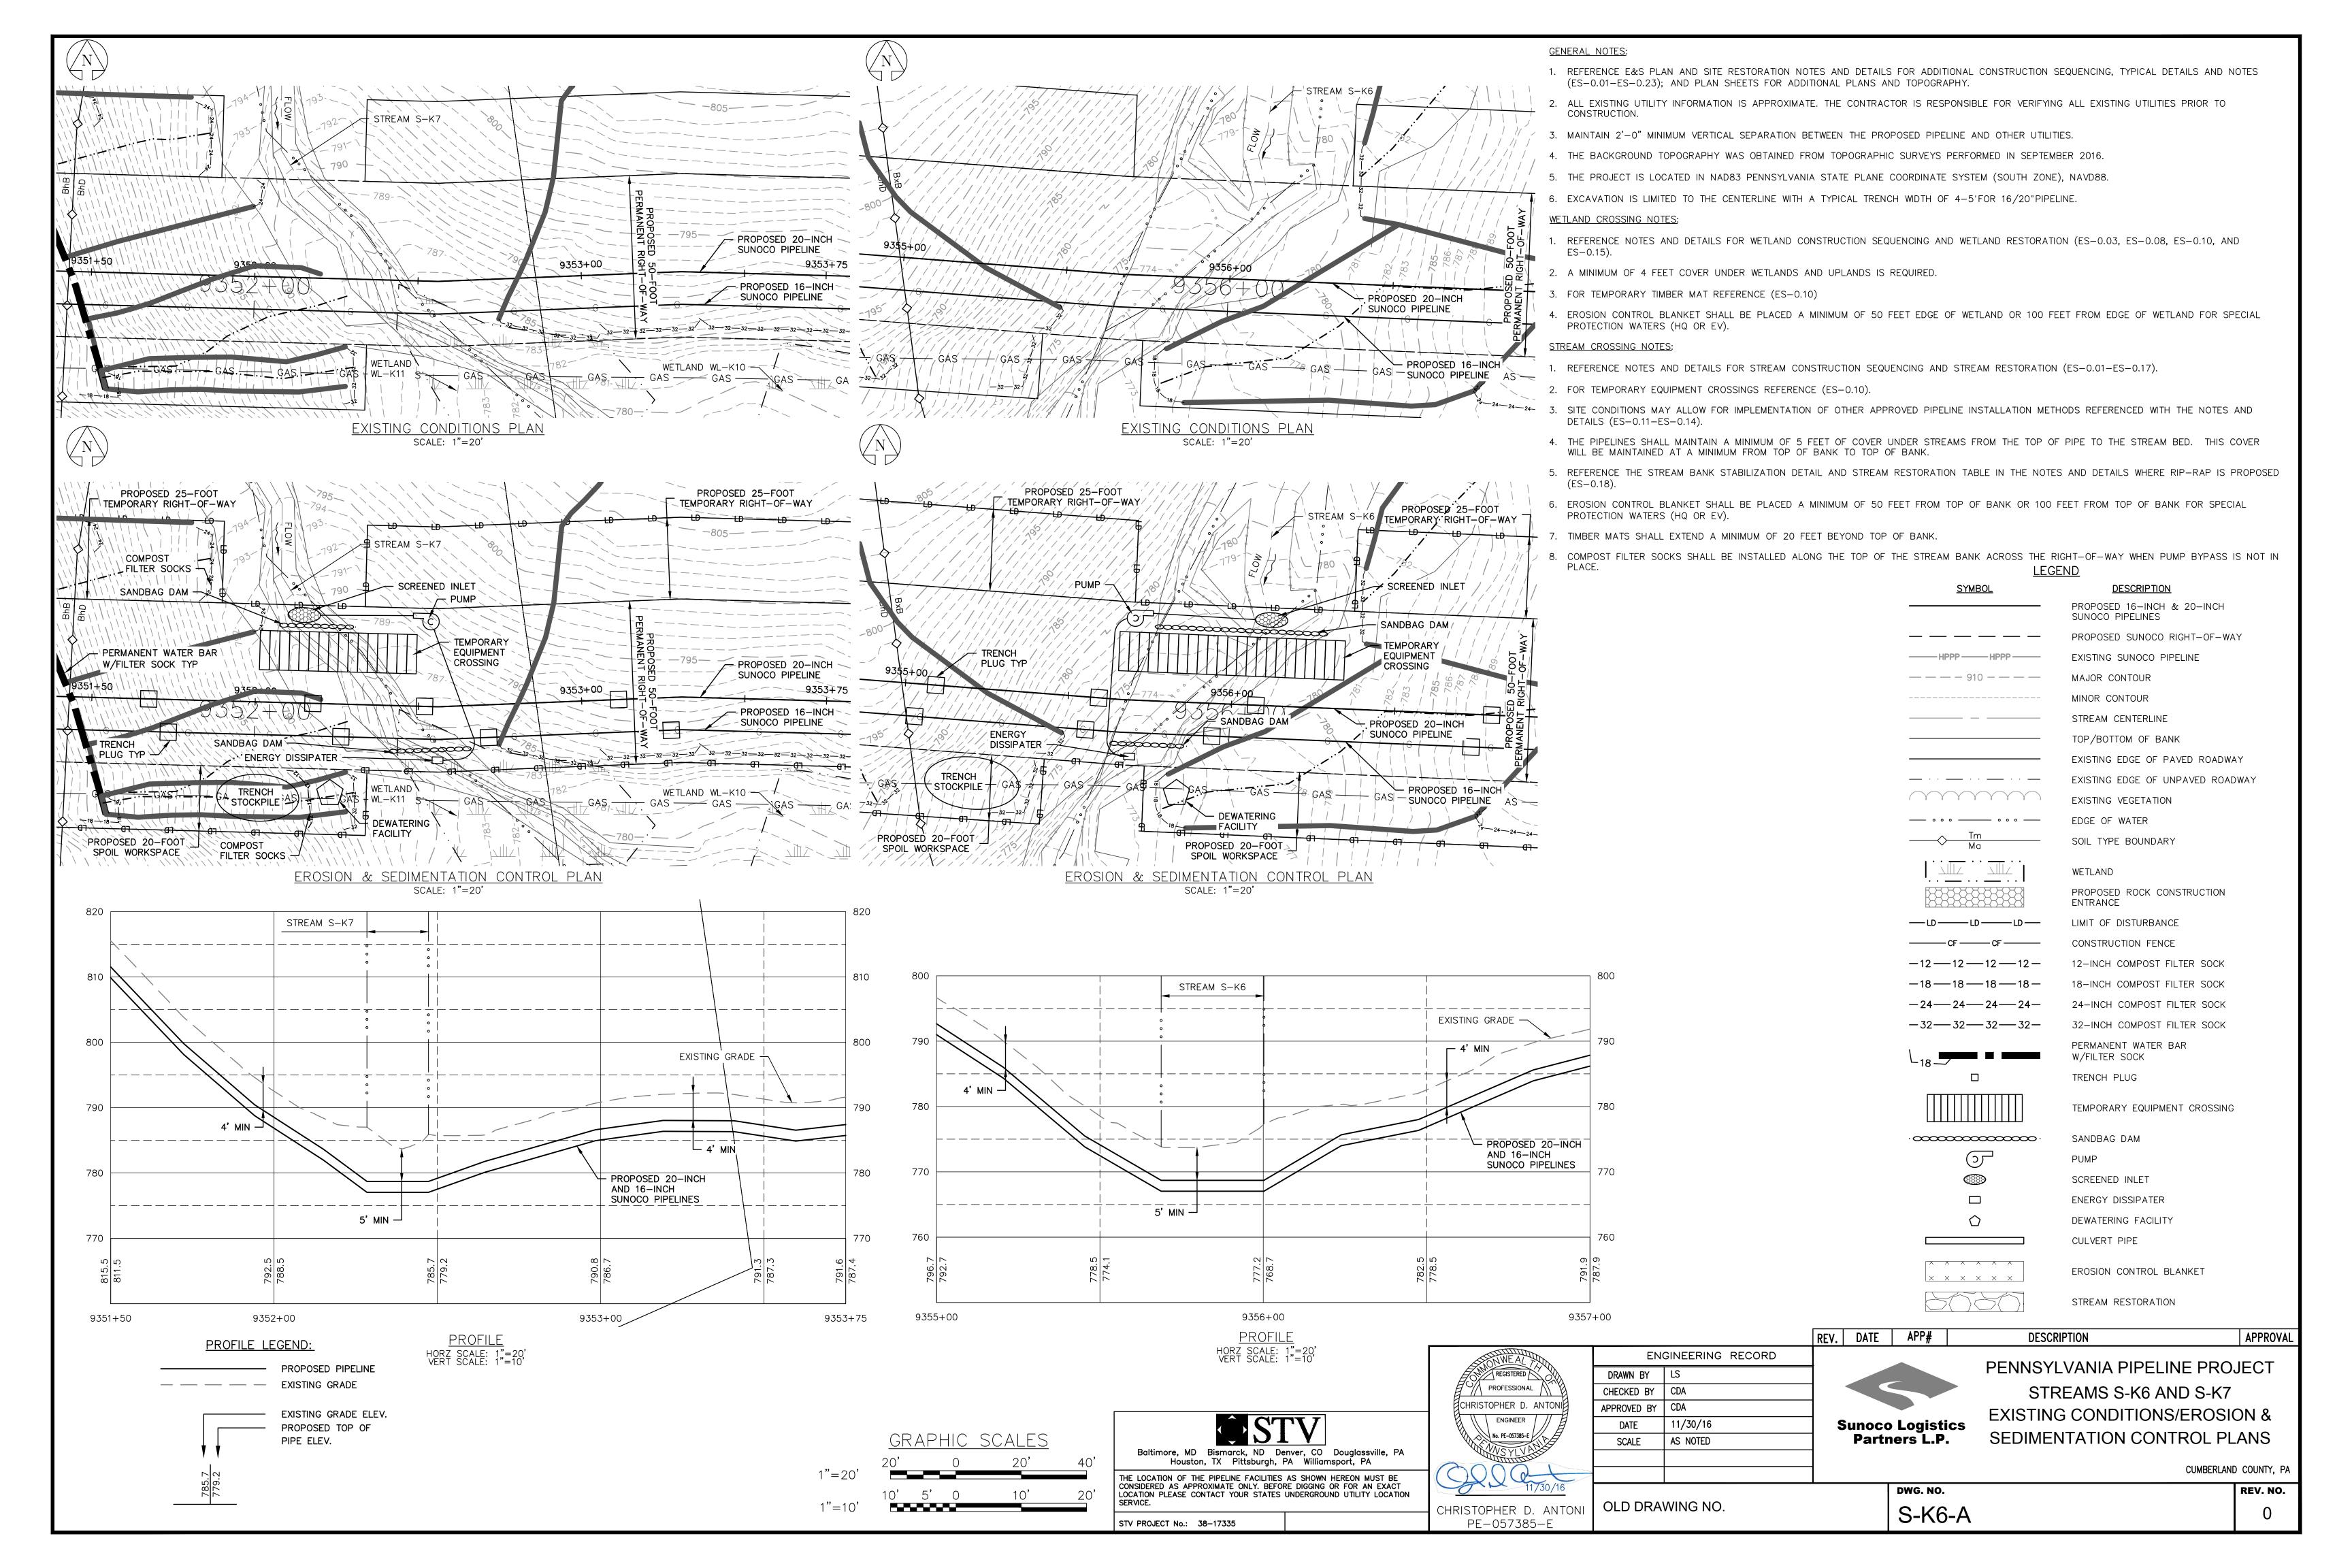

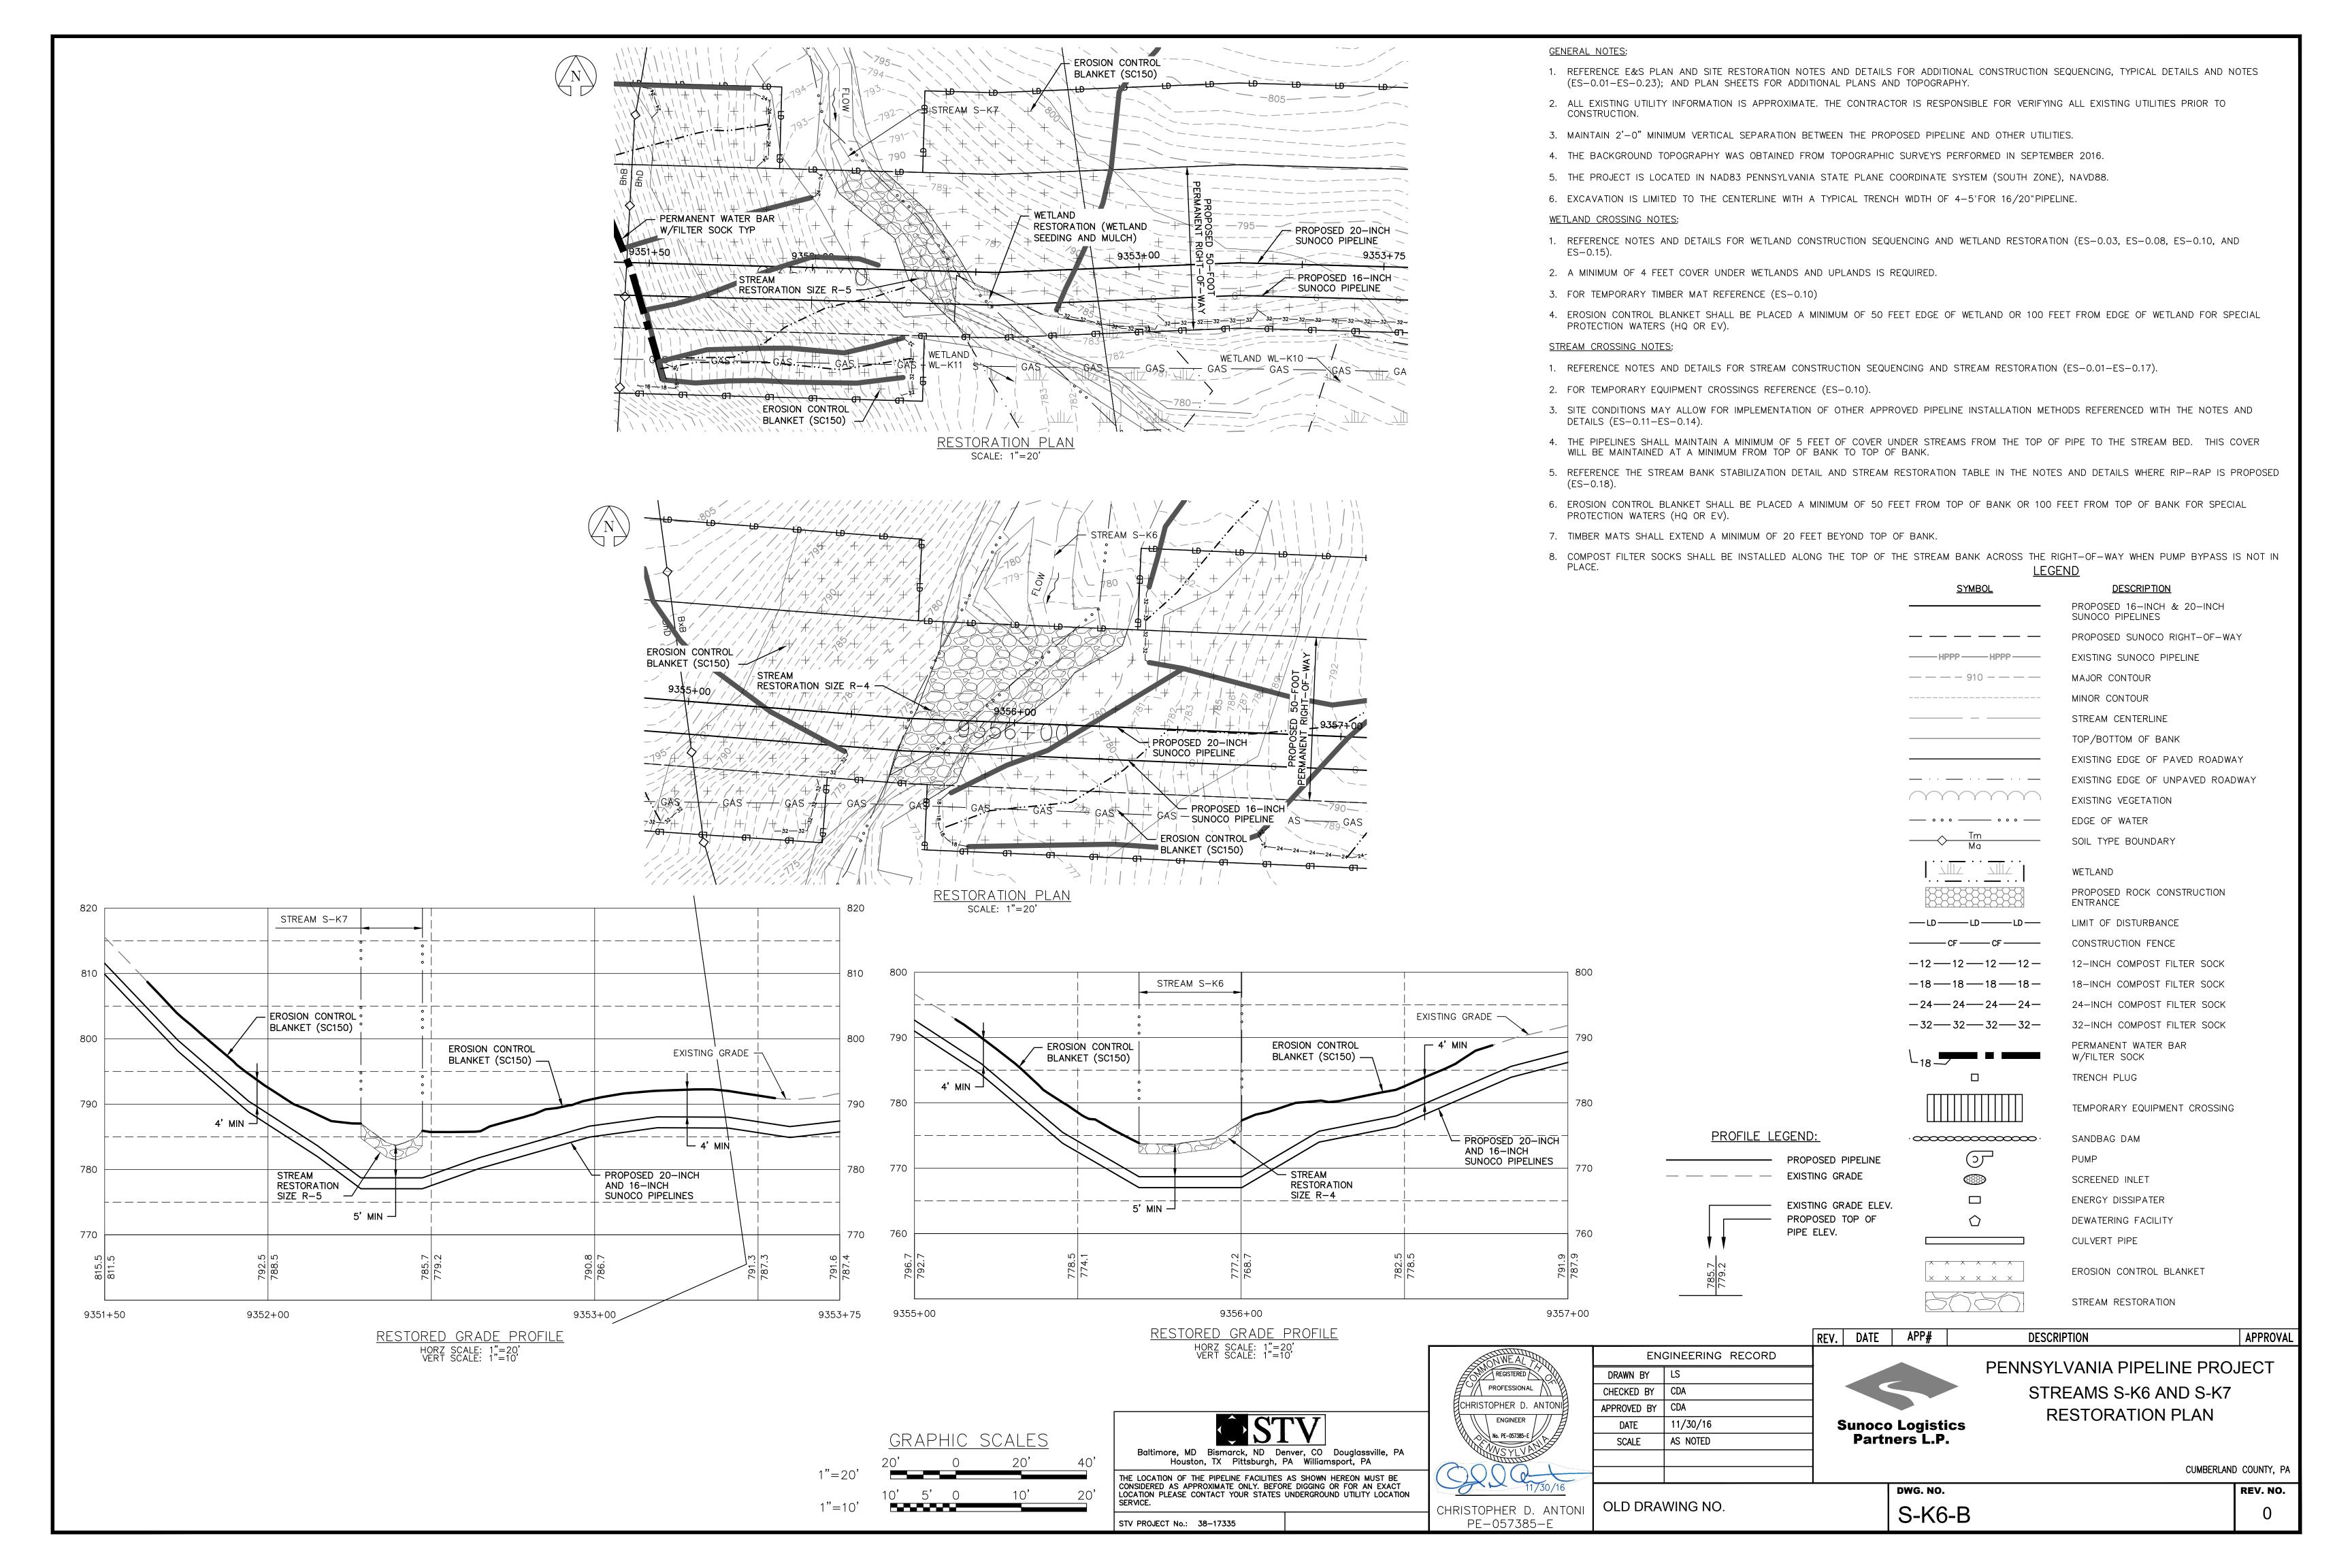


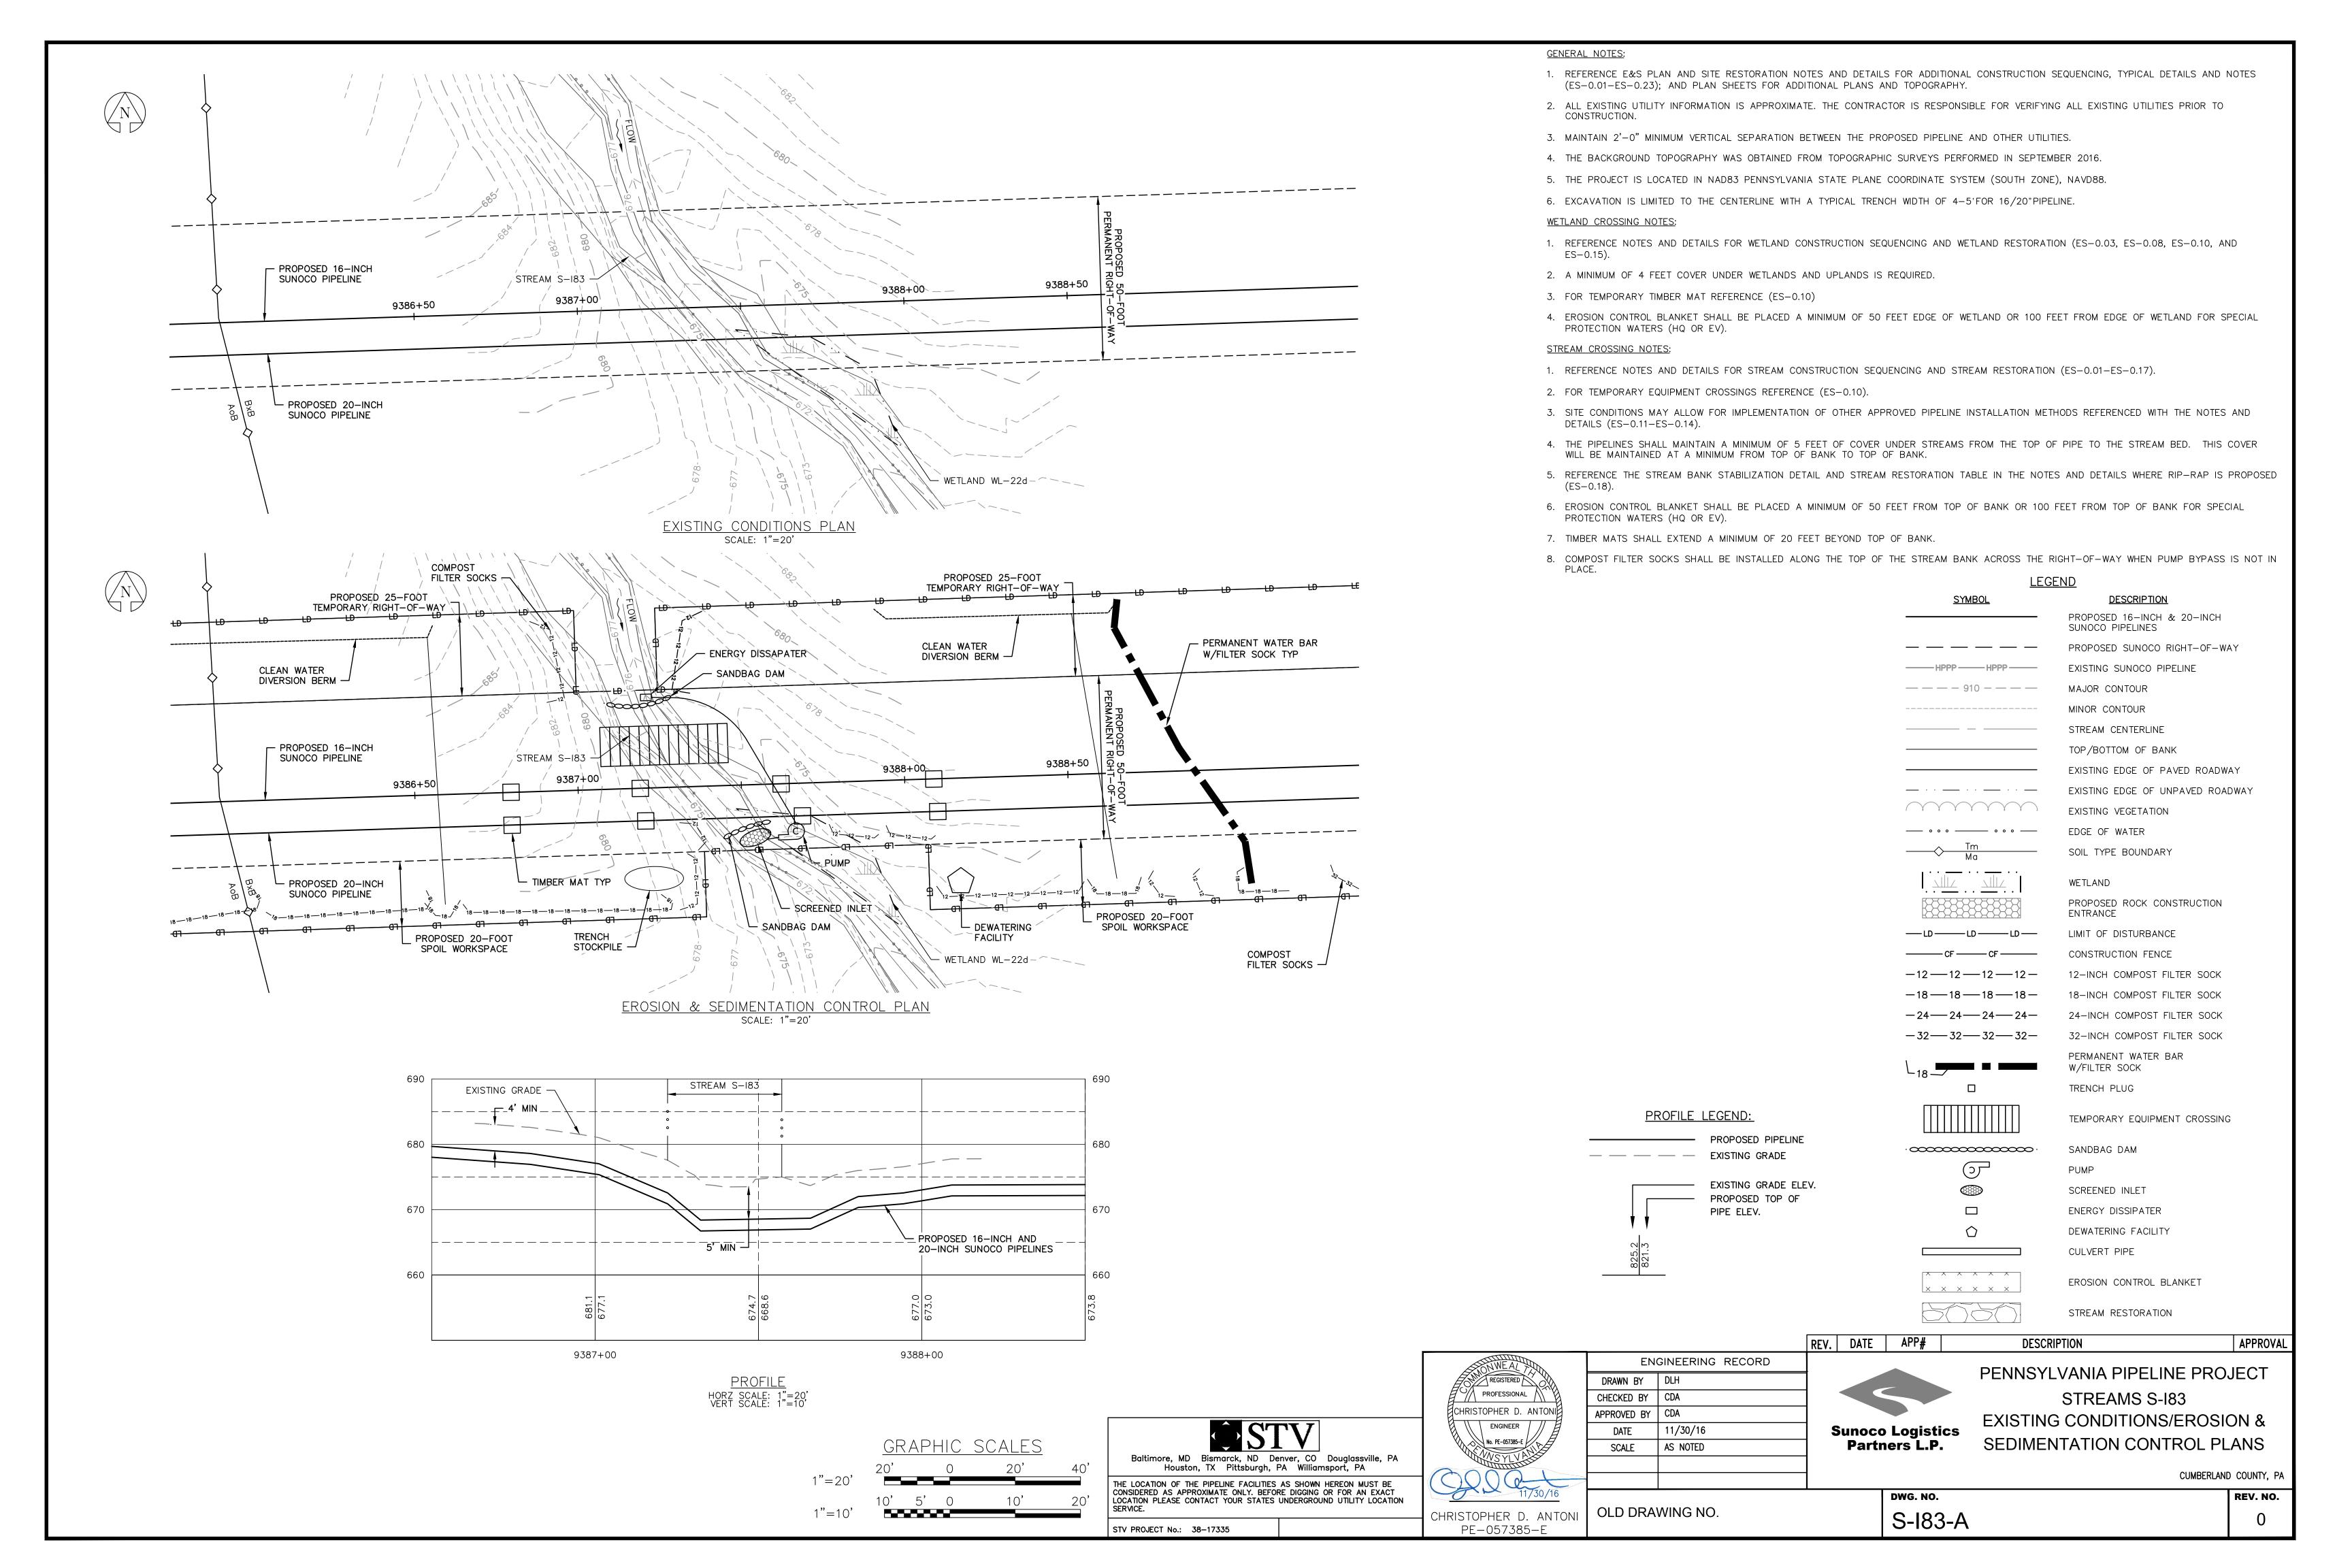


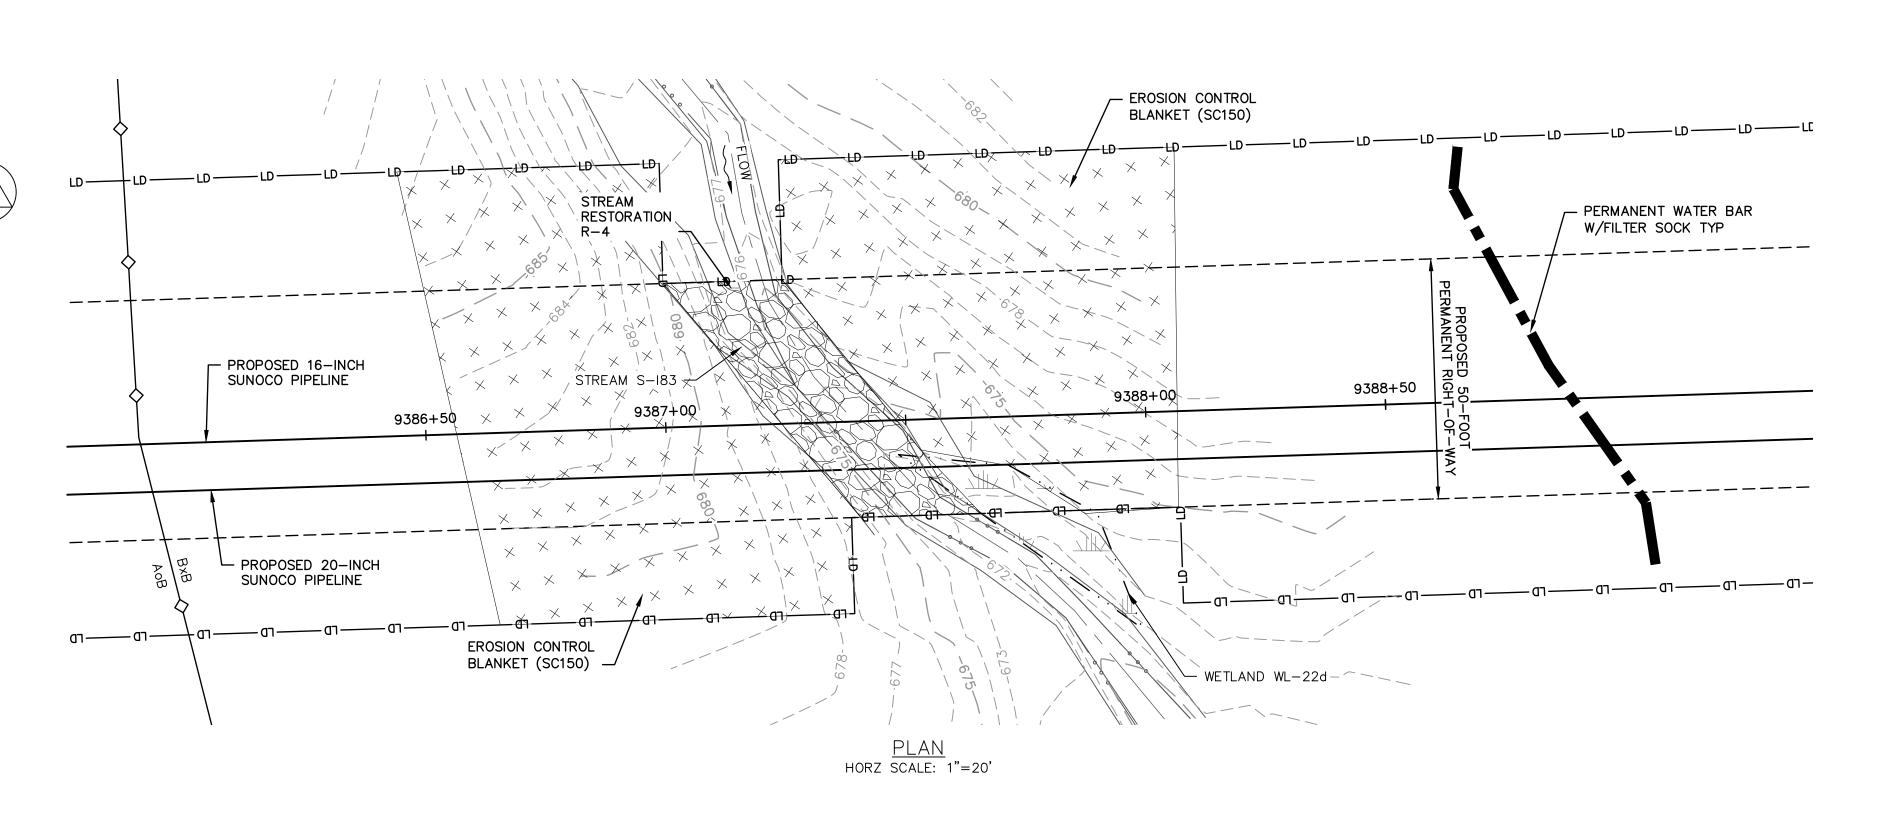

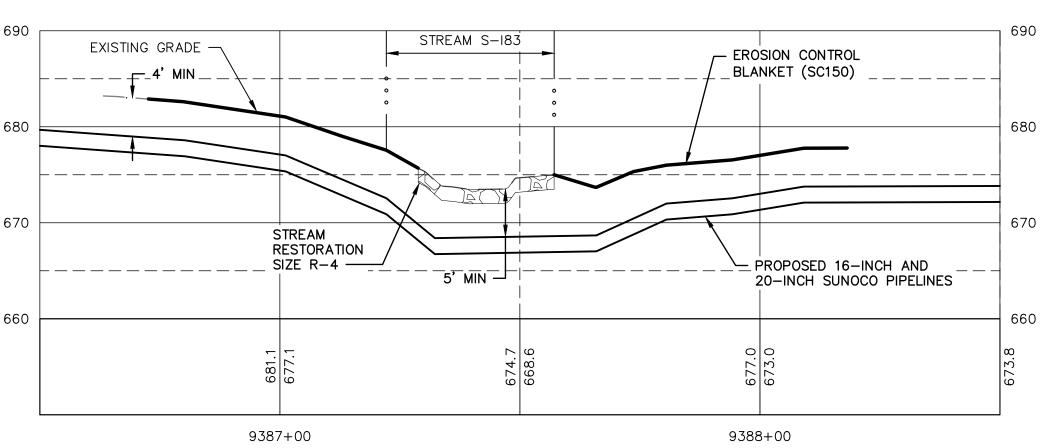

RESTORED GRADE PROFILE HORZ SCALE: 1"=20' VERT SCALE: 1"=10'

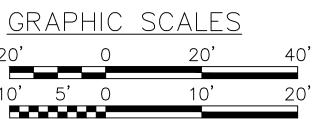

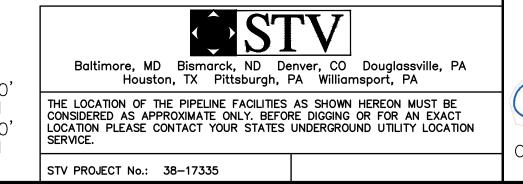


- 1. REFERENCE E&S PLAN AND SITE RESTORATION NOTES AND DETAILS FOR ADDITIONAL CONSTRUCTION SEQUENCING, TYPICAL DETAILS AND NOTES (ES-0.01-ES-0.23); AND PLAN SHEETS FOR ADDITIONAL PLANS AND TOPOGRAPHY.
- 2. ALL EXISTING UTILITY INFORMATION IS APPROXIMATE. THE CONTRACTOR IS RESPONSIBLE FOR VERIFYING ALL EXISTING UTILITIES PRIOR TO CONSTRUCTION.
- 3. MAINTAIN 2'-0" MINIMUM VERTICAL SEPARATION BETWEEN THE PROPOSED PIPELINE AND OTHER UTILITIES.
- 4. THE BACKGROUND TOPOGRAPHY WAS OBTAINED FROM TOPOGRAPHIC SURVEYS PERFORMED IN SEPTEMBER 2016.
- 5. THE PROJECT IS LOCATED IN NAD83 PENNSYLVANIA STATE PLANE COORDINATE SYSTEM (SOUTH ZONE), NAVD88.
- 6. EXCAVATION IS LIMITED TO THE CENTERLINE WITH A TYPICAL TRENCH WIDTH OF 4-5'FOR 16/20"PIPELINE.


### WETLAND CROSSING NOTES:

- 1. REFERENCE NOTES AND DETAILS FOR WETLAND CONSTRUCTION SEQUENCING AND WETLAND RESTORATION (ES-0.03, ES-0.08, ES-0.10, AND ES-0.15).
- 2. A MINIMUM OF 4 FEET COVER UNDER WETLANDS AND UPLANDS IS REQUIRED.
- 3. FOR TEMPORARY TIMBER MAT REFERENCE (ES-0.10)
- 4. EROSION CONTROL BLANKET SHALL BE PLACED A MINIMUM OF 50 FEET EDGE OF WETLAND OR 100 FEET FROM EDGE OF WETLAND FOR SPECIAL PROTECTION WATERS (HQ OR EV).

### STREAM CROSSING NOTES:

- 1. REFERENCE NOTES AND DETAILS FOR STREAM CONSTRUCTION SEQUENCING AND STREAM RESTORATION (ES-0.01-ES-0.17).
- 2. FOR TEMPORARY EQUIPMENT CROSSINGS REFERENCE (ES-0.10).
- 3. SITE CONDITIONS MAY ALLOW FOR IMPLEMENTATION OF OTHER APPROVED PIPELINE INSTALLATION METHODS REFERENCED WITH THE NOTES AND DETAILS (ES-0.11-ES-0.14).
- 4. THE PIPELINES SHALL MAINTAIN A MINIMUM OF 5 FEET OF COVER UNDER STREAMS FROM THE TOP OF PIPE TO THE STREAM BED. THIS COVER WILL BE MAINTAINED AT A MINIMUM FROM TOP OF BANK TO TOP OF BANK.
- 5. REFERENCE THE STREAM BANK STABILIZATION DETAIL AND STREAM RESTORATION TABLE IN THE NOTES AND DETAILS WHERE RIP-RAP IS PROPOSED (ES-0.18).
- 6. EROSION CONTROL BLANKET SHALL BE PLACED A MINIMUM OF 50 FEET FROM TOP OF BANK OR 100 FEET FROM TOP OF BANK FOR SPECIAL PROTECTION WATERS (HQ OR EV).
- 7. TIMBER MATS SHALL EXTEND A MINIMUM OF 20 FEET BEYOND TOP OF BANK.
- 8. COMPOST FILTER SOCKS SHALL BE INSTALLED ALONG THE TOP OF THE STREAM BANK ACROSS THE RIGHT-OF-WAY WHEN PUMP BYPASS IS NOT IN PLACE.

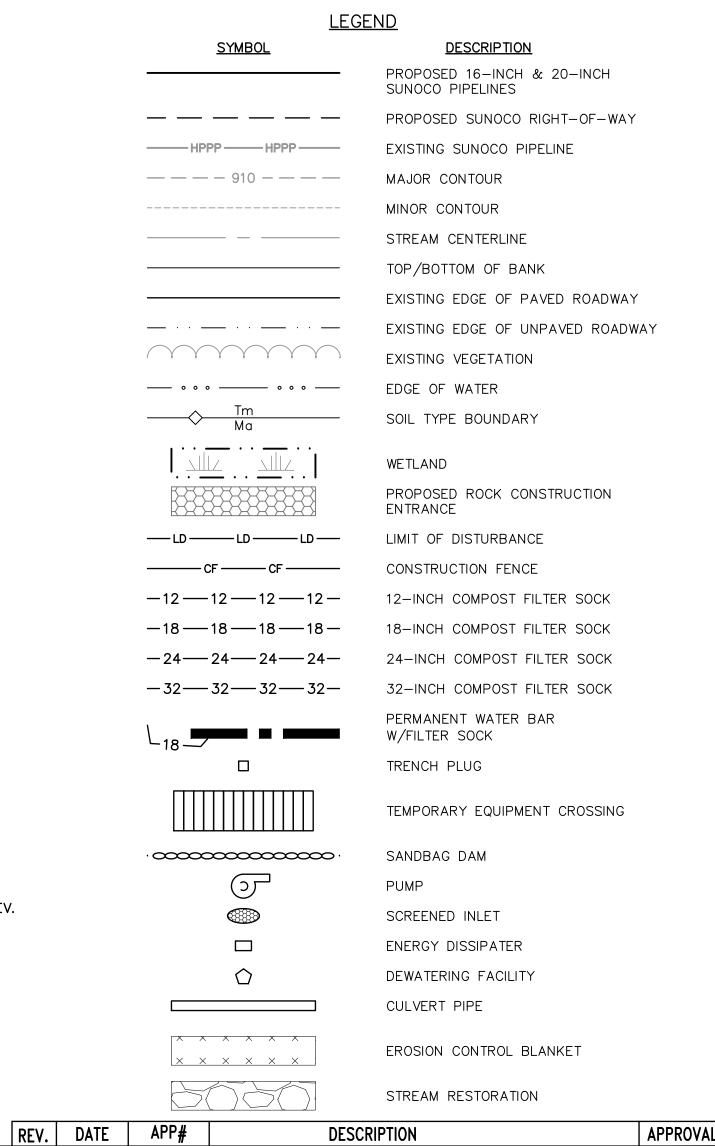

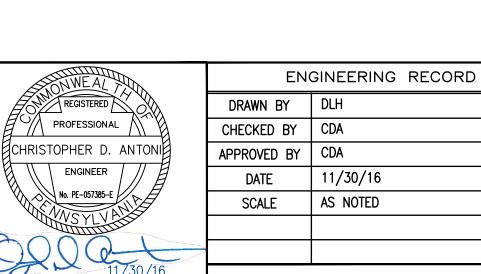

PENNSYLVANIA PIPELINE PROJECT STREAMS S-183 RESTORATION PLAN **Sunoco Logistics** Partners L.P.

CUMBERLAND COUNTY, PA

DWG. NO. REV. NO. S-183-B

CHRISTOPHER D. ANTONI PE-057385-E

OLD DRAWING NO.

PROFILE LEGEND:


— — — EXISTING GRADE

PROPOSED PIPELINE


PIPE ELEV.

EXISTING GRADE ELEV.

PROPOSED TOP OF

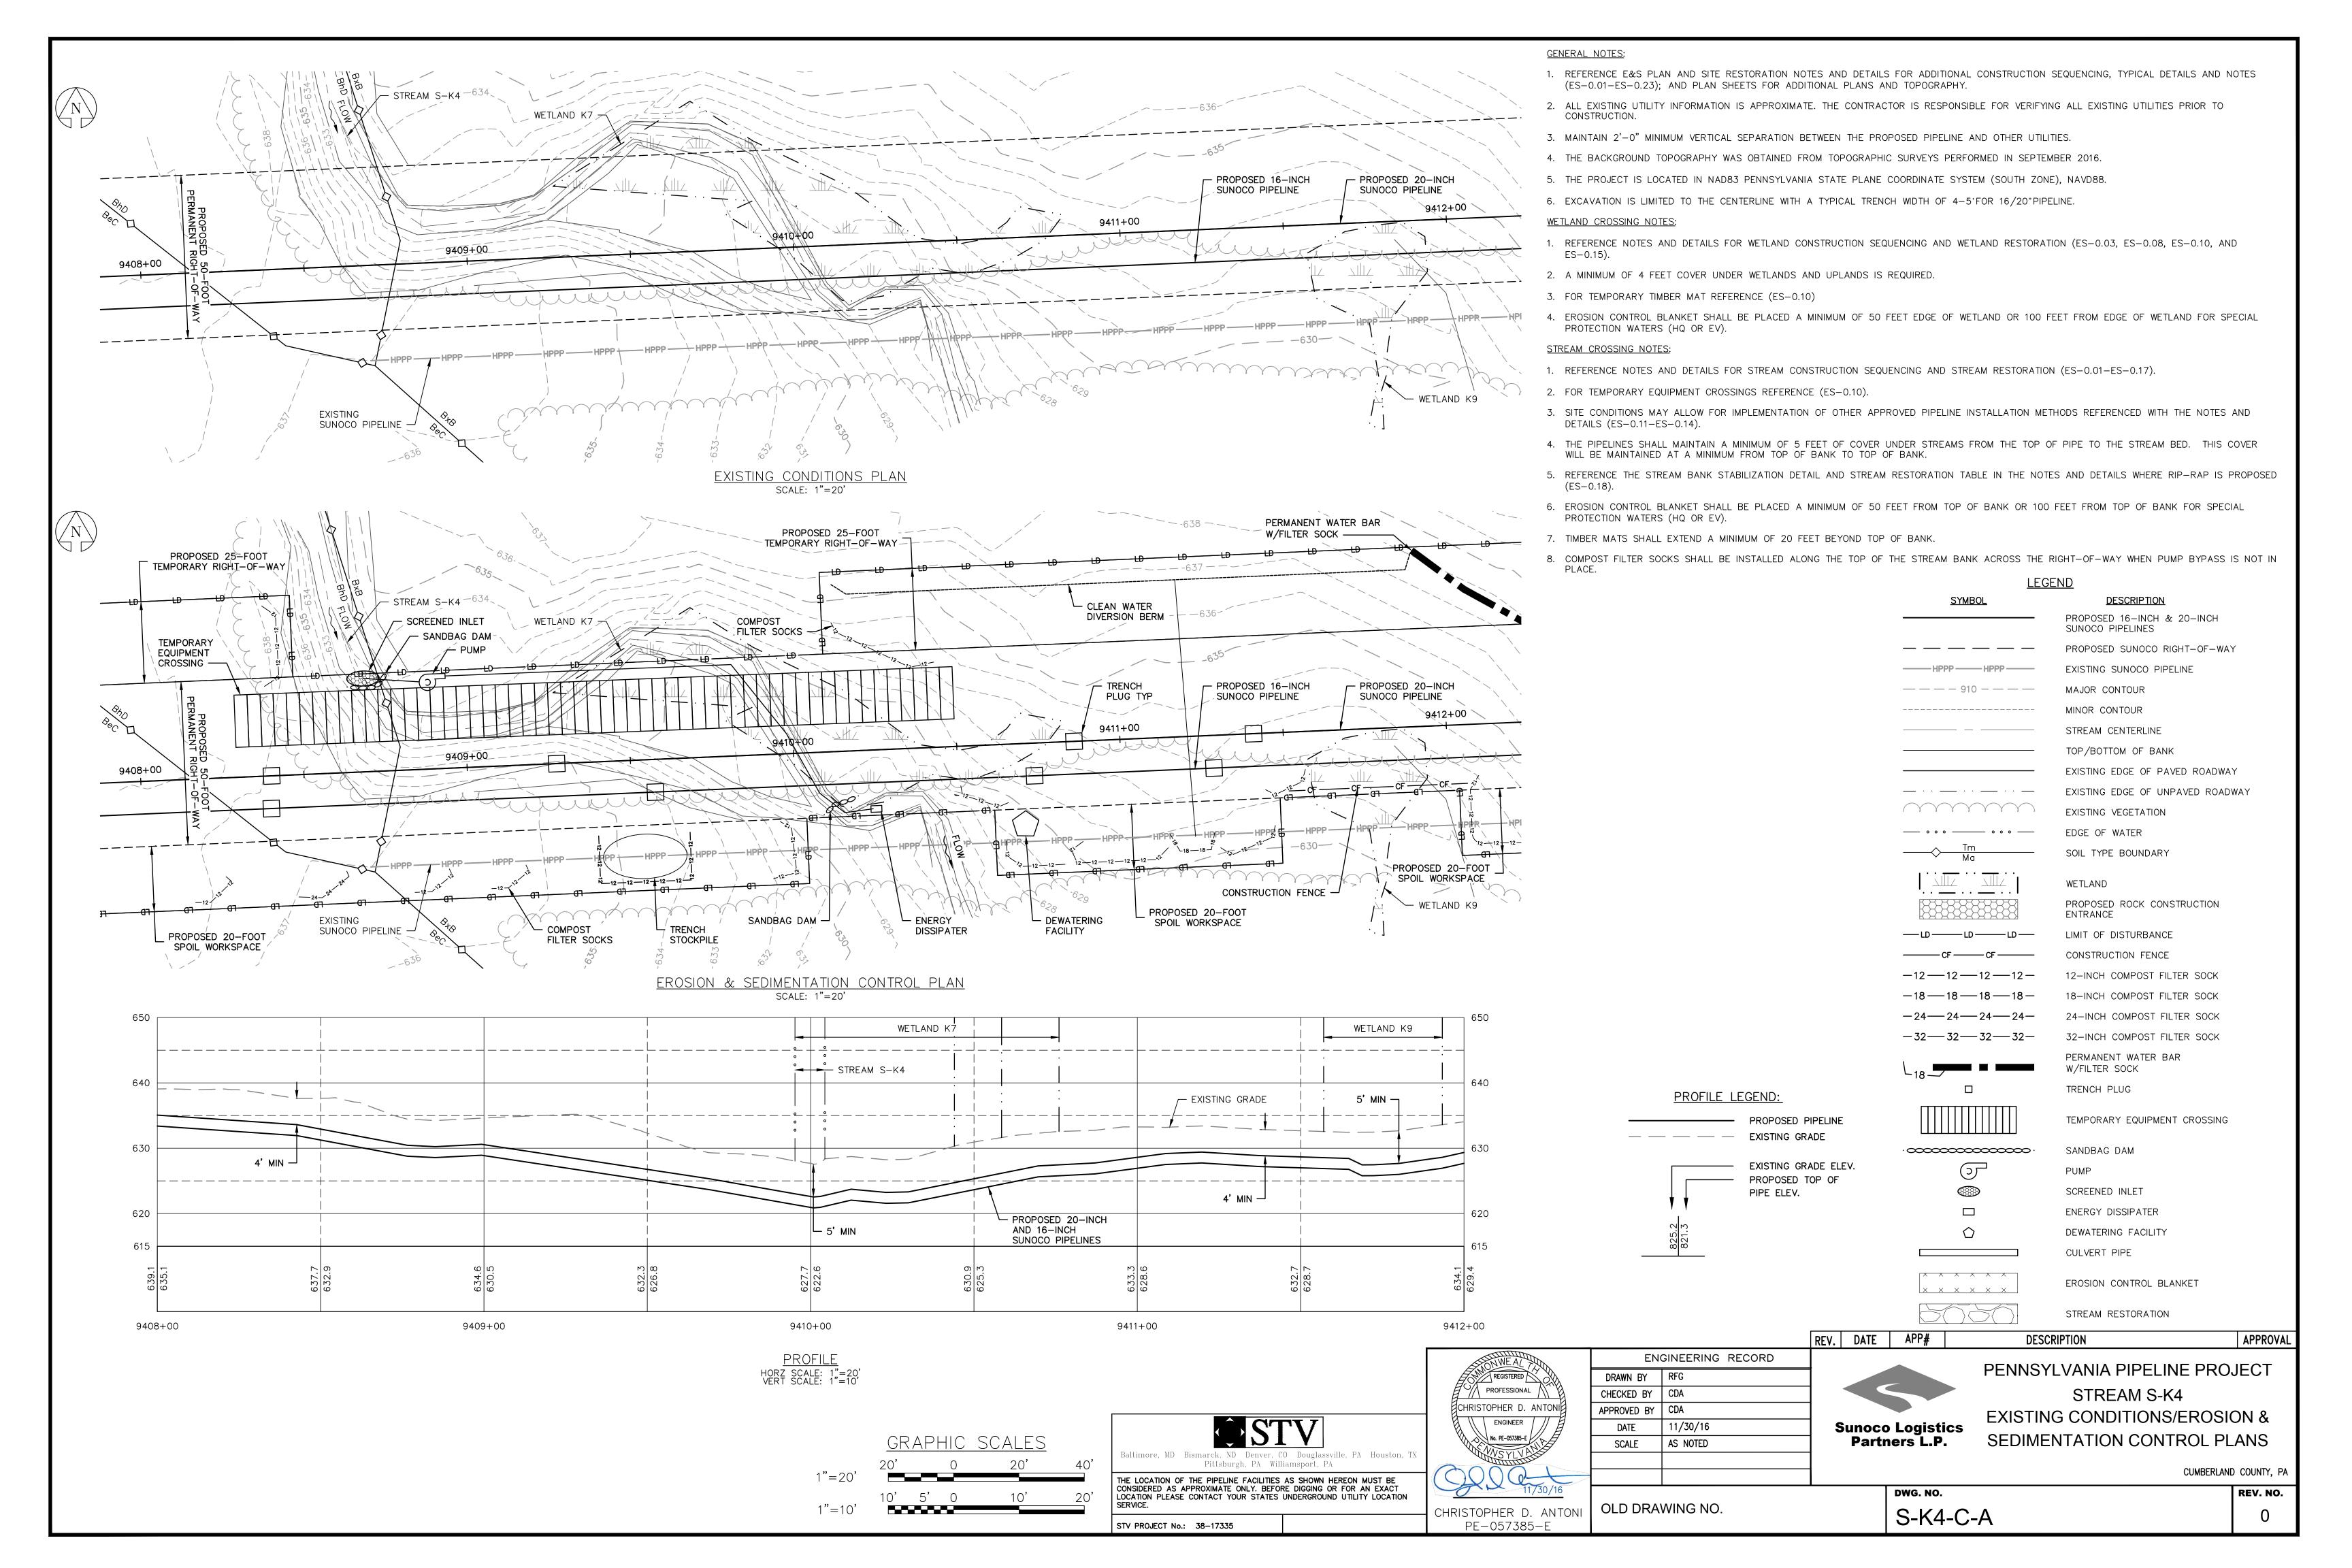

### PERMANENT WATER BAR EROSION CONTROL W/FILTER SOCK -BLANKET (SC150) EROSION CONTROL - STREAM RESTORATION BLANKET (SC150) - STREAM S-K4 -634 SIZE R-4 WETLAND K7 -STREAM RESTORATION -SIZE R-4 ---WETLAND RESTORATION +(WETLAND SEEDING AND MULCH) - PROPOSED 16-INCH - PROPOSED 20-INCH $^{+}$ SUNOCO PIPELINE SUNOCO PIPELINE 9412+00 + 9411+00 9409+00 9408+00 WETLAND K9 WETLAND RESTORATION EROSION CONTROL (WETLAND SEEDING SUNOCO PIPELINE BLANKET (SC150) AND MULCH) SCALE: 1"=20'

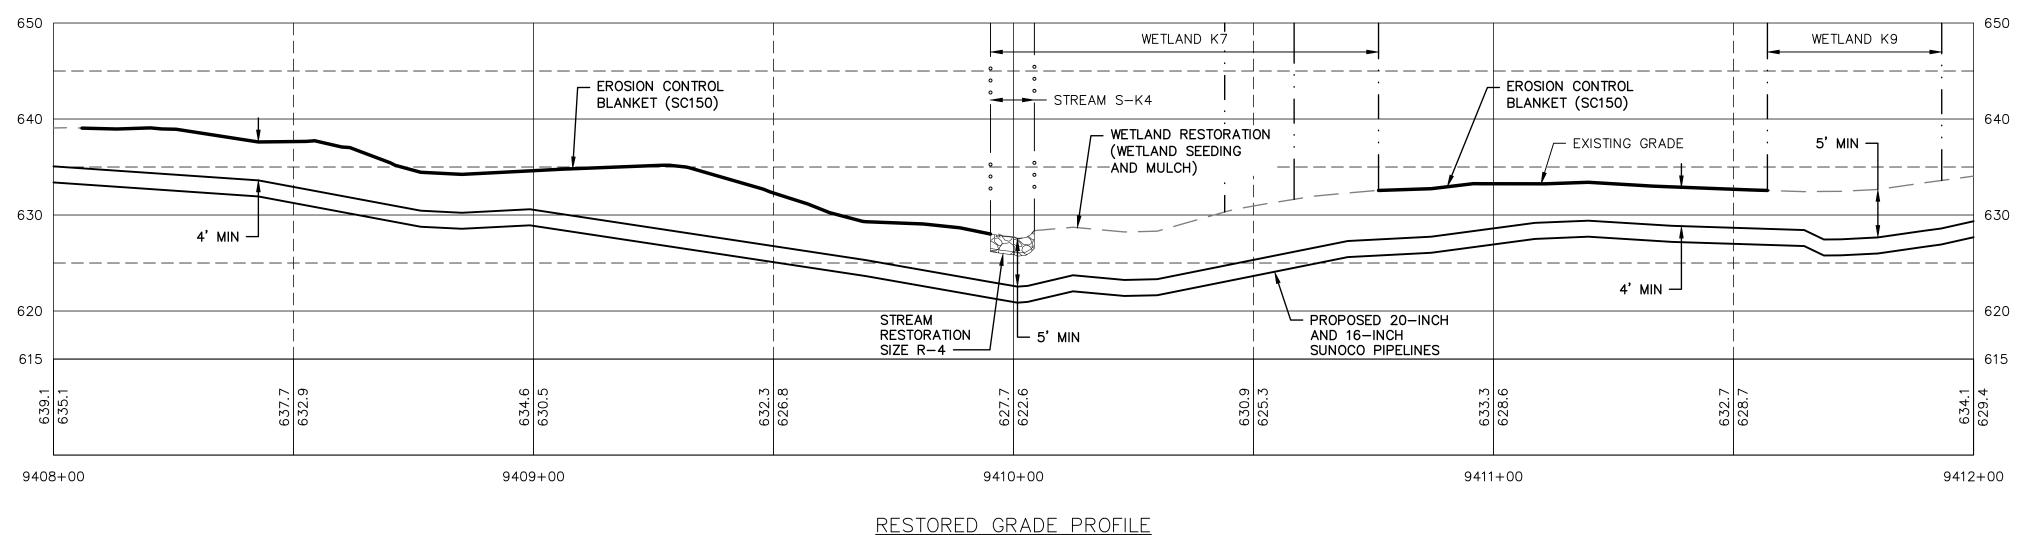

HORZ SCALE: 1"=20' VERT SCALE: 1"=10'

1"=10'

GRAPHIC SCALES

### **GENERAL NOTES:**

- 1. REFERENCE E&S PLAN AND SITE RESTORATION NOTES AND DETAILS FOR ADDITIONAL CONSTRUCTION SEQUENCING, TYPICAL DETAILS AND NOTES (ES-0.01-ES-0.23); AND PLAN SHEETS FOR ADDITIONAL PLANS AND TOPOGRAPHY.
- 2. ALL EXISTING UTILITY INFORMATION IS APPROXIMATE. THE CONTRACTOR IS RESPONSIBLE FOR VERIFYING ALL EXISTING UTILITIES PRIOR TO CONSTRUCTION.
- 3. MAINTAIN 2'-0" MINIMUM VERTICAL SEPARATION BETWEEN THE PROPOSED PIPELINE AND OTHER UTILITIES.
- 4. THE BACKGROUND TOPOGRAPHY WAS OBTAINED FROM TOPOGRAPHIC SURVEYS PERFORMED IN SEPTEMBER 2016.
- 5. THE PROJECT IS LOCATED IN NAD83 PENNSYLVANIA STATE PLANE COORDINATE SYSTEM (SOUTH ZONE), NAVD88.
- 6. EXCAVATION IS LIMITED TO THE CENTERLINE WITH A TYPICAL TRENCH WIDTH OF 4-5'FOR 16/20"PIPELINE.

### WETLAND CROSSING NOTES:

- 1. REFERENCE NOTES AND DETAILS FOR WETLAND CONSTRUCTION SEQUENCING AND WETLAND RESTORATION (ES-0.03, ES-0.08, ES-0.10, AND ES-0.15).
- 2. A MINIMUM OF 4 FEET COVER UNDER WETLANDS AND UPLANDS IS REQUIRED.
- 3. FOR TEMPORARY TIMBER MAT REFERENCE (ES-0.10)
- 4. EROSION CONTROL BLANKET SHALL BE PLACED A MINIMUM OF 50 FEET EDGE OF WETLAND OR 100 FEET FROM EDGE OF WETLAND FOR SPECIAL PROTECTION WATERS (HQ OR EV).

### STREAM CROSSING NOTES:

- REFERENCE NOTES AND DETAILS FOR STREAM CONSTRUCTION SEQUENCING AND STREAM RESTORATION (ES-0.01-ES-0.17).
- ightharpoonup 2. FOR TEMPORARY EQUIPMENT CROSSINGS REFERENCE (ES-0.10).
- 3. SITE CONDITIONS MAY ALLOW FOR IMPLEMENTATION OF OTHER APPROVED PIPELINE INSTALLATION METHODS REFERENCED WITH THE NOTES AND DETAILS (ES-0.11-ES-0.14).
- 4. THE PIPELINES SHALL MAINTAIN A MINIMUM OF 5 FEET OF COVER UNDER STREAMS FROM THE TOP OF PIPE TO THE STREAM BED. THIS COVER WILL BE MAINTAINED AT A MINIMUM FROM TOP OF BANK TO TOP OF BANK.
- REFERENCE THE STREAM BANK STABILIZATION DETAIL AND STREAM RESTORATION TABLE IN THE NOTES AND DETAILS WHERE RIP-RAP IS PROPOSED (ES-0.18).
- EROSION CONTROL BLANKET SHALL BE PLACED A MINIMUM OF 50 FEET FROM TOP OF BANK OR 100 FEET FROM TOP OF BANK FOR SPECIAL PROTECTION WATERS (HQ OR EV).
- 7. TIMBER MATS SHALL EXTEND A MINIMUM OF 20 FEET BEYOND TOP OF BANK.

PROFILE LEGEND:

— — — EXISTING GRADE


PROPOSED PIPELINE

PIPE ELEV.

EXISTING GRADE ELEV.

PROPOSED TOP OF

COMPOST FILTER SOCKS SHALL BE INSTALLED ALONG THE TOP OF THE STREAM BANK ACROSS THE RIGHT-OF-WAY WHEN PUMP BYPASS IS NOT IN

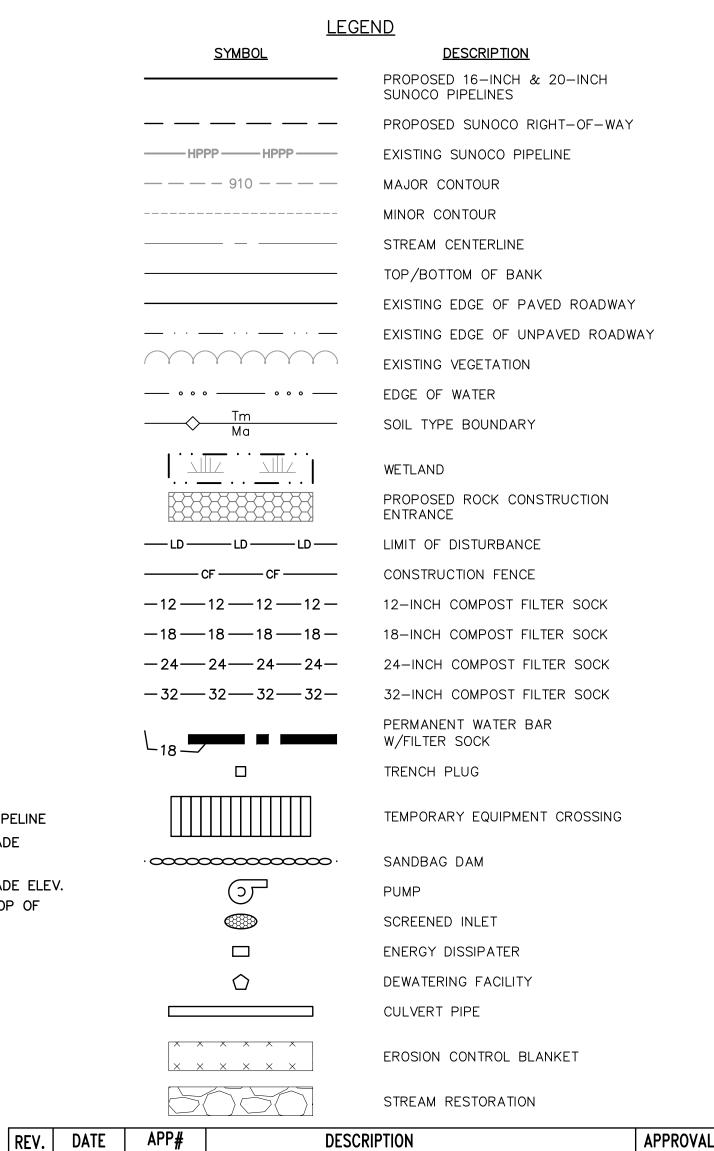



ENGINEERING RECORD DRAWN BY RFG PROFESSIONAL CHECKED BY | CDA CHRISTOPHER D. ANTONI APPROVED BY CDA ENGINEER 11/30/16 DATE No. PE-057385-E / SCALE AS NOTED OLD DRAWING NO.

PE-057385-E

**Sunoco Logistics** Partners L.P.


PENNSYLVANIA PIPELINE PROJECT STREAM S-K4 **RESTORATION PLAN** 


CUMBERLAND COUNTY, PA


DWG. NO. REV. NO. S-K4-C-B

STV PROJECT No.: 38-17335

CHRISTOPHER D. ANTONI

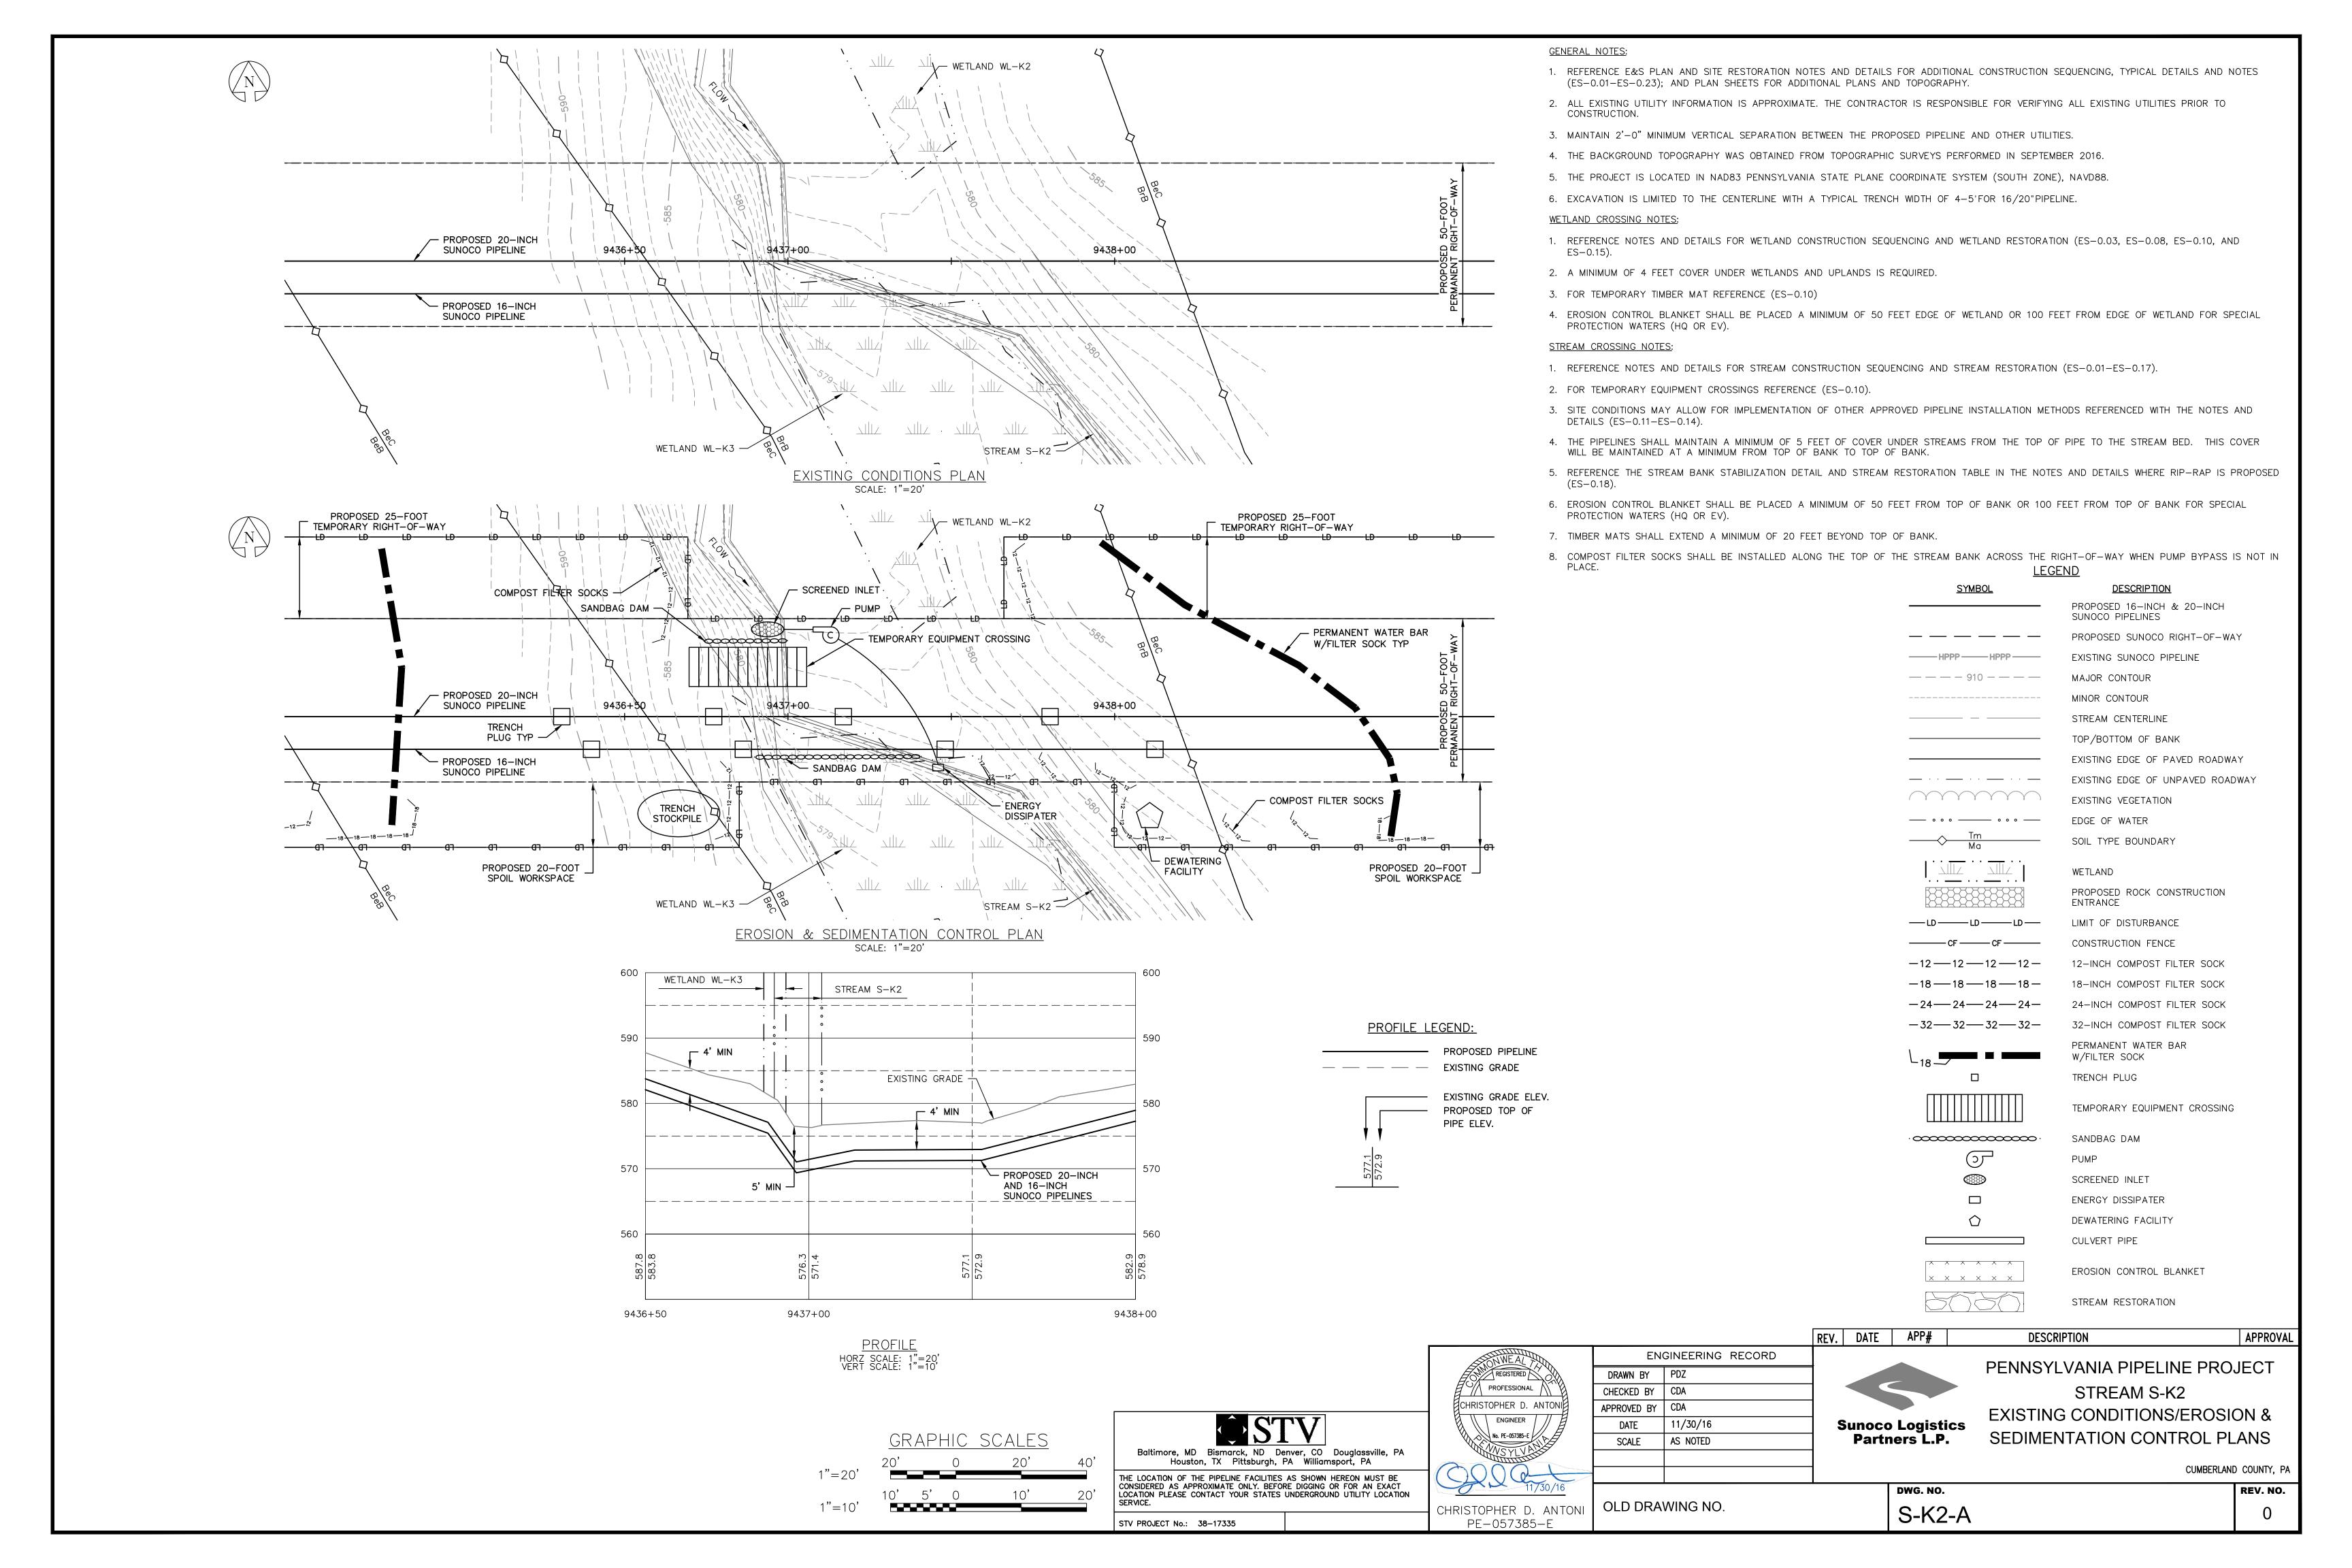

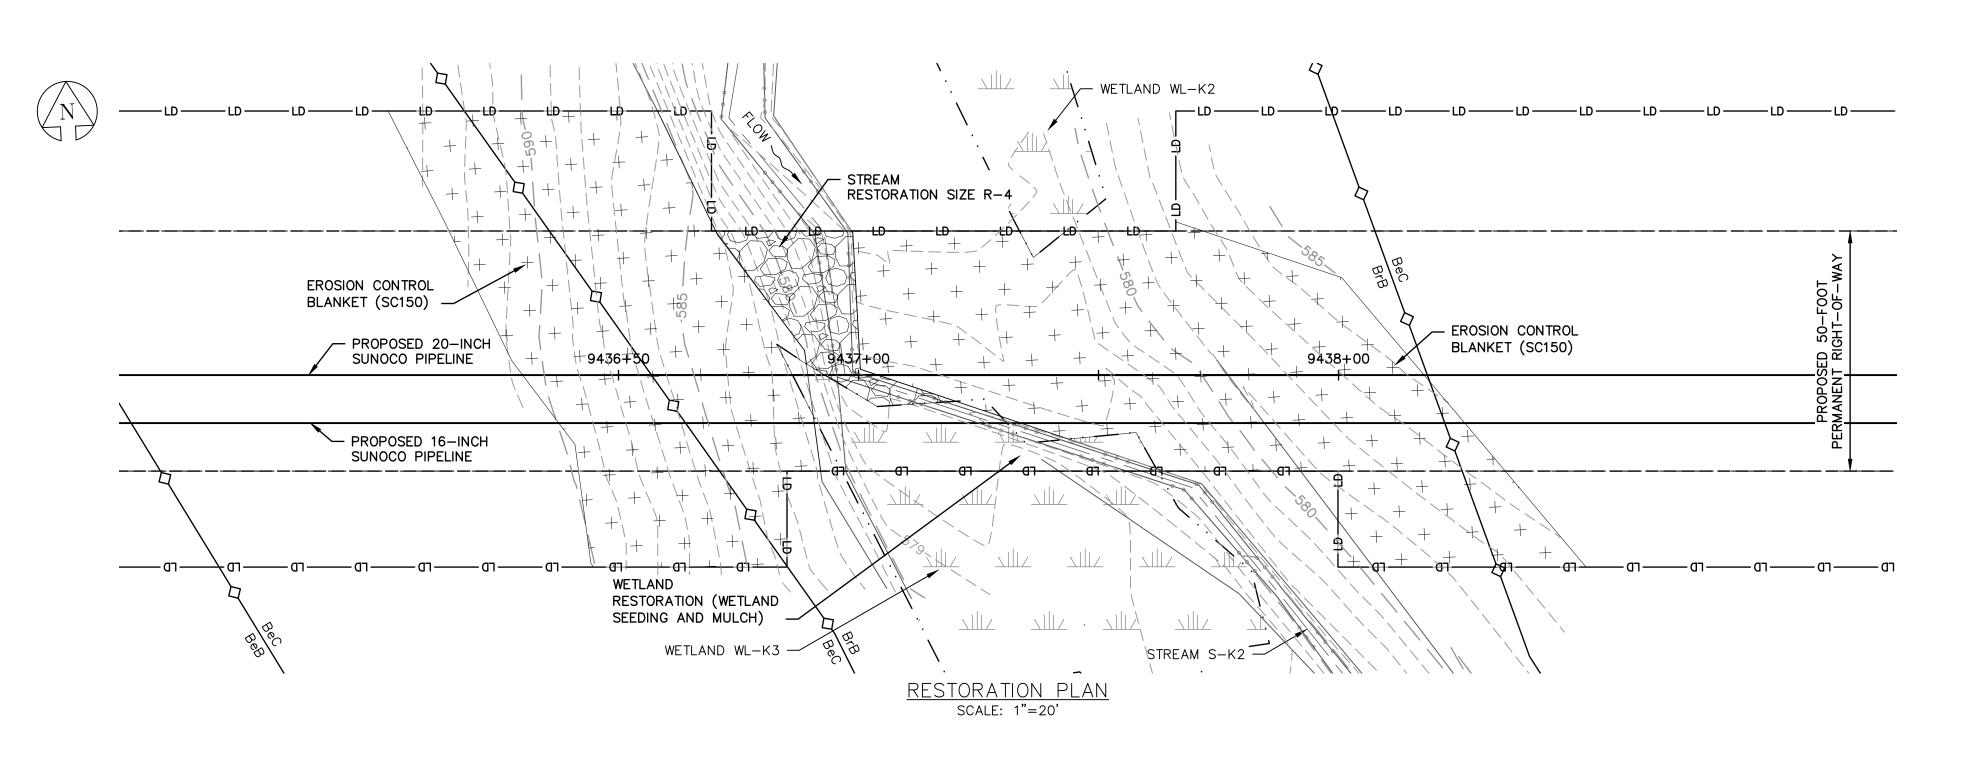

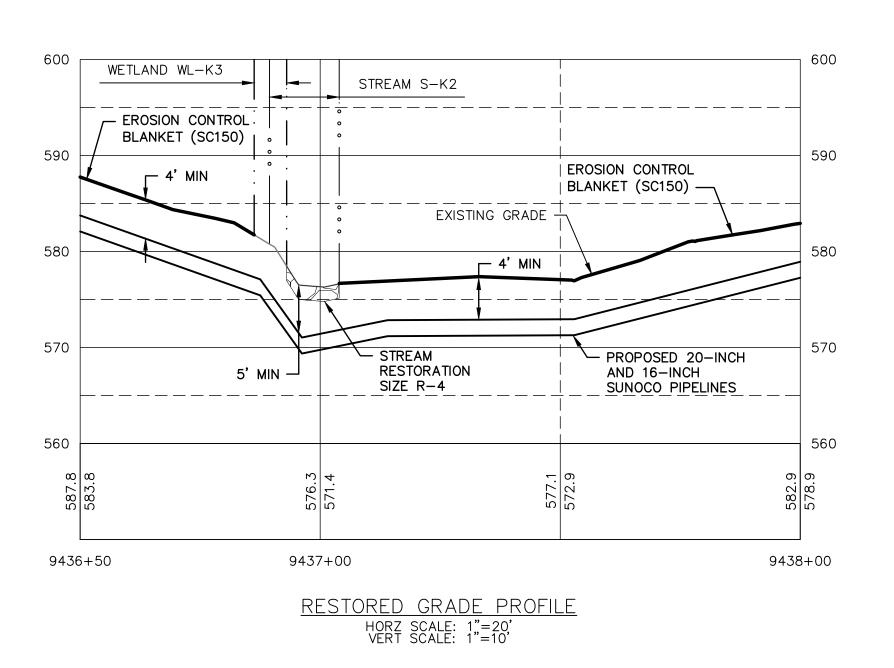

## PROFILE LEGEND: PROPOSED PIPELINE EXISTING GRADE EXISTING GRADE ELEV. PROPOSED TOP OF PIPE ELEV.

### **GENERAL NOTES:**

- 1. REFERENCE E&S PLAN AND SITE RESTORATION NOTES AND DETAILS FOR ADDITIONAL CONSTRUCTION SEQUENCING, TYPICAL DETAILS AND NOTES (ES-0.01-ES-0.23); AND PLAN SHEETS FOR ADDITIONAL PLANS AND TOPOGRAPHY.
- 2. ALL EXISTING UTILITY INFORMATION IS APPROXIMATE. THE CONTRACTOR IS RESPONSIBLE FOR VERIFYING ALL EXISTING UTILITIES PRIOR TO CONSTRUCTION.
- 3. MAINTAIN 2'-0" MINIMUM VERTICAL SEPARATION BETWEEN THE PROPOSED PIPELINE AND OTHER UTILITIES.
- 4. THE BACKGROUND TOPOGRAPHY WAS OBTAINED FROM TOPOGRAPHIC SURVEYS PERFORMED IN SEPTEMBER 2016.
- 5. THE PROJECT IS LOCATED IN NAD83 PENNSYLVANIA STATE PLANE COORDINATE SYSTEM (SOUTH ZONE), NAVD88.
- 6. EXCAVATION IS LIMITED TO THE CENTERLINE WITH A TYPICAL TRENCH WIDTH OF 4-5'FOR 16/20"PIPELINE.


### WETLAND CROSSING NOTES:


- 1. REFERENCE NOTES AND DETAILS FOR WETLAND CONSTRUCTION SEQUENCING AND WETLAND RESTORATION (ES-0.03, ES-0.08, ES-0.10, AND ES-0.15).
- 2. A MINIMUM OF 4 FEET COVER UNDER WETLANDS AND UPLANDS IS REQUIRED.
- 3. FOR TEMPORARY TIMBER MAT REFERENCE (ES-0.10)
- 4. EROSION CONTROL BLANKET SHALL BE PLACED A MINIMUM OF 50 FEET EDGE OF WETLAND OR 100 FEET FROM EDGE OF WETLAND FOR SPECIAL PROTECTION WATERS (HQ OR EV).


### STREAM CROSSING NOTES:

- 1. REFERENCE NOTES AND DETAILS FOR STREAM CONSTRUCTION SEQUENCING AND STREAM RESTORATION (ES-0.01-ES-0.17).
- 2. FOR TEMPORARY EQUIPMENT CROSSINGS REFERENCE (ES-0.10).
- 3. SITE CONDITIONS MAY ALLOW FOR IMPLEMENTATION OF OTHER APPROVED PIPELINE INSTALLATION METHODS REFERENCED WITH THE NOTES AND DETAILS (ES-0.11-ES-0.14).
- 4. THE PIPELINES SHALL MAINTAIN A MINIMUM OF 5 FEET OF COVER UNDER STREAMS FROM THE TOP OF PIPE TO THE STREAM BED. THIS COVER WILL BE MAINTAINED AT A MINIMUM FROM TOP OF BANK TO TOP OF BANK.
- 5. REFERENCE THE STREAM BANK STABILIZATION DETAIL AND STREAM RESTORATION TABLE IN THE NOTES AND DETAILS WHERE RIP-RAP IS PROPOSED (ES-0.18).
- 6. EROSION CONTROL BLANKET SHALL BE PLACED A MINIMUM OF 50 FEET FROM TOP OF BANK OR 100 FEET FROM TOP OF BANK FOR SPECIAL PROTECTION WATERS (HQ OR EV).
- 7. TIMBER MATS SHALL EXTEND A MINIMUM OF 20 FEET BEYOND TOP OF BANK.
- 8. COMPOST FILTER SOCKS SHALL BE INSTALLED ALONG THE TOP OF THE STREAM BANK ACROSS THE RIGHT—OF—WAY WHEN PUMP BYPASS IS NOT IN PLACE.

<u>LEGEND</u>	
<u>SYMBOL</u>	<u>DESCRIPTION</u>
	PROPOSED 16-INCH & 20-INCH SUNOCO PIPELINES
	PROPOSED SUNOCO RIGHT-OF-WAY
——————————————————————————————————————	EXISTING SUNOCO PIPELINE
— — — 910 — — —	MAJOR CONTOUR
	MINOR CONTOUR
	STREAM CENTERLINE
	TOP/BOTTOM OF BANK
	EXISTING EDGE OF PAVED ROADWAY
· · · · · ·	EXISTING EDGE OF UNPAVED ROADWAY
	EXISTING VEGETATION
o o o	EDGE OF WATER
<u> </u>	SOIL TYPE BOUNDARY
	WETLAND
	PROPOSED ROCK CONSTRUCTION ENTRANCE
—LDLDLD	LIMIT OF DISTURBANCE
	CONSTRUCTION FENCE
-12-12-12-12-	12-INCH COMPOST FILTER SOCK
—18 ——18 ——18 —	18-INCH COMPOST FILTER SOCK
-24242424-	24-INCH COMPOST FILTER SOCK
-32—32—32—32—	32-INCH COMPOST FILTER SOCK
<b></b>	PERMANENT WATER BAR W/FILTER SOCK
	TRENCH PLUG
	TEMPORARY EQUIPMENT CROSSING
	SANDBAG DAM
<u></u>	PUMP
	SCREENED INLET
	ENERGY DISSIPATER
$\bigcirc$	DEWATERING FACILITY
	CULVERT PIPE
x x x x x x x x x x x x x x x x x x x	EROSION CONTROL BLANKET
	STREAM RESTORATION
ADD# ADDOUGH	

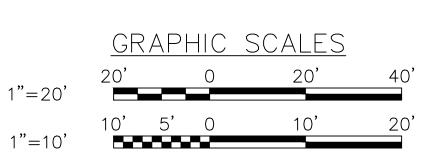

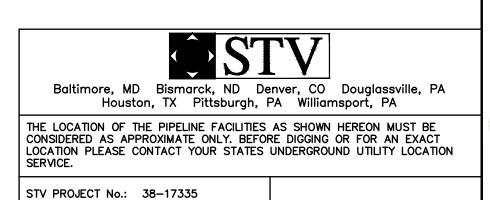

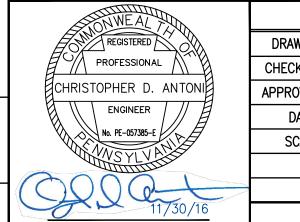

CHRISTOPHER D. ANTONI PE-057385-E

DRAWN BY PDZ

CHECKED BY CDA

APPROVED BY CDA

DATE 11/30/16

SCALE AS NOTED

OLD DRAWING NO.

Sunoco Logistics Partners L.P.

APP#

REV. DATE

PENNSYLVANIA PIPELINE PROJECT
STREAM S-K2
RESTORATION PLAN

CUMBERLAND COUNTY, PA


APPROVAL


DWG. NO.


S-K2-B

0

**DESCRIPTION** 

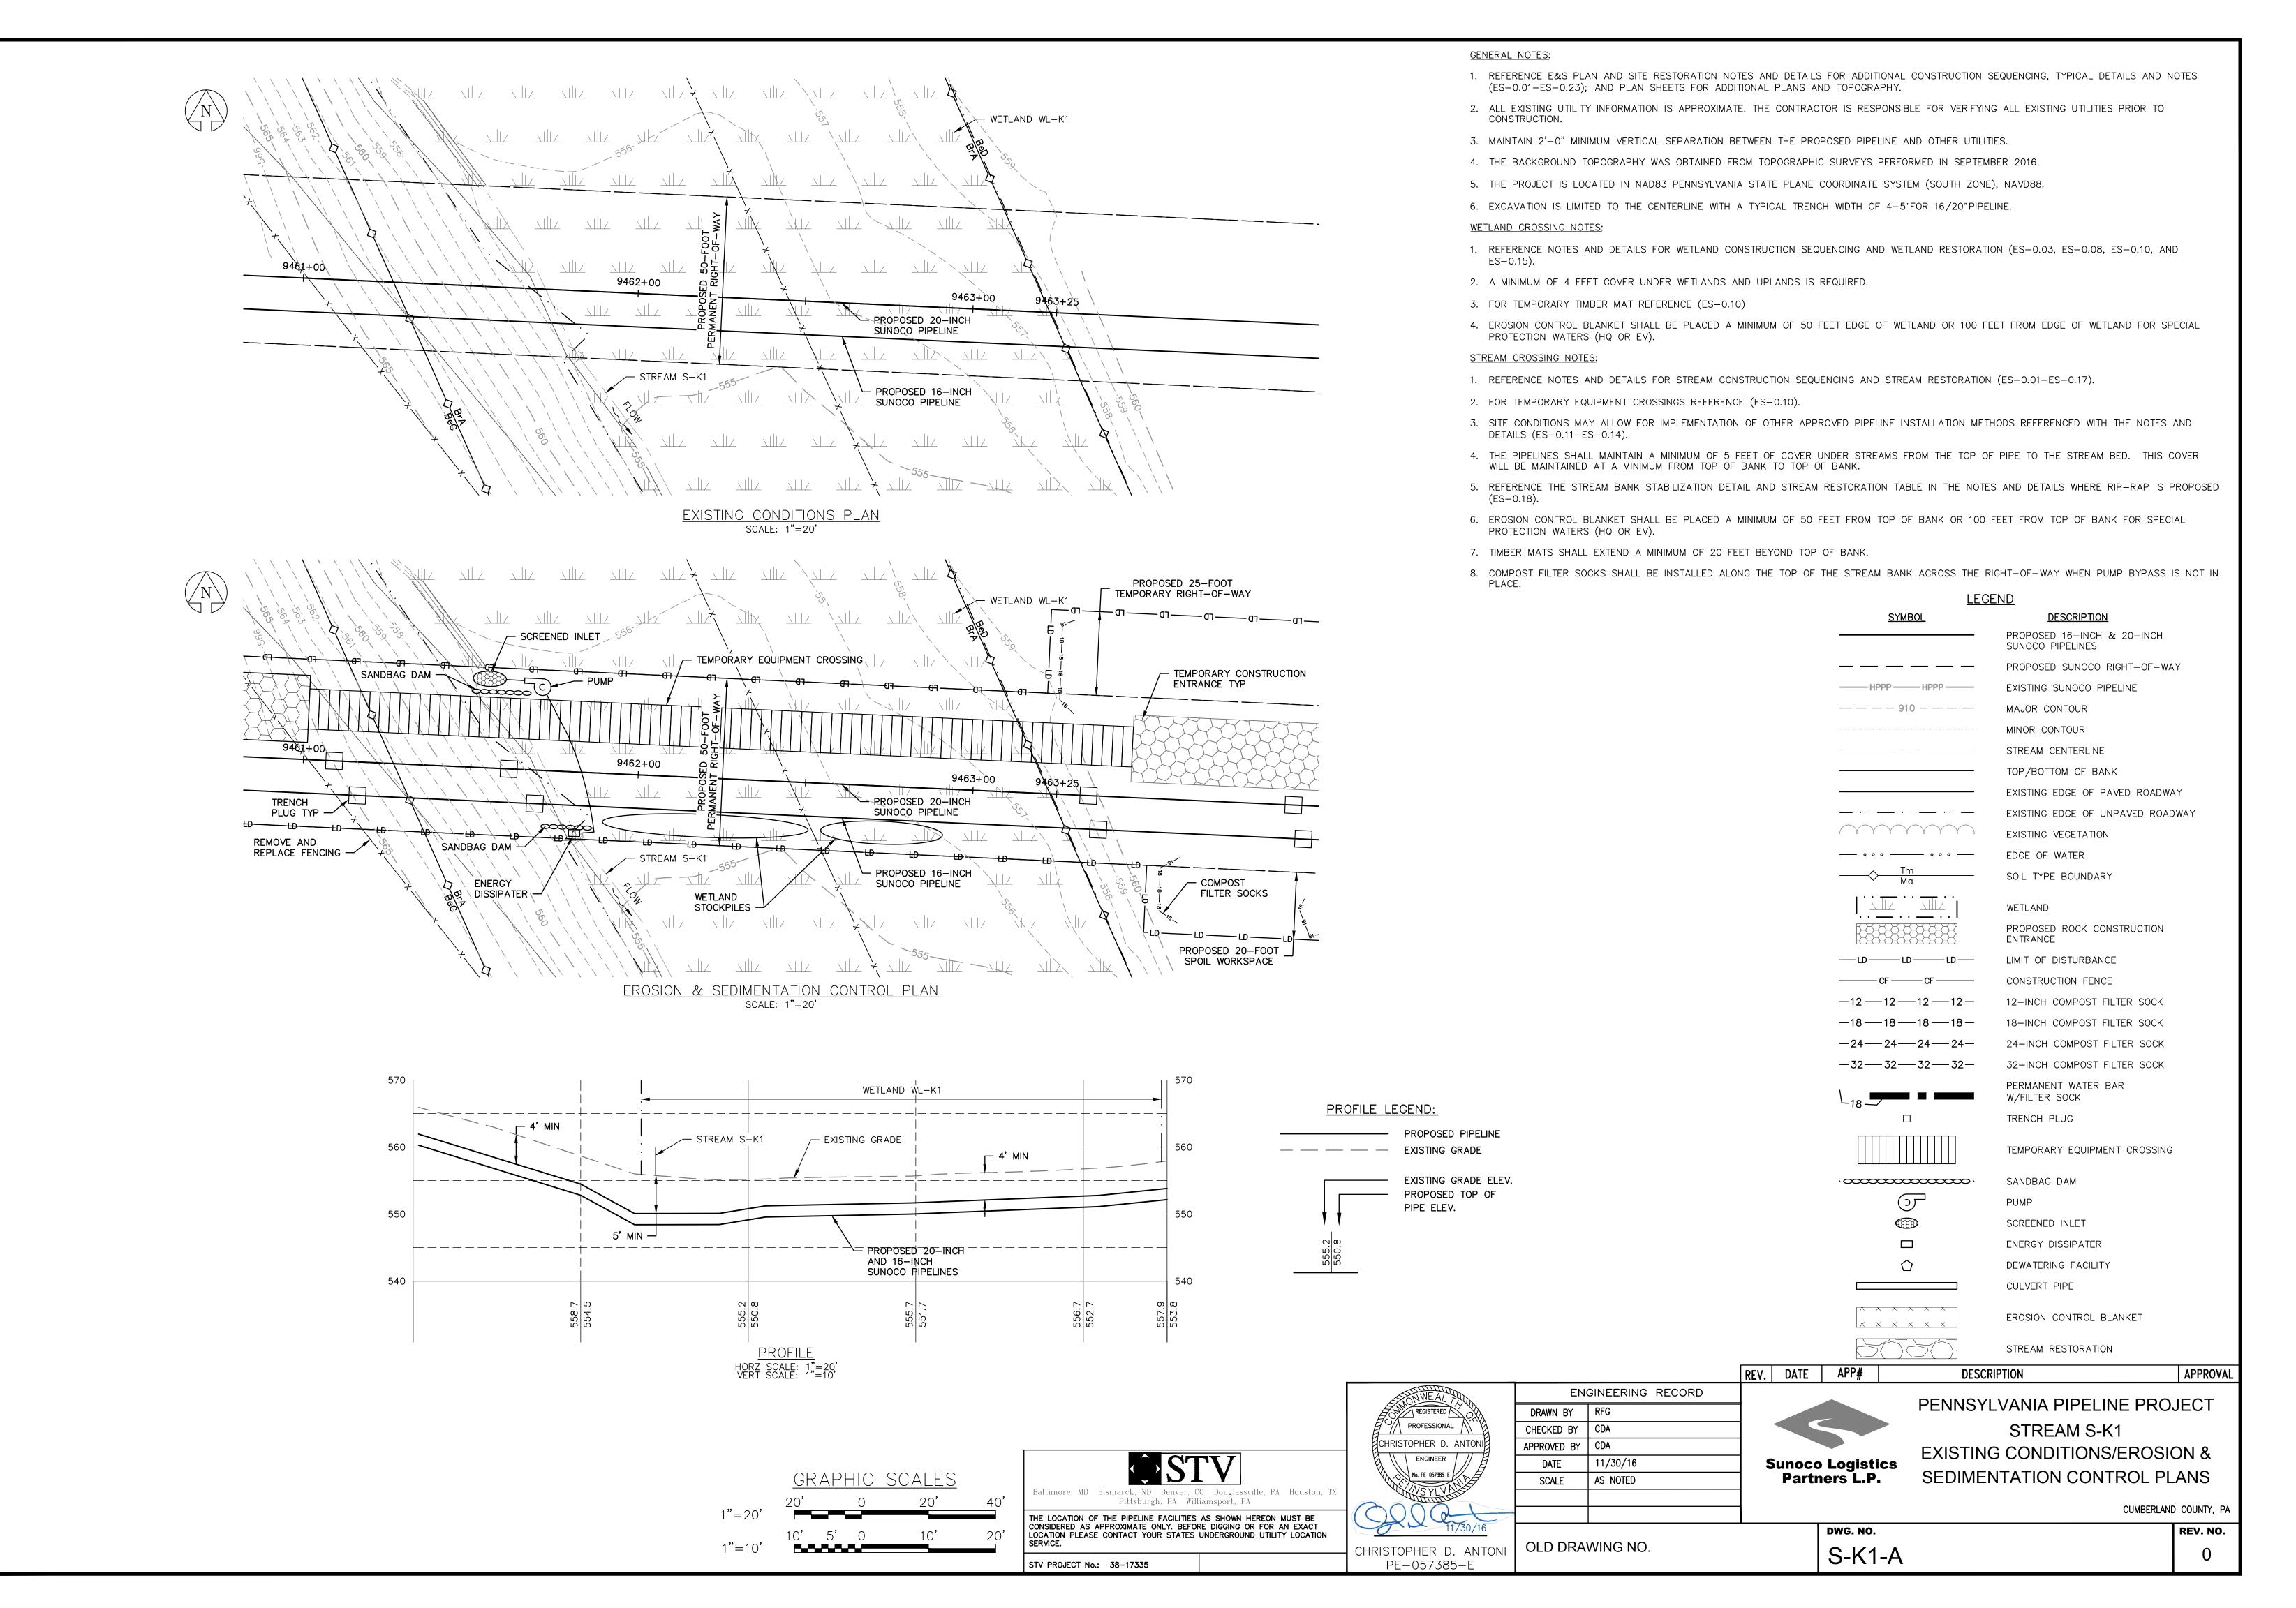


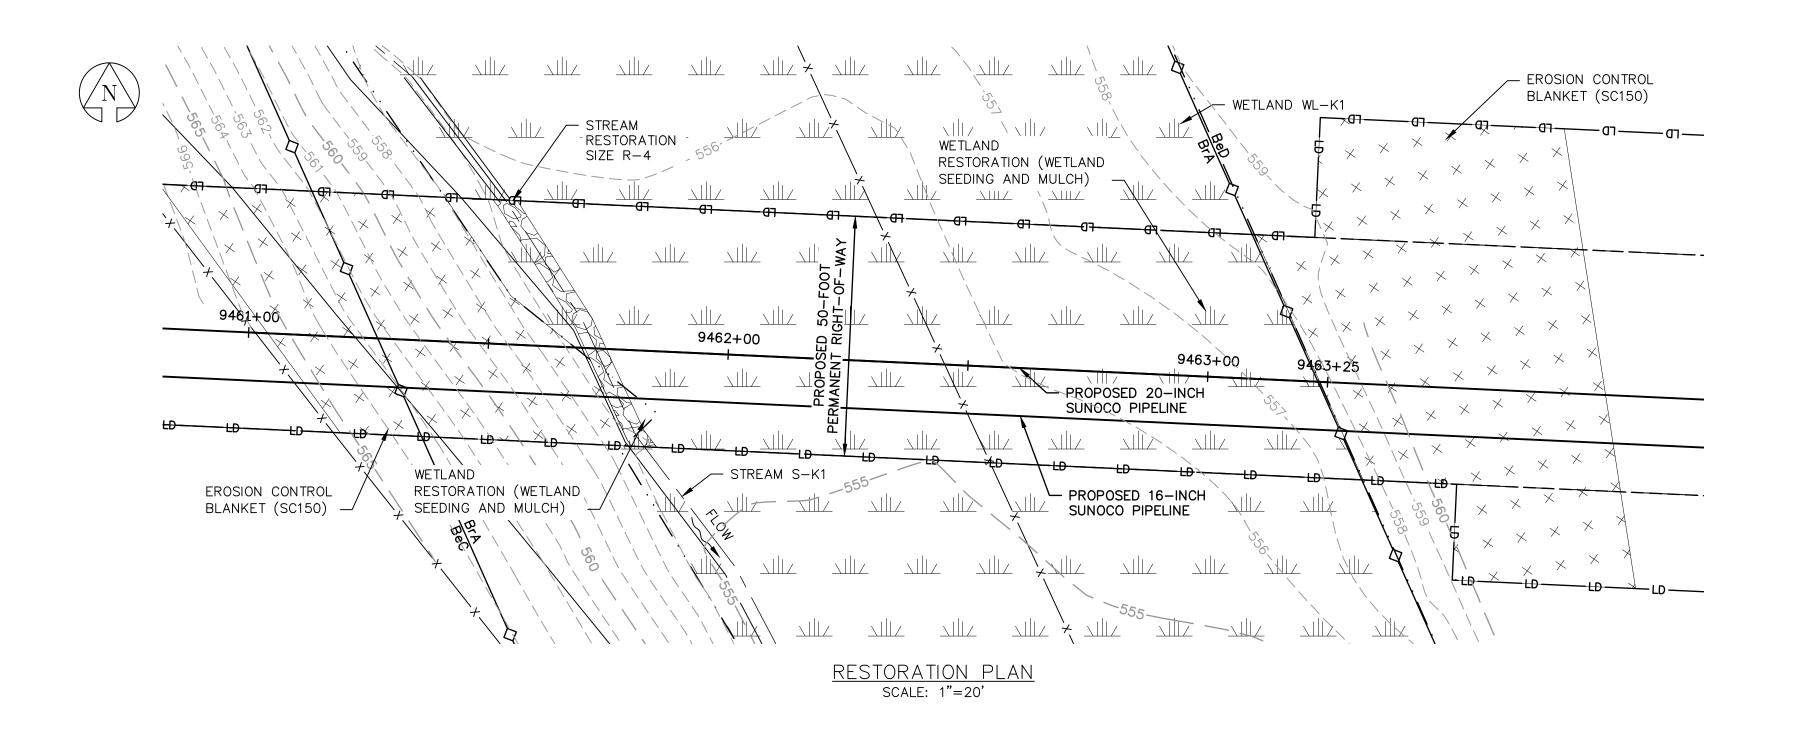

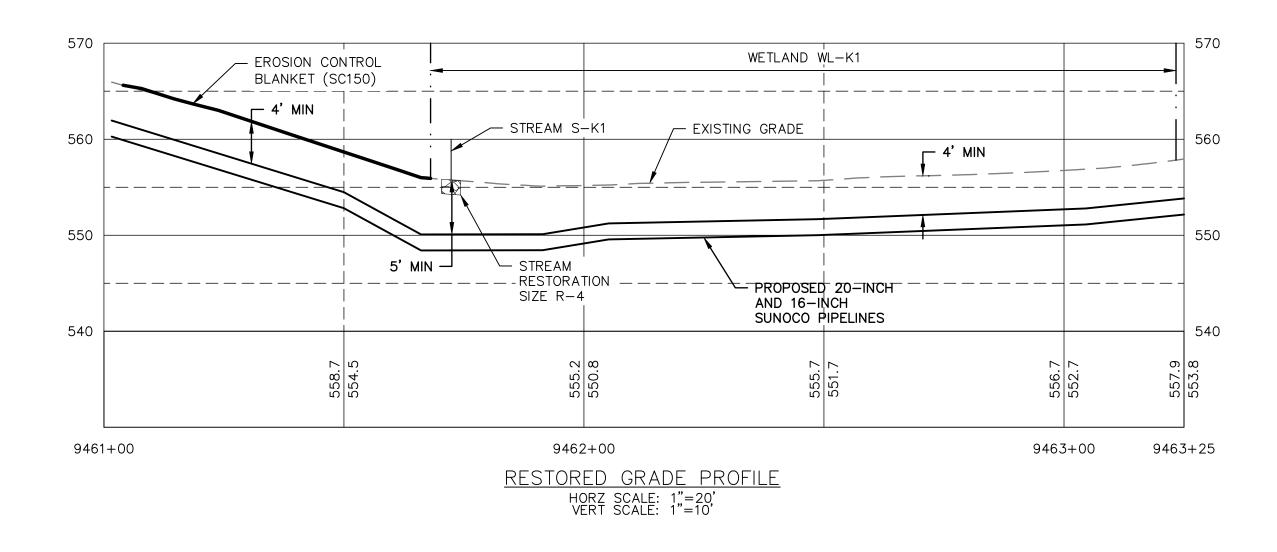

1"=10'

## GRAPHIC SCALES

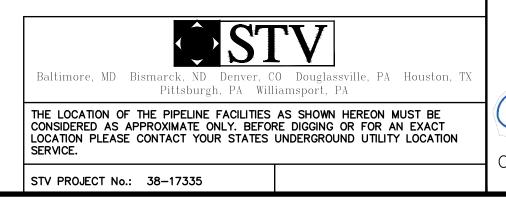

### PROFESSIONAL CHRISTOPHER D. ANTONI ENGINEER No. PE-057385-E / OLD DRAWING NO. CHRISTOPHER D. ANTONI PE-057385-E

### REV. DATE APP# ENGINEERING RECORD DRAWN BY RFG CHECKED BY | CDA APPROVED BY CDA 11/30/16 DATE AS NOTED SCALE

PROFILE LEGEND:

PROPOSED PIPELINE EXISTING GRADE

EXISTING GRADE ELEV.

PROPOSED TOP OF

PIPE ELEV.

### **Sunoco Logistics** Partners L.P.

### APPROVAL DESCRIPTION PENNSYLVANIA PIPELINE PROJECT STREAM S-K1 **RESTORATION PLAN**

STREAM RESTORATION

**DESCRIPTION** 

SUNOCO PIPELINES

MAJOR CONTOUR

MINOR CONTOUR

STREAM CENTERLINE

TOP/BOTTOM OF BANK

EXISTING VEGETATION

SOIL TYPE BOUNDARY

LIMIT OF DISTURBANCE

CONSTRUCTION FENCE

EDGE OF WATER

WETLAND

ENTRANCE

EXISTING SUNOCO PIPELINE

PROPOSED 16-INCH & 20-INCH

PROPOSED SUNOCO RIGHT-OF-WAY

EXISTING EDGE OF PAVED ROADWAY

PROPOSED ROCK CONSTRUCTION

12-INCH COMPOST FILTER SOCK

18-INCH COMPOST FILTER SOCK

24-INCH COMPOST FILTER SOCK

32-INCH COMPOST FILTER SOCK

TEMPORARY EQUIPMENT CROSSING

PERMANENT WATER BAR

W/FILTER SOCK

TRENCH PLUG

SANDBAG DAM

SCREENED INLET

CULVERT PIPE

ENERGY DISSIPATER

DEWATERING FACILITY

EROSION CONTROL BLANKET

PUMP

EXISTING EDGE OF UNPAVED ROADWAY

CUMBERLAND COUNTY, PA

DWG. NO. REV. NO. S-K1-B

### **GENERAL NOTES:**

- 1. REFERENCE E&S PLAN AND SITE RESTORATION NOTES AND DETAILS FOR ADDITIONAL CONSTRUCTION SEQUENCING, TYPICAL DETAILS AND NOTES (ES-0.01-ES-0.23); AND PLAN SHEETS FOR ADDITIONAL PLANS AND TOPOGRAPHY.
- 2. ALL EXISTING UTILITY INFORMATION IS APPROXIMATE. THE CONTRACTOR IS RESPONSIBLE FOR VERIFYING ALL EXISTING UTILITIES PRIOR TO CONSTRUCTION.
- 3. MAINTAIN 2'-0" MINIMUM VERTICAL SEPARATION BETWEEN THE PROPOSED PIPELINE AND OTHER UTILITIES.
- 4. THE BACKGROUND TOPOGRAPHY WAS OBTAINED FROM TOPOGRAPHIC SURVEYS PERFORMED IN SEPTEMBER 2016.
- 5. THE PROJECT IS LOCATED IN NAD83 PENNSYLVANIA STATE PLANE COORDINATE SYSTEM (SOUTH ZONE), NAVD88.
- 6. EXCAVATION IS LIMITED TO THE CENTERLINE WITH A TYPICAL TRENCH WIDTH OF 4-5'FOR 16/20"PIPELINE.

### WETLAND CROSSING NOTES:

- 1. REFERENCE NOTES AND DETAILS FOR WETLAND CONSTRUCTION SEQUENCING AND WETLAND RESTORATION (ES-0.03, ES-0.08, ES-0.10, AND ES-0.15).
- 2. A MINIMUM OF 4 FEET COVER UNDER WETLANDS AND UPLANDS IS REQUIRED.
- 3. FOR TEMPORARY TIMBER MAT REFERENCE (ES-0.10)
- 4. EROSION CONTROL BLANKET SHALL BE PLACED A MINIMUM OF 50 FEET EDGE OF WETLAND OR 100 FEET FROM EDGE OF WETLAND FOR SPECIAL PROTECTION WATERS (HQ OR EV).

### STREAM CROSSING NOTES:

- 1. REFERENCE NOTES AND DETAILS FOR STREAM CONSTRUCTION SEQUENCING AND STREAM RESTORATION (ES-0.01-ES-0.17).
- 2. FOR TEMPORARY EQUIPMENT CROSSINGS REFERENCE (ES-0.10).
- 3. SITE CONDITIONS MAY ALLOW FOR IMPLEMENTATION OF OTHER APPROVED PIPELINE INSTALLATION METHODS REFERENCED WITH THE NOTES AND DETAILS (ES-0.11-ES-0.14).
- 4. THE PIPELINES SHALL MAINTAIN A MINIMUM OF 5 FEET OF COVER UNDER STREAMS FROM THE TOP OF PIPE TO THE STREAM BED. THIS COVER WILL BE MAINTAINED AT A MINIMUM FROM TOP OF BANK TO TOP OF BANK.
- 5. REFERENCE THE STREAM BANK STABILIZATION DETAIL AND STREAM RESTORATION TABLE IN THE NOTES AND DETAILS WHERE RIP-RAP IS PROPOSED (ES-0.18).
- 6. EROSION CONTROL BLANKET SHALL BE PLACED A MINIMUM OF 50 FEET FROM TOP OF BANK OR 100 FEET FROM TOP OF BANK FOR SPECIAL PROTECTION WATERS (HQ OR EV).
- 7. TIMBER MATS SHALL EXTEND A MINIMUM OF 20 FEET BEYOND TOP OF BANK.
- 8. COMPOST FILTER SOCKS SHALL BE INSTALLED ALONG THE TOP OF THE STREAM BANK ACROSS THE RIGHT-OF-WAY WHEN PUMP BYPASS IS NOT IN

<u>SYMBOL</u>

——— HPPP ——— HPPP ———

\_\_\_ 。。。\_\_\_\_ 。。。\_\_\_

—LD——LD——LD—

-18 - 18 - 18 - 18 - 18 -

-24-24-24-24-

-32—32—32—32

 $\times$   $\times$   $\times$   $\times$   $\times$ 

### **GENERAL NOTES:** 1. REFERENCE E&S PLAN AND SITE RESTORATION NOTES AND DETAILS FOR ADDITIONAL CONSTRUCTION SEQUENCING, TYPICAL DETAILS AND NOTES (ES-0.01-ES-0.23); AND PLAN SHEETS FOR ADDITIONAL PLANS AND TOPOGRAPHY. 2. ALL EXISTING UTILITY INFORMATION IS APPROXIMATE. THE CONTRACTOR IS RESPONSIBLE FOR VERIFYING ALL EXISTING UTILITIES PRIOR TO CONSTRUCTION. 3. MAINTAIN 2'-0" MINIMUM VERTICAL SEPARATION BETWEEN THE PROPOSED PIPELINE AND OTHER UTILITIES.

4. THE BACKGROUND TOPOGRAPHY WAS OBTAINED FROM TOPOGRAPHIC SURVEYS PERFORMED IN SEPTEMBER 2016.

5. THE PROJECT IS LOCATED IN NAD83 PENNSYLVANIA STATE PLANE COORDINATE SYSTEM (SOUTH ZONE), NAVD88.

6. EXCAVATION IS LIMITED TO THE CENTERLINE WITH A TYPICAL TRENCH WIDTH OF 4-5'FOR 16/20"PIPELINE.


### WETLAND CROSSING NOTES:


- 1. REFERENCE NOTES AND DETAILS FOR WETLAND CONSTRUCTION SEQUENCING AND WETLAND RESTORATION (ES-0.03, ES-0.08, ES-0.10, AND ES-0.15).
- 2. A MINIMUM OF 4 FEET COVER UNDER WETLANDS AND UPLANDS IS REQUIRED.
- 3. FOR TEMPORARY TIMBER MAT REFERENCE (ES-0.10)
- 4. EROSION CONTROL BLANKET SHALL BE PLACED A MINIMUM OF 50 FEET EDGE OF WETLAND OR 100 FEET FROM EDGE OF WETLAND FOR SPECIAL PROTECTION WATERS (HQ OR EV).

### STREAM CROSSING NOTES:

- 1. REFERENCE NOTES AND DETAILS FOR STREAM CONSTRUCTION SEQUENCING AND STREAM RESTORATION (ES-0.01-ES-0.17).
- 2. FOR TEMPORARY EQUIPMENT CROSSINGS REFERENCE (ES-0.10).
- 3. SITE CONDITIONS MAY ALLOW FOR IMPLEMENTATION OF OTHER APPROVED PIPELINE INSTALLATION METHODS REFERENCED WITH THE NOTES AND DETAILS (ES-0.11-ES-0.14).
- 4. THE PIPELINES SHALL MAINTAIN A MINIMUM OF 5 FEET OF COVER UNDER STREAMS FROM THE TOP OF PIPE TO THE STREAM BED. THIS COVER WILL BE MAINTAINED AT A MINIMUM FROM TOP OF BANK TO TOP OF BANK.
- 5. REFERENCE THE STREAM BANK STABILIZATION DETAIL AND STREAM RESTORATION TABLE IN THE NOTES AND DETAILS WHERE RIP-RAP IS PROPOSED (ES-0.18).
- 6. EROSION CONTROL BLANKET SHALL BE PLACED A MINIMUM OF 50 FEET FROM TOP OF BANK OR 100 FEET FROM TOP OF BANK FOR SPECIAL PROTECTION WATERS (HQ OR EV).
- 7. TIMBER MATS SHALL EXTEND A MINIMUM OF 20 FEET BEYOND TOP OF BANK.
- 8. COMPOST FILTER SOCKS SHALL BE INSTALLED ALONG THE TOP OF THE STREAM BANK ACROSS THE RIGHT-OF-WAY WHEN PUMP BYPASS IS NOT IN PLACE.


**SYMBOL** 

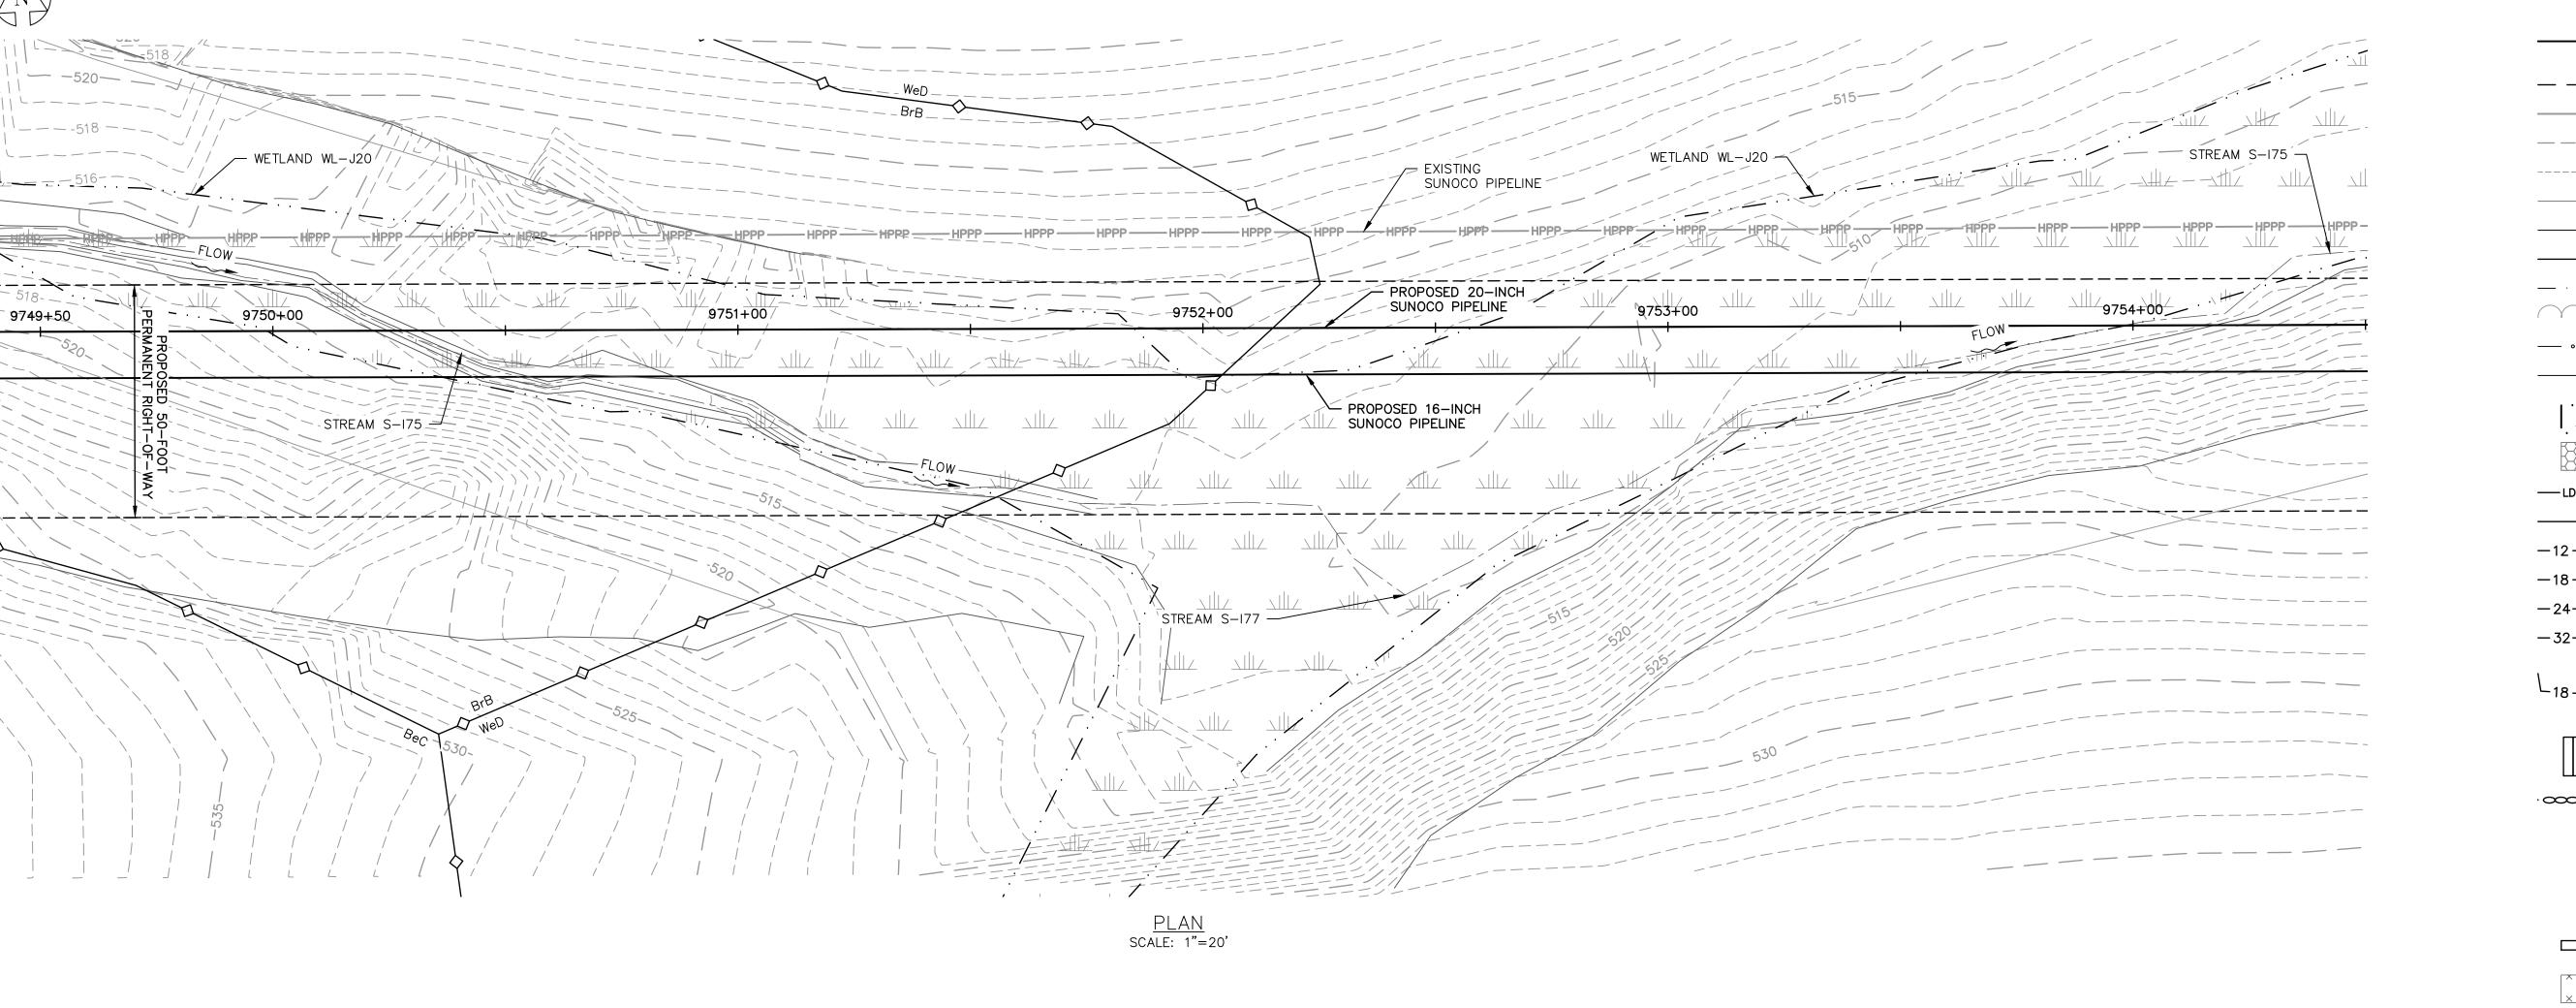


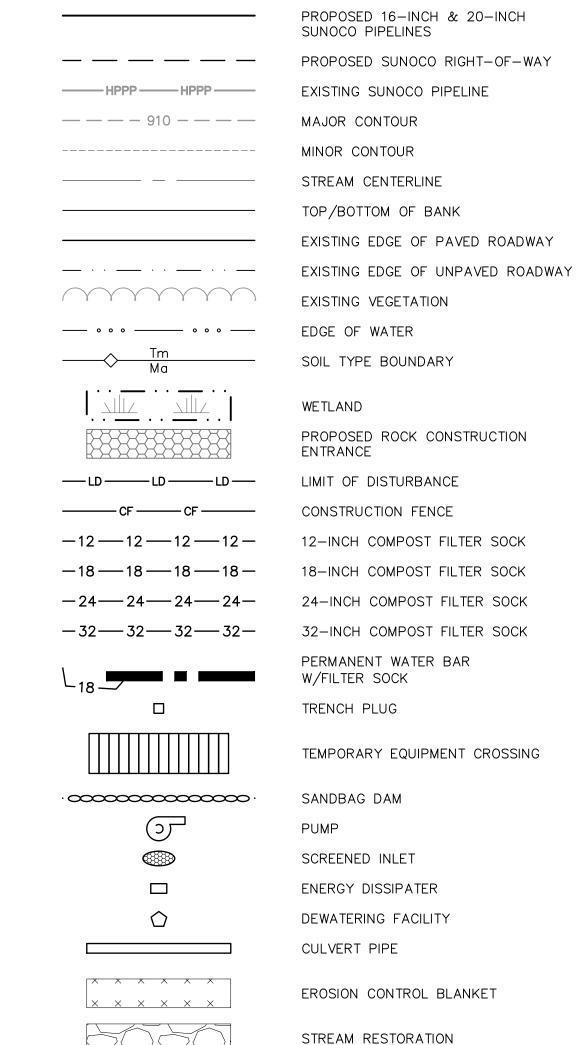

<u>LEGEND</u>

**DESCRIPTION** 

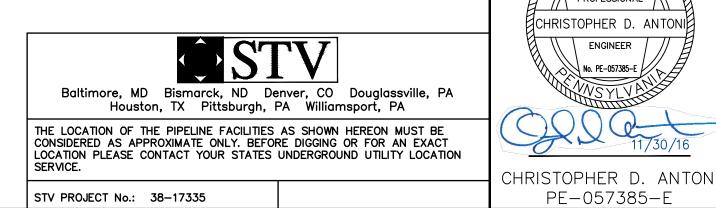

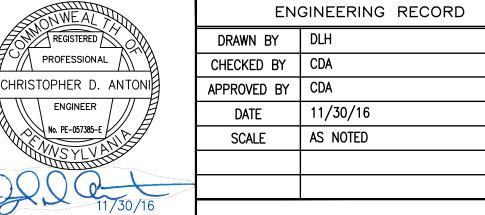

PE-057385-E

**Sunoco Logistics** Partners L.P.

REV. DATE APP#

PENNSYLVANIA PIPELINE PROJECT STREAMS S-I75 AND S-I76 **EXISTING CONDITIONS** 


DESCRIPTION

CUMBERLAND COUNTY, PA

APPROVAL

OLD DRAWING NO.

DWG. NO. S-175-A REV. NO.

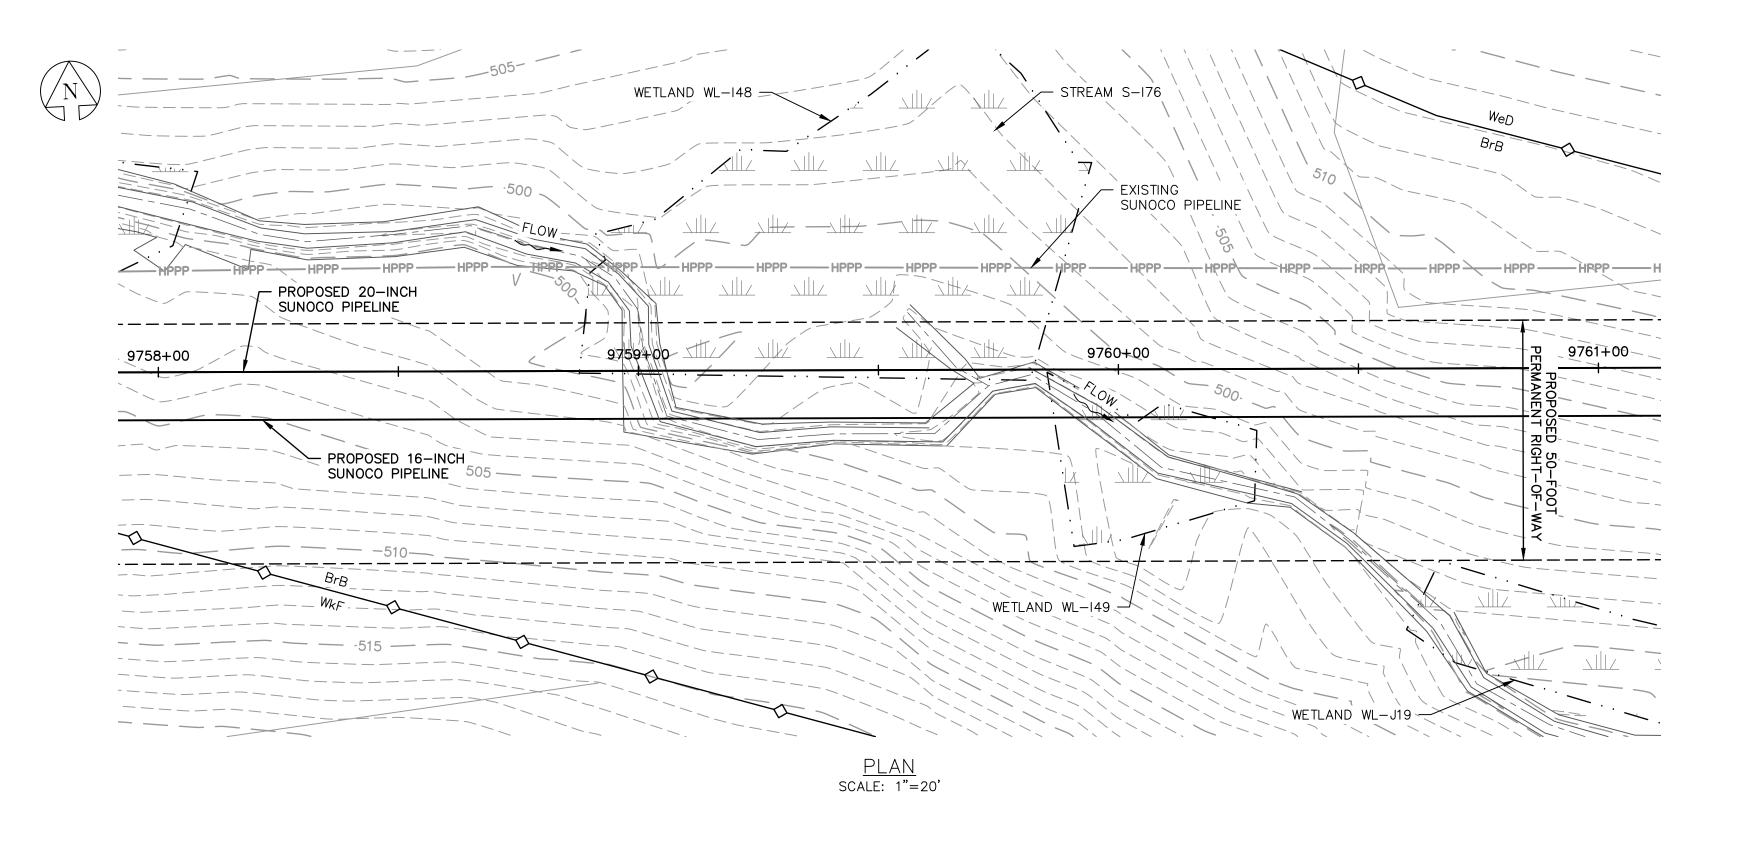

- 1. REFERENCE E&S PLAN AND SITE RESTORATION NOTES AND DETAILS FOR ADDITIONAL CONSTRUCTION SEQUENCING, TYPICAL DETAILS AND NOTES (ES-0.01-ES-0.23); AND PLAN SHEETS FOR ADDITIONAL PLANS AND TOPOGRAPHY.
- 2. ALL EXISTING UTILITY INFORMATION IS APPROXIMATE. THE CONTRACTOR IS RESPONSIBLE FOR VERIFYING ALL EXISTING UTILITIES PRIOR TO CONSTRUCTION.
- 3. MAINTAIN 2'-0" MINIMUM VERTICAL SEPARATION BETWEEN THE PROPOSED PIPELINE AND OTHER UTILITIES.
- 4. THE BACKGROUND TOPOGRAPHY WAS OBTAINED FROM TOPOGRAPHIC SURVEYS PERFORMED IN SEPTEMBER 2016.
- 5. THE PROJECT IS LOCATED IN NAD83 PENNSYLVANIA STATE PLANE COORDINATE SYSTEM (SOUTH ZONE), NAVD88.
- 6. EXCAVATION IS LIMITED TO THE CENTERLINE WITH A TYPICAL TRENCH WIDTH OF 4-5'FOR 16/20"PIPELINE.

### WETLAND CROSSING NOTES:

- 1. REFERENCE NOTES AND DETAILS FOR WETLAND CONSTRUCTION SEQUENCING AND WETLAND RESTORATION (ES-0.03, ES-0.08, ES-0.10, AND ES-0.15).
- 2. A MINIMUM OF 4 FEET COVER UNDER WETLANDS AND UPLANDS IS REQUIRED.
- 3. FOR TEMPORARY TIMBER MAT REFERENCE (ES-0.10)
- 4. EROSION CONTROL BLANKET SHALL BE PLACED A MINIMUM OF 50 FEET EDGE OF WETLAND OR 100 FEET FROM EDGE OF WETLAND FOR SPECIAL PROTECTION WATERS (HQ OR EV).

### STREAM CROSSING NOTES:

- 1. REFERENCE NOTES AND DETAILS FOR STREAM CONSTRUCTION SEQUENCING AND STREAM RESTORATION (ES-0.01-ES-0.17).
- 2. FOR TEMPORARY EQUIPMENT CROSSINGS REFERENCE (ES-0.10).
- 3. SITE CONDITIONS MAY ALLOW FOR IMPLEMENTATION OF OTHER APPROVED PIPELINE INSTALLATION METHODS REFERENCED WITH THE NOTES AND DETAILS (ES-0.11-ES-0.14).
- 4. THE PIPELINES SHALL MAINTAIN A MINIMUM OF 5 FEET OF COVER UNDER STREAMS FROM THE TOP OF PIPE TO THE STREAM BED. THIS COVER WILL BE MAINTAINED AT A MINIMUM FROM TOP OF BANK TO TOP OF BANK.
- 5. REFERENCE THE STREAM BANK STABILIZATION DETAIL AND STREAM RESTORATION TABLE IN THE NOTES AND DETAILS WHERE RIP-RAP IS PROPOSED (ES-0.18).
- 6. EROSION CONTROL BLANKET SHALL BE PLACED A MINIMUM OF 50 FEET FROM TOP OF BANK OR 100 FEET FROM TOP OF BANK FOR SPECIAL PROTECTION WATERS (HQ OR EV).
- 7. TIMBER MATS SHALL EXTEND A MINIMUM OF 20 FEET BEYOND TOP OF BANK.
- 8. COMPOST FILTER SOCKS SHALL BE INSTALLED ALONG THE TOP OF THE STREAM BANK ACROSS THE RIGHT-OF-WAY WHEN PUMP BYPASS IS NOT IN PLACE.

### **LEGEND** <u>SYMBOL</u> <u>DESCRIPTION</u> PROPOSED 16-INCH & 20-INCH SUNOCO PIPELINES PROPOSED SUNOCO RIGHT-OF-WAY EXISTING SUNOCO PIPELINE MAJOR CONTOUR — — — — 910 — — — — MINOR CONTOUR STREAM CENTERLINE TOP/BOTTOM OF BANK EXISTING EDGE OF PAVED ROADWAY EXISTING EDGE OF UNPAVED ROADWAY EXISTING VEGETATION EDGE OF WATER \_\_\_ 。。。 \_\_\_\_ 。。。 \_\_\_ SOIL TYPE BOUNDARY WETLAND PROPOSED ROCK CONSTRUCTION ENTRANCE LIMIT OF DISTURBANCE CONSTRUCTION FENCE -12 --- 12 --- 12 --- 12 --- 12 ---12-INCH COMPOST FILTER SOCK 18-INCH COMPOST FILTER SOCK **-24--24--24--24** 24-INCH COMPOST FILTER SOCK 32-INCH COMPOST FILTER SOCK -32—32—32—32— PERMANENT WATER BAR W/FILTER SOCK TRENCH PLUG TEMPORARY EQUIPMENT CROSSING $\cdot$ SANDBAG DAM PUMP SCREENED INLET ENERGY DISSIPATER DEWATERING FACILITY CULVERT PIPE EROSION CONTROL BLANKET STREAM RESTORATION

ENGINEERING RECORD DRAWN BY DLH PROFESSIONAL CHECKED BY CDA CHRISTOPHER D. ANTONIE APPROVED BY CDA 11/30/16 DATE No. PE-057385-E / SCALE AS NOTED

Sunoco Logistics Partners L.P.

REV. DATE APP#

PENNSYLVANIA PIPELINE PROJECT STREAMS S-I75 AND S-I76 **EXISTING CONDITIONS** 

DESCRIPTION

CUMBERLAND COUNTY, PA

APPROVAL

REV. NO.

CHRISTOPHER D. ANTON PE-057385-E

OLD DRAWING NO.

DWG. NO. S-I75-B

STV PROJECT No.: 38-17335

Baltimore, MD Bismarck, ND Denver, CO Douglassville, PA Houston, TX Pittsburgh, PA Williamsport, PA

THE LOCATION OF THE PIPELINE FACILITIES AS SHOWN HEREON MUST BE CONSIDERED AS APPROXIMATE ONLY. BEFORE DIGGING OR FOR AN EXACT LOCATION PLEASE CONTACT YOUR STATES UNDERGROUND UTILITY LOCATION

- 1. REFERENCE E&S PLAN AND SITE RESTORATION NOTES AND DETAILS FOR ADDITIONAL CONSTRUCTION SEQUENCING, TYPICAL DETAILS AND NOTES (ES-0.01-ES-0.23); AND PLAN SHEETS FOR ADDITIONAL PLANS AND TOPOGRAPHY.
- 2. ALL EXISTING UTILITY INFORMATION IS APPROXIMATE. THE CONTRACTOR IS RESPONSIBLE FOR VERIFYING ALL EXISTING UTILITIES PRIOR TO CONSTRUCTION.
- 3. MAINTAIN 2'-0" MINIMUM VERTICAL SEPARATION BETWEEN THE PROPOSED PIPELINE AND OTHER UTILITIES.
- 4. THE BACKGROUND TOPOGRAPHY WAS OBTAINED FROM TOPOGRAPHIC SURVEYS PERFORMED IN SEPTEMBER 2016.
- 5. THE PROJECT IS LOCATED IN NAD83 PENNSYLVANIA STATE PLANE COORDINATE SYSTEM (SOUTH ZONE), NAVD88.
- 6. EXCAVATION IS LIMITED TO THE CENTERLINE WITH A TYPICAL TRENCH WIDTH OF 4-5'FOR 16/20"PIPELINE.

### WETLAND CROSSING NOTES:

- 1. REFERENCE NOTES AND DETAILS FOR WETLAND CONSTRUCTION SEQUENCING AND WETLAND RESTORATION (ES-0.03, ES-0.08, ES-0.10, AND ES-0.15).
- 2. A MINIMUM OF 4 FEET COVER UNDER WETLANDS AND UPLANDS IS REQUIRED.
- 3. FOR TEMPORARY TIMBER MAT REFERENCE (ES-0.10)
- 4. EROSION CONTROL BLANKET SHALL BE PLACED A MINIMUM OF 50 FEET EDGE OF WETLAND OR 100 FEET FROM EDGE OF WETLAND FOR SPECIAL PROTECTION WATERS (HQ OR EV).

### STREAM CROSSING NOTES:

- 1. REFERENCE NOTES AND DETAILS FOR STREAM CONSTRUCTION SEQUENCING AND STREAM RESTORATION (ES-0.01-ES-0.17).
- 2. FOR TEMPORARY EQUIPMENT CROSSINGS REFERENCE (ES-0.10).
- 3. SITE CONDITIONS MAY ALLOW FOR IMPLEMENTATION OF OTHER APPROVED PIPELINE INSTALLATION METHODS REFERENCED WITH THE NOTES AND DETAILS (ES-0.11-ES-0.14).
- 4. THE PIPELINES SHALL MAINTAIN A MINIMUM OF 5 FEET OF COVER UNDER STREAMS FROM THE TOP OF PIPE TO THE STREAM BED. THIS COVER WILL BE MAINTAINED AT A MINIMUM FROM TOP OF BANK TO TOP OF BANK.

5. REFERENCE THE STREAM BANK STABILIZATION DETAIL AND STREAM RESTORATION TABLE IN THE NOTES AND DETAILS WHERE RIP-RAP IS PROPOSED

- (ES-0.18).6. EROSION CONTROL BLANKET SHALL BE PLACED A MINIMUM OF 50 FEET FROM TOP OF BANK OR 100 FEET FROM TOP OF BANK FOR SPECIAL
- PROTECTION WATERS (HQ OR EV).
- 7. TIMBER MATS SHALL EXTEND A MINIMUM OF 20 FEET BEYOND TOP OF BANK.
- 8. COMPOST FILTER SOCKS SHALL BE INSTALLED ALONG THE TOP OF THE STREAM BANK ACROSS THE RIGHT-OF-WAY WHEN PUMP BYPASS IS NOT IN

DWG. NO.


S-175-C

OLD DRAWING NO.

CHRISTOPHER D. ANTON

PE-057385-E

REV. NO.

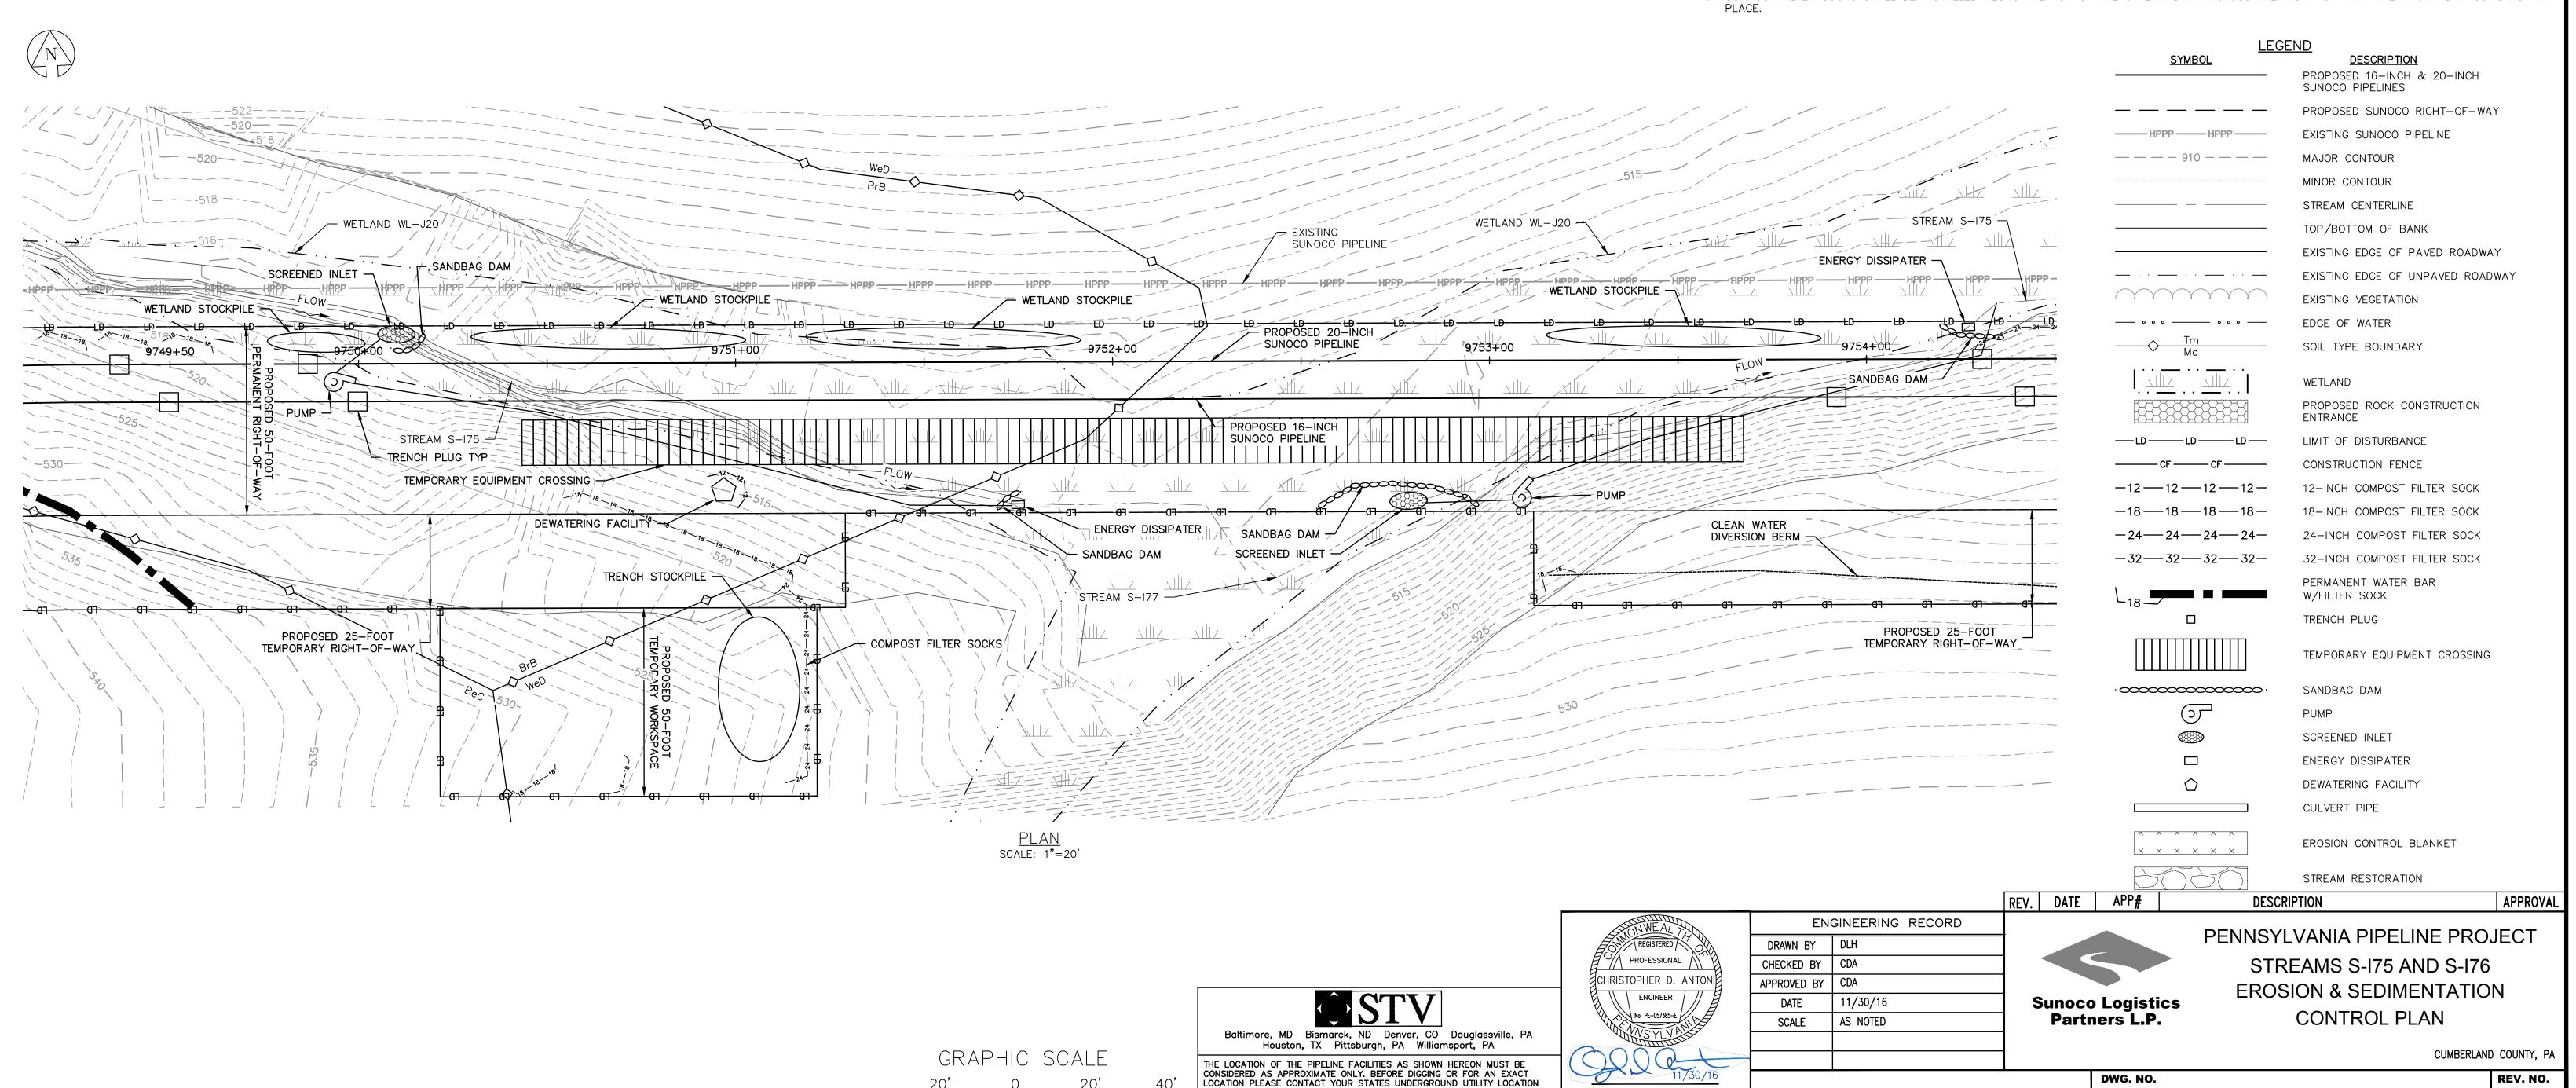

STV PROJECT No.: 38-17335


- 1. REFERENCE E&S PLAN AND SITE RESTORATION NOTES AND DETAILS FOR ADDITIONAL CONSTRUCTION SEQUENCING, TYPICAL DETAILS AND NOTES (ES-0.01-ES-0.23); AND PLAN SHEETS FOR ADDITIONAL PLANS AND TOPOGRAPHY.
- 2. ALL EXISTING UTILITY INFORMATION IS APPROXIMATE. THE CONTRACTOR IS RESPONSIBLE FOR VERIFYING ALL EXISTING UTILITIES PRIOR TO CONSTRUCTION.
- 3. MAINTAIN 2'-0" MINIMUM VERTICAL SEPARATION BETWEEN THE PROPOSED PIPELINE AND OTHER UTILITIES.
- 4. THE BACKGROUND TOPOGRAPHY WAS OBTAINED FROM TOPOGRAPHIC SURVEYS PERFORMED IN SEPTEMBER 2016.
- 5. THE PROJECT IS LOCATED IN NAD83 PENNSYLVANIA STATE PLANE COORDINATE SYSTEM (SOUTH ZONE), NAVD88.
- 6. EXCAVATION IS LIMITED TO THE CENTERLINE WITH A TYPICAL TRENCH WIDTH OF 4-5'FOR 16/20"PIPELINE.


### WETLAND CROSSING NOTES:


- 1. REFERENCE NOTES AND DETAILS FOR WETLAND CONSTRUCTION SEQUENCING AND WETLAND RESTORATION (ES-0.03, ES-0.08, ES-0.10, AND ES-0.15).
- 2. A MINIMUM OF 4 FEET COVER UNDER WETLANDS AND UPLANDS IS REQUIRED.
- 3. FOR TEMPORARY TIMBER MAT REFERENCE (ES-0.10)
- 4. EROSION CONTROL BLANKET SHALL BE PLACED A MINIMUM OF 50 FEET EDGE OF WETLAND OR 100 FEET FROM EDGE OF WETLAND FOR SPECIAL PROTECTION WATERS (HQ OR EV).


### STREAM CROSSING NOTES:

- 1. REFERENCE NOTES AND DETAILS FOR STREAM CONSTRUCTION SEQUENCING AND STREAM RESTORATION (ES-0.01-ES-0.17).
- 2. FOR TEMPORARY EQUIPMENT CROSSINGS REFERENCE (ES-0.10).
- 3. SITE CONDITIONS MAY ALLOW FOR IMPLEMENTATION OF OTHER APPROVED PIPELINE INSTALLATION METHODS REFERENCED WITH THE NOTES AND DETAILS (ES-0.11-ES-0.14).
- 4. THE PIPELINES SHALL MAINTAIN A MINIMUM OF 5 FEET OF COVER UNDER STREAMS FROM THE TOP OF PIPE TO THE STREAM BED. THIS COVER WILL BE MAINTAINED AT A MINIMUM FROM TOP OF BANK TO TOP OF BANK.
- 5. REFERENCE THE STREAM BANK STABILIZATION DETAIL AND STREAM RESTORATION TABLE IN THE NOTES AND DETAILS WHERE RIP-RAP IS PROPOSED (ES-0.18).
- 6. EROSION CONTROL BLANKET SHALL BE PLACED A MINIMUM OF 50 FEET FROM TOP OF BANK OR 100 FEET FROM TOP OF BANK FOR SPECIAL PROTECTION WATERS (HQ OR EV).
- 7. TIMBER MATS SHALL EXTEND A MINIMUM OF 20 FEET BEYOND TOP OF BANK.
- 8. COMPOST FILTER SOCKS SHALL BE INSTALLED ALONG THE TOP OF THE STREAM BANK ACROSS THE RIGHT-OF-WAY WHEN PUMP BYPASS IS NOT IN PLACE.

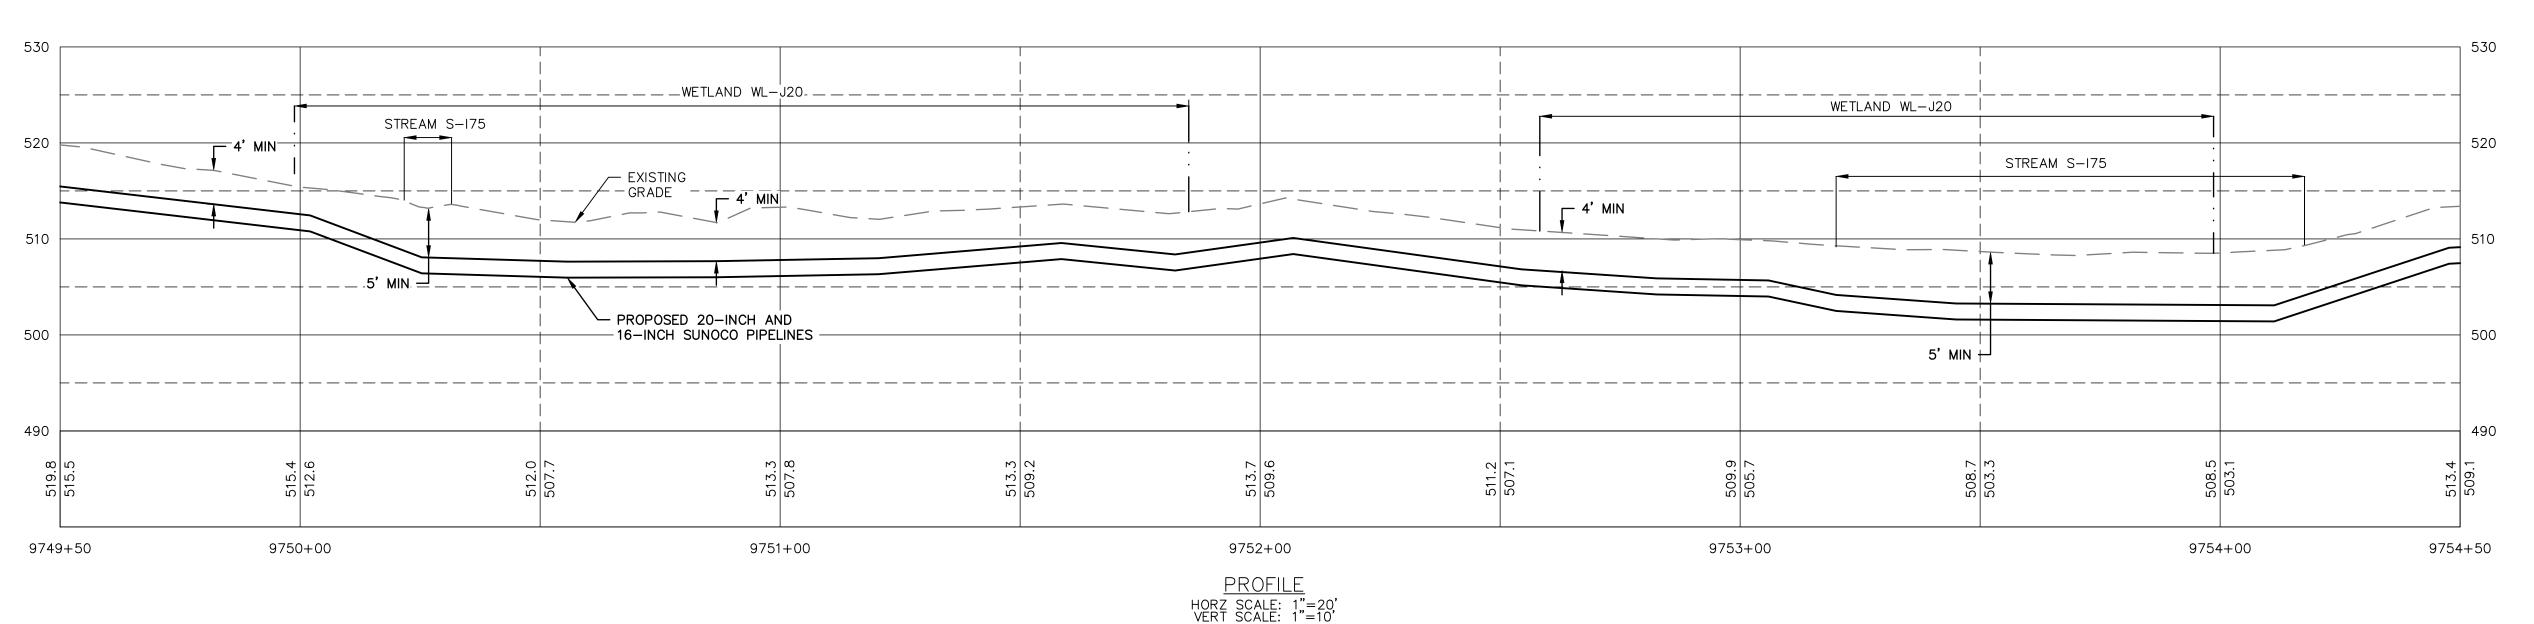

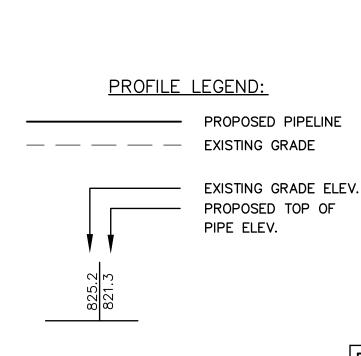

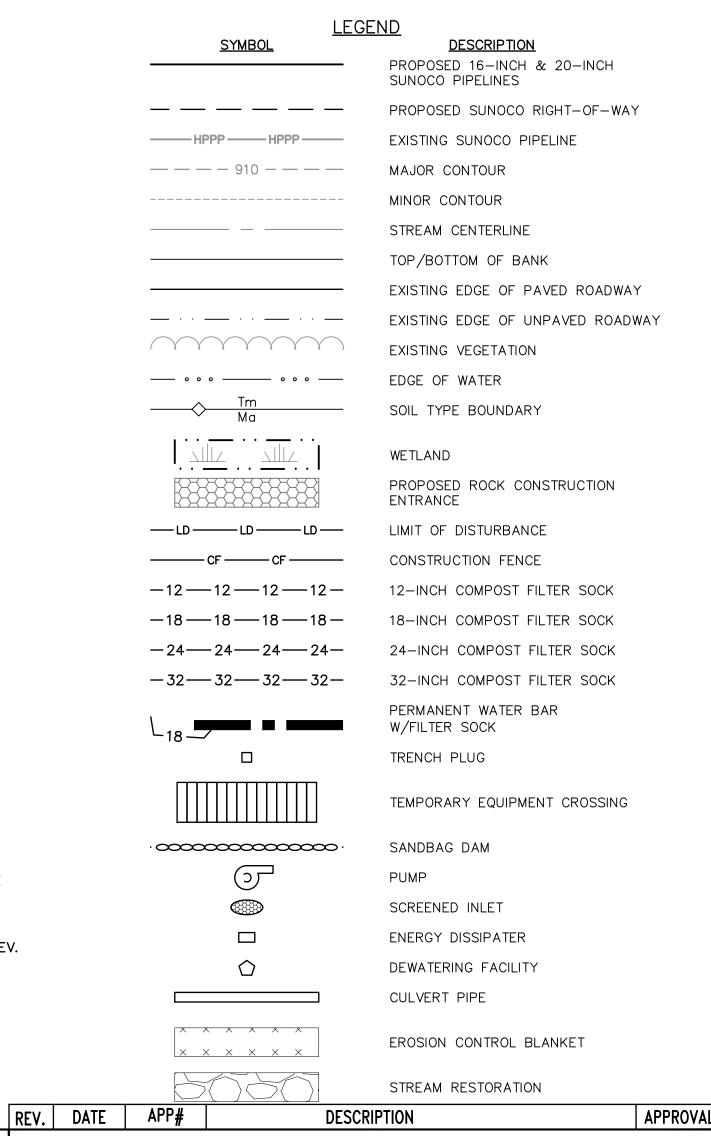

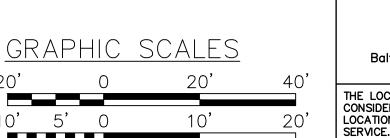

Baltimore, MD Bismarck, ND Denver, CO Douglassville, PA Houston, TX Pittsburgh, PA Williamsport, PA THE LOCATION OF THE PIPELINE FACILITIES AS SHOWN HEREON MUST BE CONSIDERED AS APPROXIMATE ONLY. BEFORE DIGGING OR FOR AN EXACT LOCATION PLEASE CONTACT YOUR STATES UNDERGROUND UTILITY LOCATION

ENGINEERING RECORD DRAWN BY DLH CHECKED BY CDA APPROVED BY CDA 11/30/16 DATE SCALE AS NOTED

OLD DRAWING NO.

REGISTERED

PROFESSIONAL

CHRISTOPHER D. ANTONIE

× No. PE-057385-E ✓

CHRISTOPHER D. ANTON

PE-057385-E

**Sunoco Logistics** Partners L.P.


PENNSYLVANIA PIPELINE PROJECT STREAMS S-I75 AND S-I76 **EROSION & SEDIMENTATION** CONTROL PROFILE


CUMBERLAND COUNTY, PA

REV. NO.

DWG. NO. S-175-D

STV PROJECT No.: 38-17335

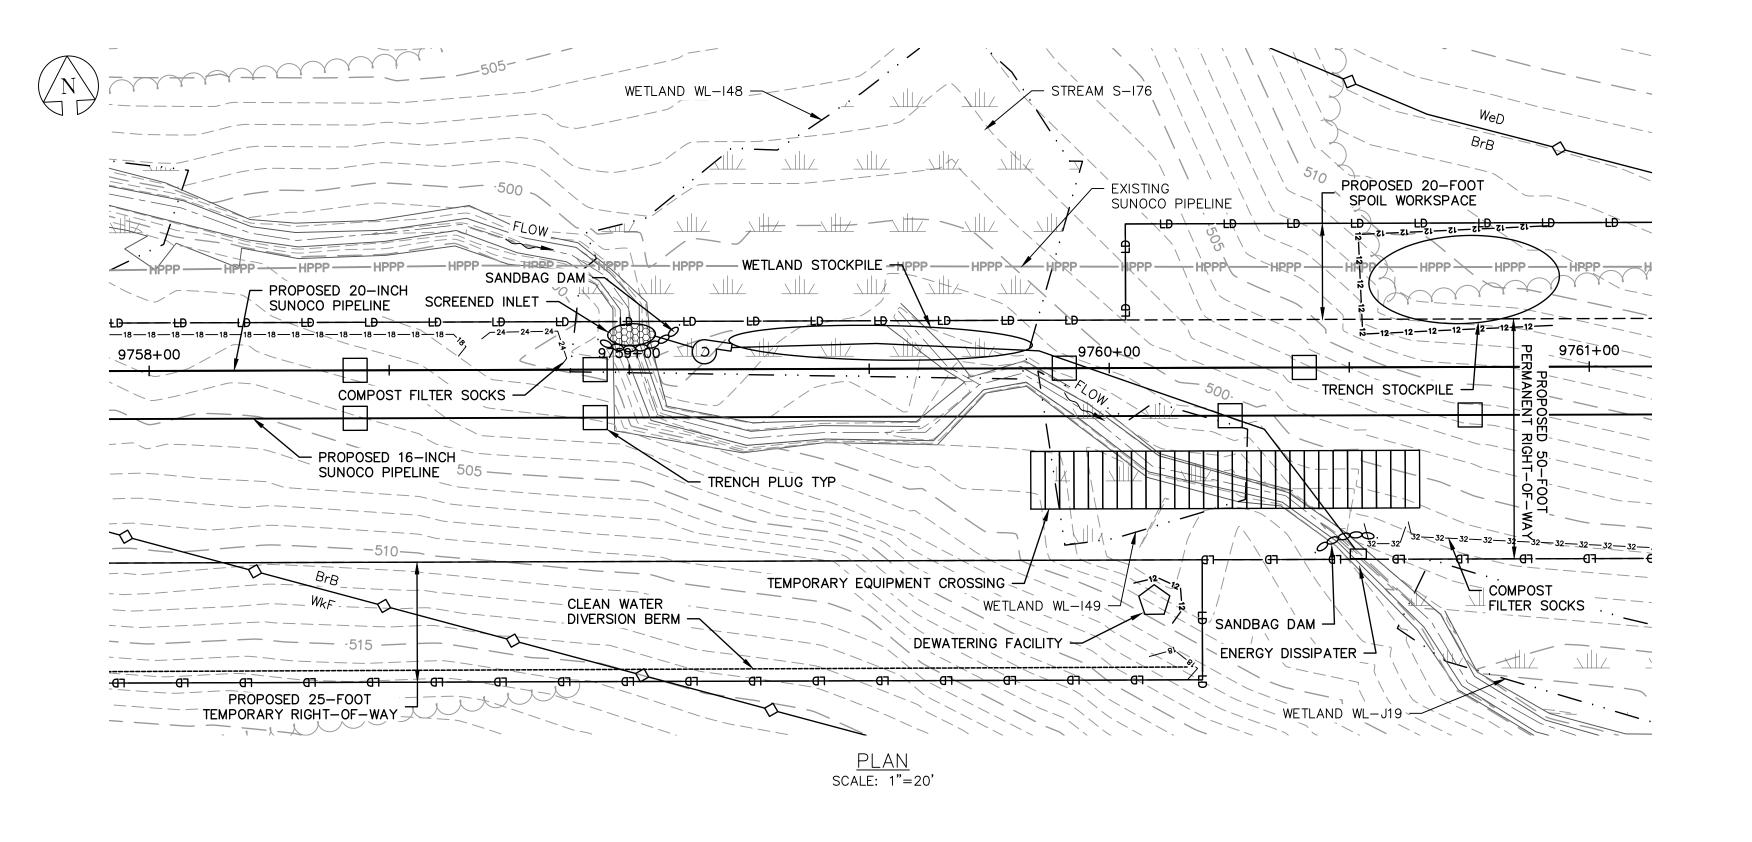

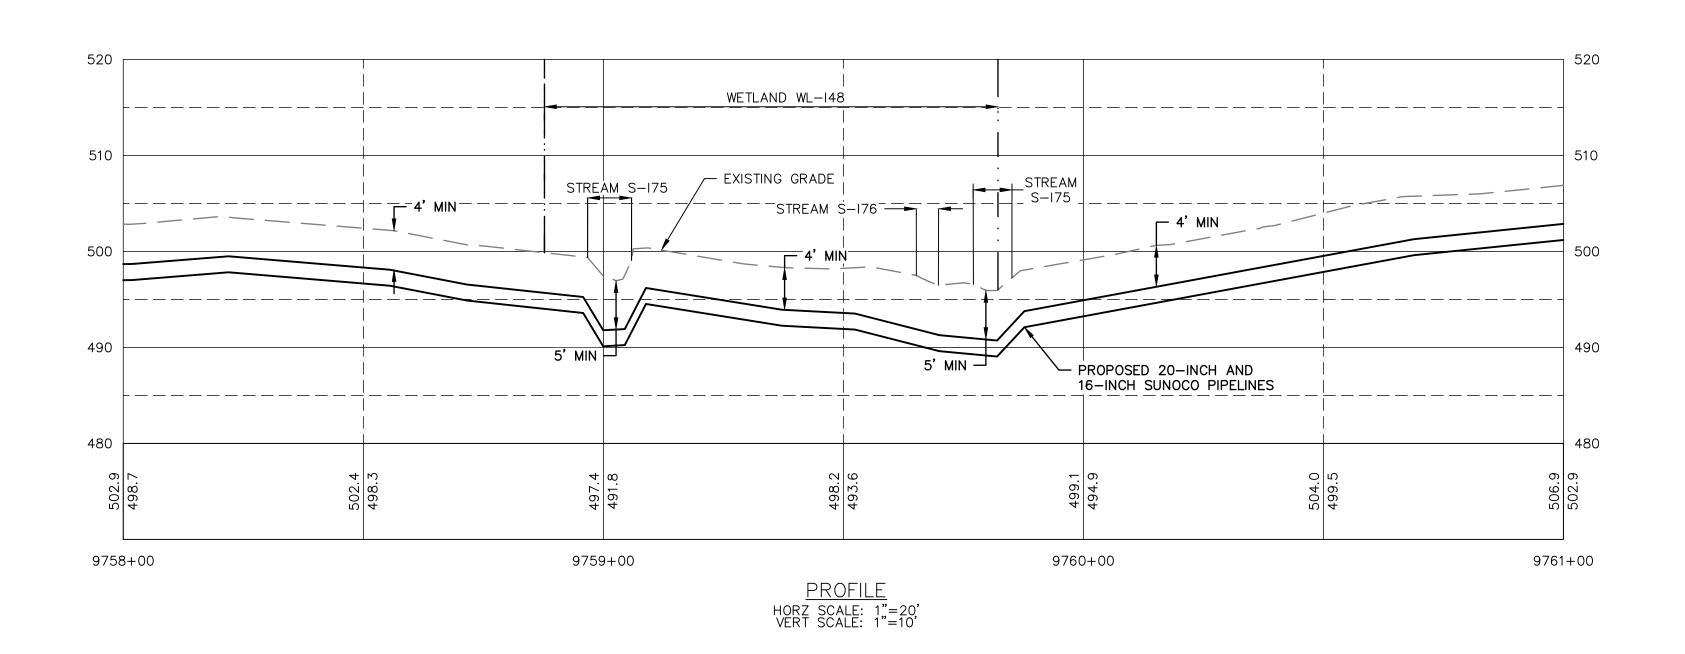

CONSTRUCTION.

- 1. REFERENCE E&S PLAN AND SITE RESTORATION NOTES AND DETAILS FOR ADDITIONAL CONSTRUCTION SEQUENCING, TYPICAL DETAILS AND NOTES (ES-0.01-ES-0.23); AND PLAN SHEETS FOR ADDITIONAL PLANS AND TOPOGRAPHY.
- 2. ALL EXISTING UTILITY INFORMATION IS APPROXIMATE. THE CONTRACTOR IS RESPONSIBLE FOR VERIFYING ALL EXISTING UTILITIES PRIOR TO
- 3. MAINTAIN 2'-0" MINIMUM VERTICAL SEPARATION BETWEEN THE PROPOSED PIPELINE AND OTHER UTILITIES.
- 4. THE BACKGROUND TOPOGRAPHY WAS OBTAINED FROM TOPOGRAPHIC SURVEYS PERFORMED IN SEPTEMBER 2016.
- 5. THE PROJECT IS LOCATED IN NAD83 PENNSYLVANIA STATE PLANE COORDINATE SYSTEM (SOUTH ZONE), NAVD88.
- 6. EXCAVATION IS LIMITED TO THE CENTERLINE WITH A TYPICAL TRENCH WIDTH OF 4-5'FOR 16/20"PIPELINE.

### WETLAND CROSSING NOTES:


- 1. REFERENCE NOTES AND DETAILS FOR WETLAND CONSTRUCTION SEQUENCING AND WETLAND RESTORATION (ES-0.03, ES-0.08, ES-0.10, AND ES-0.15).
- 2. A MINIMUM OF 4 FEET COVER UNDER WETLANDS AND UPLANDS IS REQUIRED.
- 3. FOR TEMPORARY TIMBER MAT REFERENCE (ES-0.10)
- 4. EROSION CONTROL BLANKET SHALL BE PLACED A MINIMUM OF 50 FEET EDGE OF WETLAND OR 100 FEET FROM EDGE OF WETLAND FOR SPECIAL PROTECTION WATERS (HQ OR EV).


### STREAM CROSSING NOTES:

- 1. REFERENCE NOTES AND DETAILS FOR STREAM CONSTRUCTION SEQUENCING AND STREAM RESTORATION (ES-0.01-ES-0.17).
- 2. FOR TEMPORARY EQUIPMENT CROSSINGS REFERENCE (ES-0.10).
- 3. SITE CONDITIONS MAY ALLOW FOR IMPLEMENTATION OF OTHER APPROVED PIPELINE INSTALLATION METHODS REFERENCED WITH THE NOTES AND DETAILS (ES-0.11-ES-0.14).
- 4. THE PIPELINES SHALL MAINTAIN A MINIMUM OF 5 FEET OF COVER UNDER STREAMS FROM THE TOP OF PIPE TO THE STREAM BED. THIS COVER WILL BE MAINTAINED AT A MINIMUM FROM TOP OF BANK TO TOP OF BANK.
- (ES-0.18).


5. REFERENCE THE STREAM BANK STABILIZATION DETAIL AND STREAM RESTORATION TABLE IN THE NOTES AND DETAILS WHERE RIP-RAP IS PROPOSED

- 6. EROSION CONTROL BLANKET SHALL BE PLACED A MINIMUM OF 50 FEET FROM TOP OF BANK OR 100 FEET FROM TOP OF BANK FOR SPECIAL PROTECTION WATERS (HQ OR EV).
- 7. TIMBER MATS SHALL EXTEND A MINIMUM OF 20 FEET BEYOND TOP OF BANK.
- 8. COMPOST FILTER SOCKS SHALL BE INSTALLED ALONG THE TOP OF THE STREAM BANK ACROSS THE RIGHT-OF-WAY WHEN PUMP BYPASS IS NOT IN

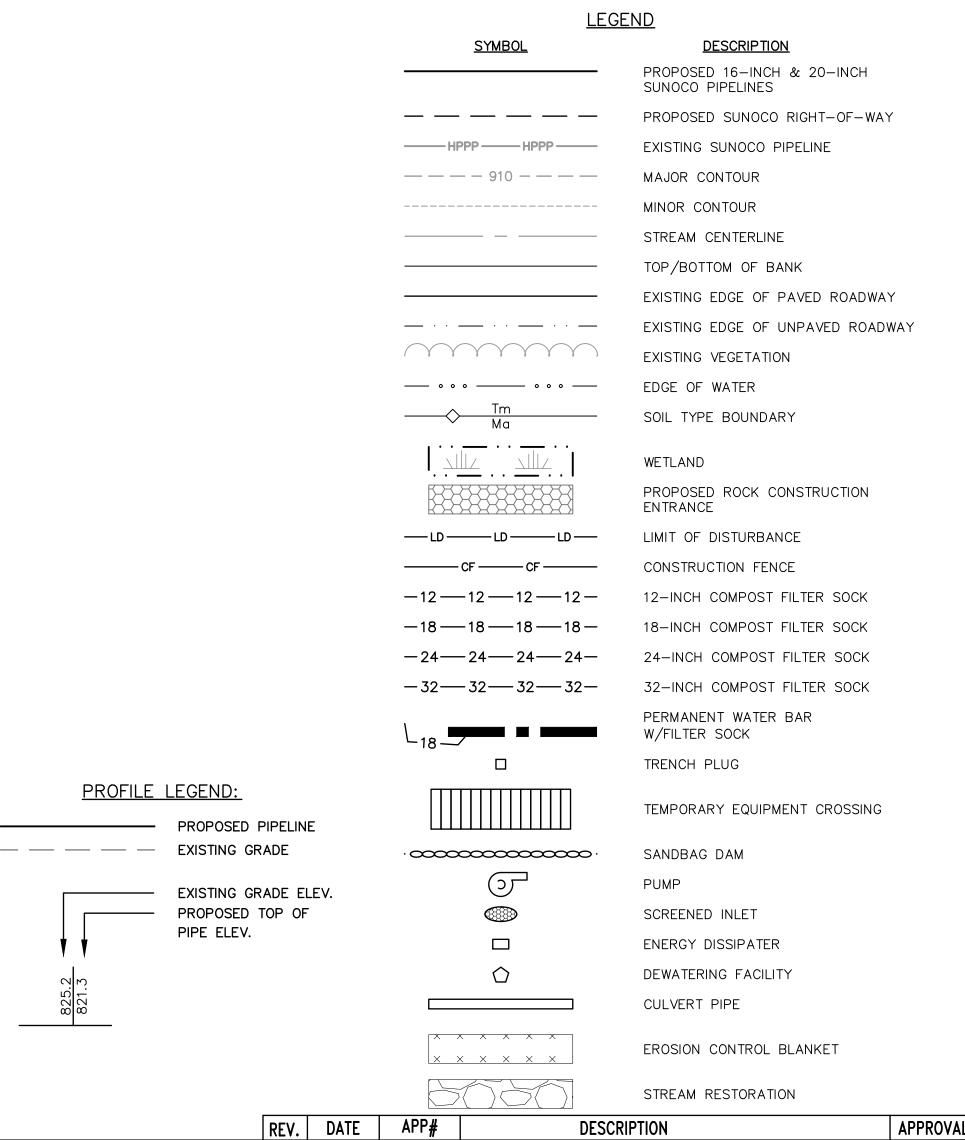

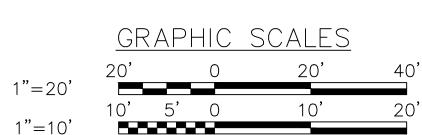



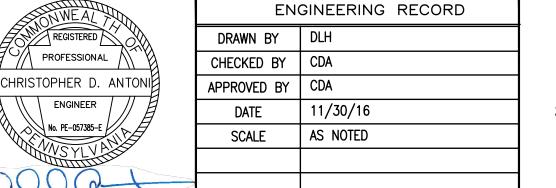

OLD DRAWING NO.

PROFESSIONAL

No. PE-057385-E /

CHRISTOPHER D. ANTON

PE-057385-E



PENNSYLVANIA PIPELINE PROJECT STREAMS S-I75 AND S-I76 **EROSION & SEDIMENTATION** CONTROL PLAN AND PROFILE

CUMBERLAND COUNTY, PA

REV. NO.

DWG. NO. S-175-E

# GENERAL NOTES: 1. REFERENCE E&S PLAN AND SITE RESTORATION NOTES AND DETAILS FOR ADDITIONAL CONSTRUCTION SEQUENCING, TYPICAL DETAILS AND NOTES (ES-0.01-ES-0.23); AND PLAN SHEETS FOR ADDITIONAL PLANS AND TOPOGRAPHY. 2. ALL EXISTING UTILITY INFORMATION IS APPROXIMATE. THE CONTRACTOR IS RESPONSIBLE FOR VERIFYING ALL EXISTING UTILITES PRIOR TO CONSTRUCTION. 3. MAINTAIN 2'-0' MINIMUM VERTICAL SEPARATION BETWEEN THE PROPOSED PPELINE AND OTHER UTILITIES. 4. THE BACKGROUND TOPOGRAPHY WAS OBTAINED FROM TOPOGRAPHIC SURVEYS PERFORMED IN SEPTEMBER 2016. 5. THE PROJECT IS LOCATED IN NABB3 PENNSYLVANIA STATE PLANE COORDINATE SYSTEM (SOUTH ZONE), NAVOBB. 6. EXCAVATION IS LIMITED TO THE CENTERLINE WITH A TYPICAL TRENCH WIDTH OF 4-5/FOR 18/20'PIPELINE. WETLAND\_CROSSING\_NOTES: 1. REFERENCE NOTES AND DETAILS FOR WETLAND CONSTRUCTION SEQUENCING AND WETLAND RESTORATION (ES-0.03, ES-0.08, ES-0.10, AND ES-0.015).

- 2. A MINIMUM OF 4 FEET COVER UNDER WETLANDS AND UPLANDS IS REQUIRED.
- 3. FOR TEMPORARY TIMBER MAT REFERENCE (ES-0.10)
- 4. EROSION CONTROL BLANKET SHALL BE PLACED A MINIMUM OF 50 FEET EDGE OF WETLAND OR 100 FEET FROM EDGE OF WETLAND FOR SPECIAL PROTECTION WATERS (HQ OR EV).

### STREAM CROSSING NOTES:

- 1. REFERENCE NOTES AND DETAILS FOR STREAM CONSTRUCTION SEQUENCING AND STREAM RESTORATION (ES-0.01-ES-0.17).
- 2. FOR TEMPORARY EQUIPMENT CROSSINGS REFERENCE (ES-0.10).
- 3. SITE CONDITIONS MAY ALLOW FOR IMPLEMENTATION OF OTHER APPROVED PIPELINE INSTALLATION METHODS REFERENCED WITH THE NOTES AND DETAILS (ES-0.11-ES-0.14).
- 4. THE PIPELINES SHALL MAINTAIN A MINIMUM OF 5 FEET OF COVER UNDER STREAMS FROM THE TOP OF PIPE TO THE STREAM BED. THIS COVER WILL BE MAINTAINED AT A MINIMUM FROM TOP OF BANK TO TOP OF BANK.
- (ES-0.18).

5. REFERENCE THE STREAM BANK STABILIZATION DETAIL AND STREAM RESTORATION TABLE IN THE NOTES AND DETAILS WHERE RIP-RAP IS PROPOSED

6. EROSION CONTROL BLANKET SHALL BE PLACED A MINIMUM OF 50 FEET FROM TOP OF BANK OR 100 FEET FROM TOP OF BANK FOR SPECIAL PROTECTION WATERS (HQ OR EV).

**Sunoco Logistics** 

Partners L.P.

DWG. NO.

S-175-F

11/30/16

AS NOTED

OLD DRAWING NO.

DATE

SCALE

No. PE-057385-E

CHRISTOPHER D. ANTON


PE-057385-E

- 7. TIMBER MATS SHALL EXTEND A MINIMUM OF 20 FEET BEYOND TOP OF BANK.
- 8. COMPOST FILTER SOCKS SHALL BE INSTALLED ALONG THE TOP OF THE STREAM BANK ACROSS THE RIGHT-OF-WAY WHEN PUMP BYPASS IS NOT IN PLACE.

RESTORATION PLAN

CUMBERLAND COUNTY, PA

REV. NO.

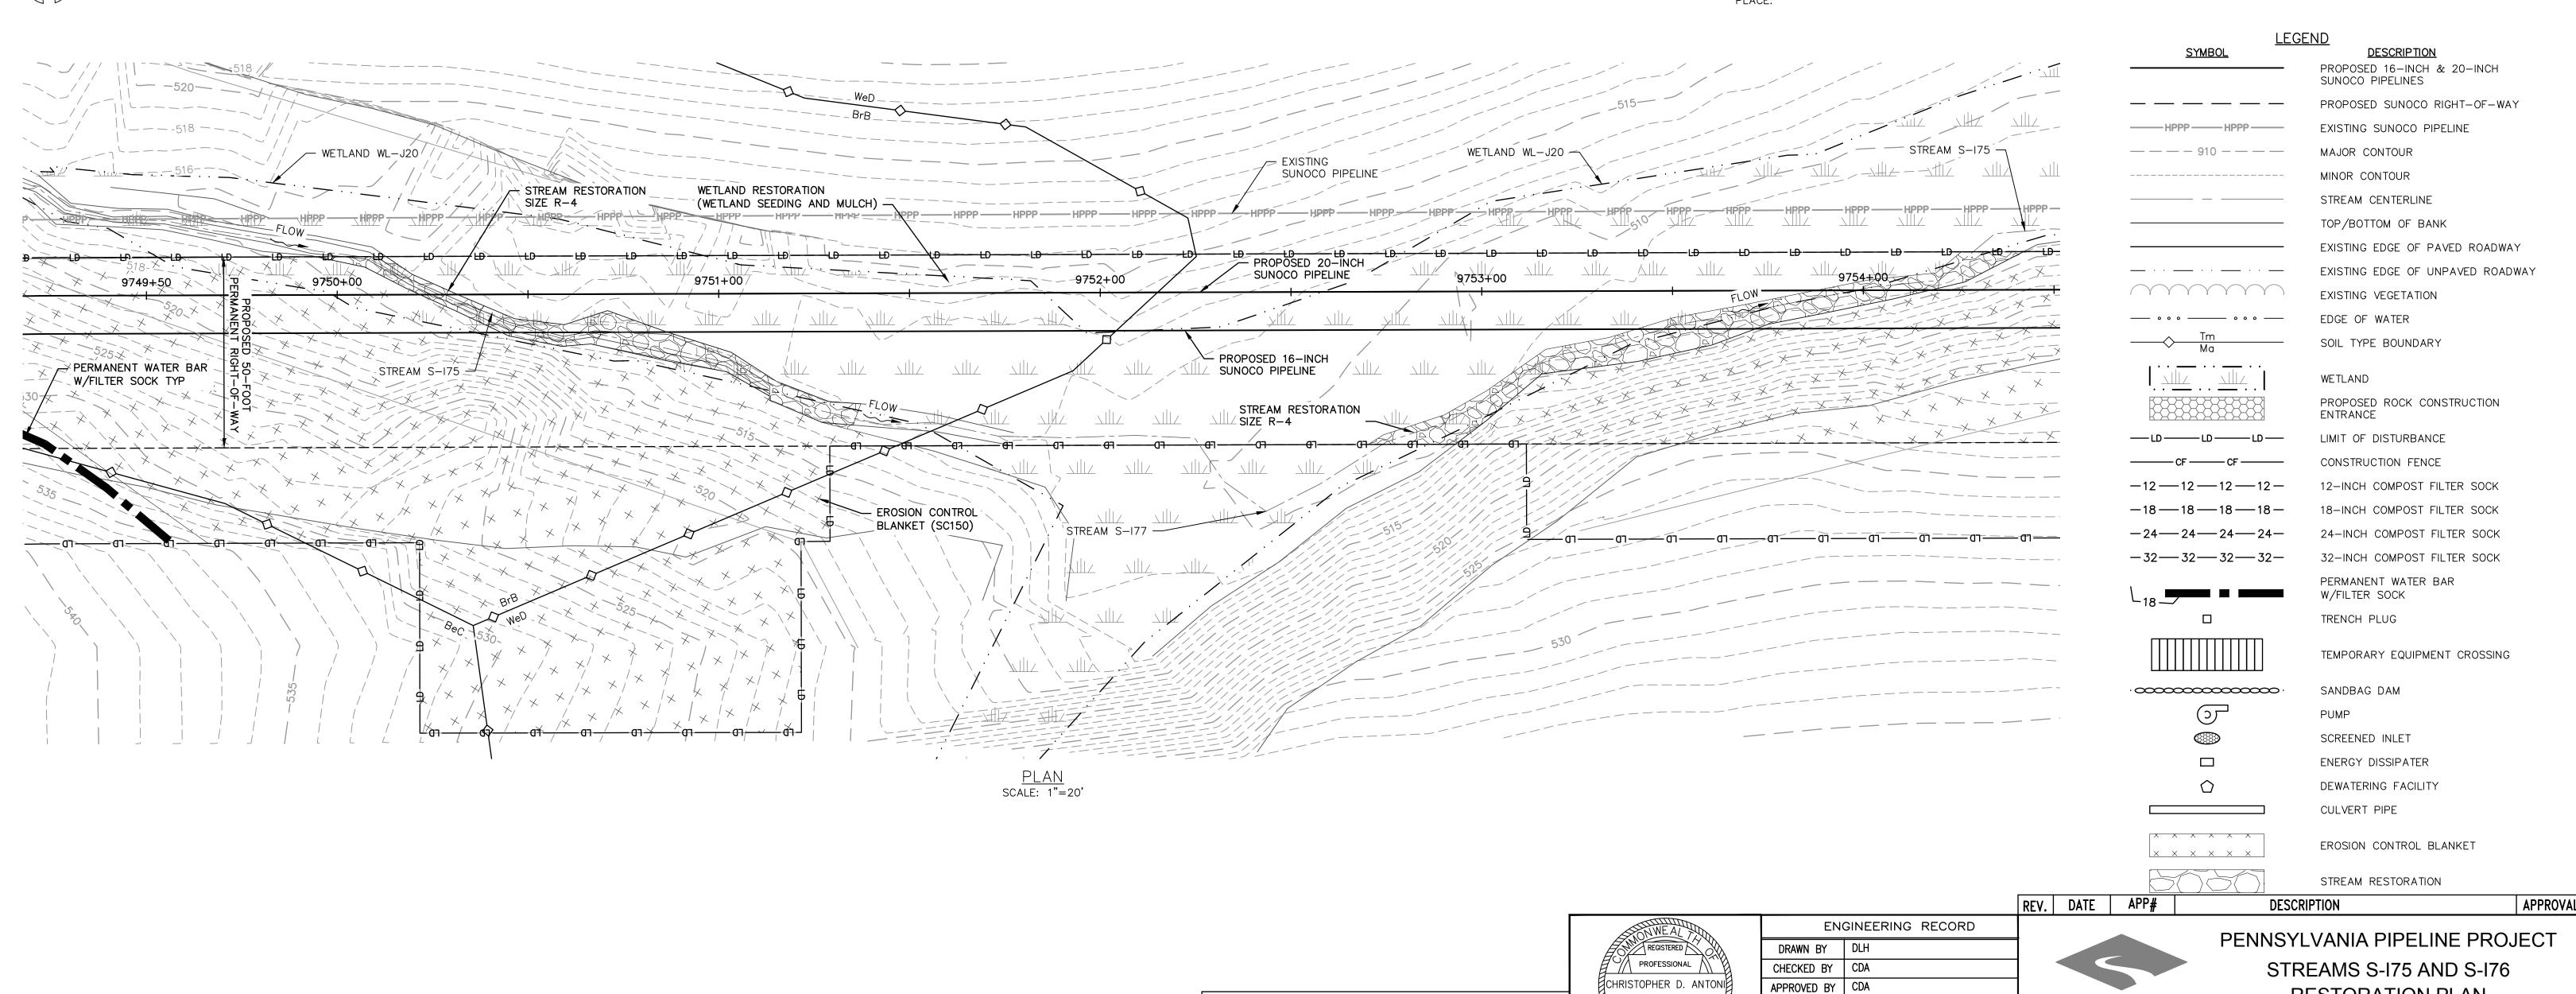

Baltimore, MD Bismarck, ND Denver, CO Douglassville, PA Houston, TX Pittsburgh, PA Williamsport, PA

THE LOCATION OF THE PIPELINE FACILITIES AS SHOWN HEREON MUST BE CONSIDERED AS APPROXIMATE ONLY. BEFORE DIGGING OR FOR AN EXACT LOCATION PLEASE CONTACT YOUR STATES UNDERGROUND UTILITY LOCATION

STV PROJECT No.: 38-17335

- 1. REFERENCE E&S PLAN AND SITE RESTORATION NOTES AND DETAILS FOR ADDITIONAL CONSTRUCTION SEQUENCING, TYPICAL DETAILS AND NOTES (ES-0.01-ES-0.23); AND PLAN SHEETS FOR ADDITIONAL PLANS AND TOPOGRAPHY.
- 2. ALL EXISTING UTILITY INFORMATION IS APPROXIMATE. THE CONTRACTOR IS RESPONSIBLE FOR VERIFYING ALL EXISTING UTILITIES PRIOR TO
- 3. MAINTAIN 2'-0" MINIMUM VERTICAL SEPARATION BETWEEN THE PROPOSED PIPELINE AND OTHER UTILITIES.
- 4. THE BACKGROUND TOPOGRAPHY WAS OBTAINED FROM TOPOGRAPHIC SURVEYS PERFORMED IN SEPTEMBER 2016.
- 5. THE PROJECT IS LOCATED IN NAD83 PENNSYLVANIA STATE PLANE COORDINATE SYSTEM (SOUTH ZONE), NAVD88.
- 6. EXCAVATION IS LIMITED TO THE CENTERLINE WITH A TYPICAL TRENCH WIDTH OF 4-5'FOR 16/20"PIPELINE.

### WETLAND CROSSING NOTES:

CONSTRUCTION.

- 1. REFERENCE NOTES AND DETAILS FOR WETLAND CONSTRUCTION SEQUENCING AND WETLAND RESTORATION (ES-0.03, ES-0.08, ES-0.10, AND ES-0.15).
- 2. A MINIMUM OF 4 FEET COVER UNDER WETLANDS AND UPLANDS IS REQUIRED.
- 3. FOR TEMPORARY TIMBER MAT REFERENCE (ES-0.10)
- 4. EROSION CONTROL BLANKET SHALL BE PLACED A MINIMUM OF 50 FEET EDGE OF WETLAND OR 100 FEET FROM EDGE OF WETLAND FOR SPECIAL PROTECTION WATERS (HQ OR EV).

### STREAM CROSSING NOTES:


- 1. REFERENCE NOTES AND DETAILS FOR STREAM CONSTRUCTION SEQUENCING AND STREAM RESTORATION (ES-0.01-ES-0.17).
- 2. FOR TEMPORARY EQUIPMENT CROSSINGS REFERENCE (ES-0.10).
- 3. SITE CONDITIONS MAY ALLOW FOR IMPLEMENTATION OF OTHER APPROVED PIPELINE INSTALLATION METHODS REFERENCED WITH THE NOTES AND DETAILS (ES-0.11-ES-0.14).
- 4. THE PIPELINES SHALL MAINTAIN A MINIMUM OF 5 FEET OF COVER UNDER STREAMS FROM THE TOP OF PIPE TO THE STREAM BED. THIS COVER WILL BE MAINTAINED AT A MINIMUM FROM TOP OF BANK TO TOP OF BANK.
- 5. REFERENCE THE STREAM BANK STABILIZATION DETAIL AND STREAM RESTORATION TABLE IN THE NOTES AND DETAILS WHERE RIP-RAP IS PROPOSED (ES-0.18).
- 6. EROSION CONTROL BLANKET SHALL BE PLACED A MINIMUM OF 50 FEET FROM TOP OF BANK OR 100 FEET FROM TOP OF BANK FOR SPECIAL PROTECTION WATERS (HQ OR EV).
- 7. TIMBER MATS SHALL EXTEND A MINIMUM OF 20 FEET BEYOND TOP OF BANK.
- 8. COMPOST FILTER SOCKS SHALL BE INSTALLED ALONG THE TOP OF THE STREAM BANK ACROSS THE RIGHT-OF-WAY WHEN PUMP BYPASS IS NOT IN PLACE.

<u>SYMBOL</u>

<u>LEGEND</u>

**DESCRIPTION** 

PROPOSED 16-INCH & 20-INCH

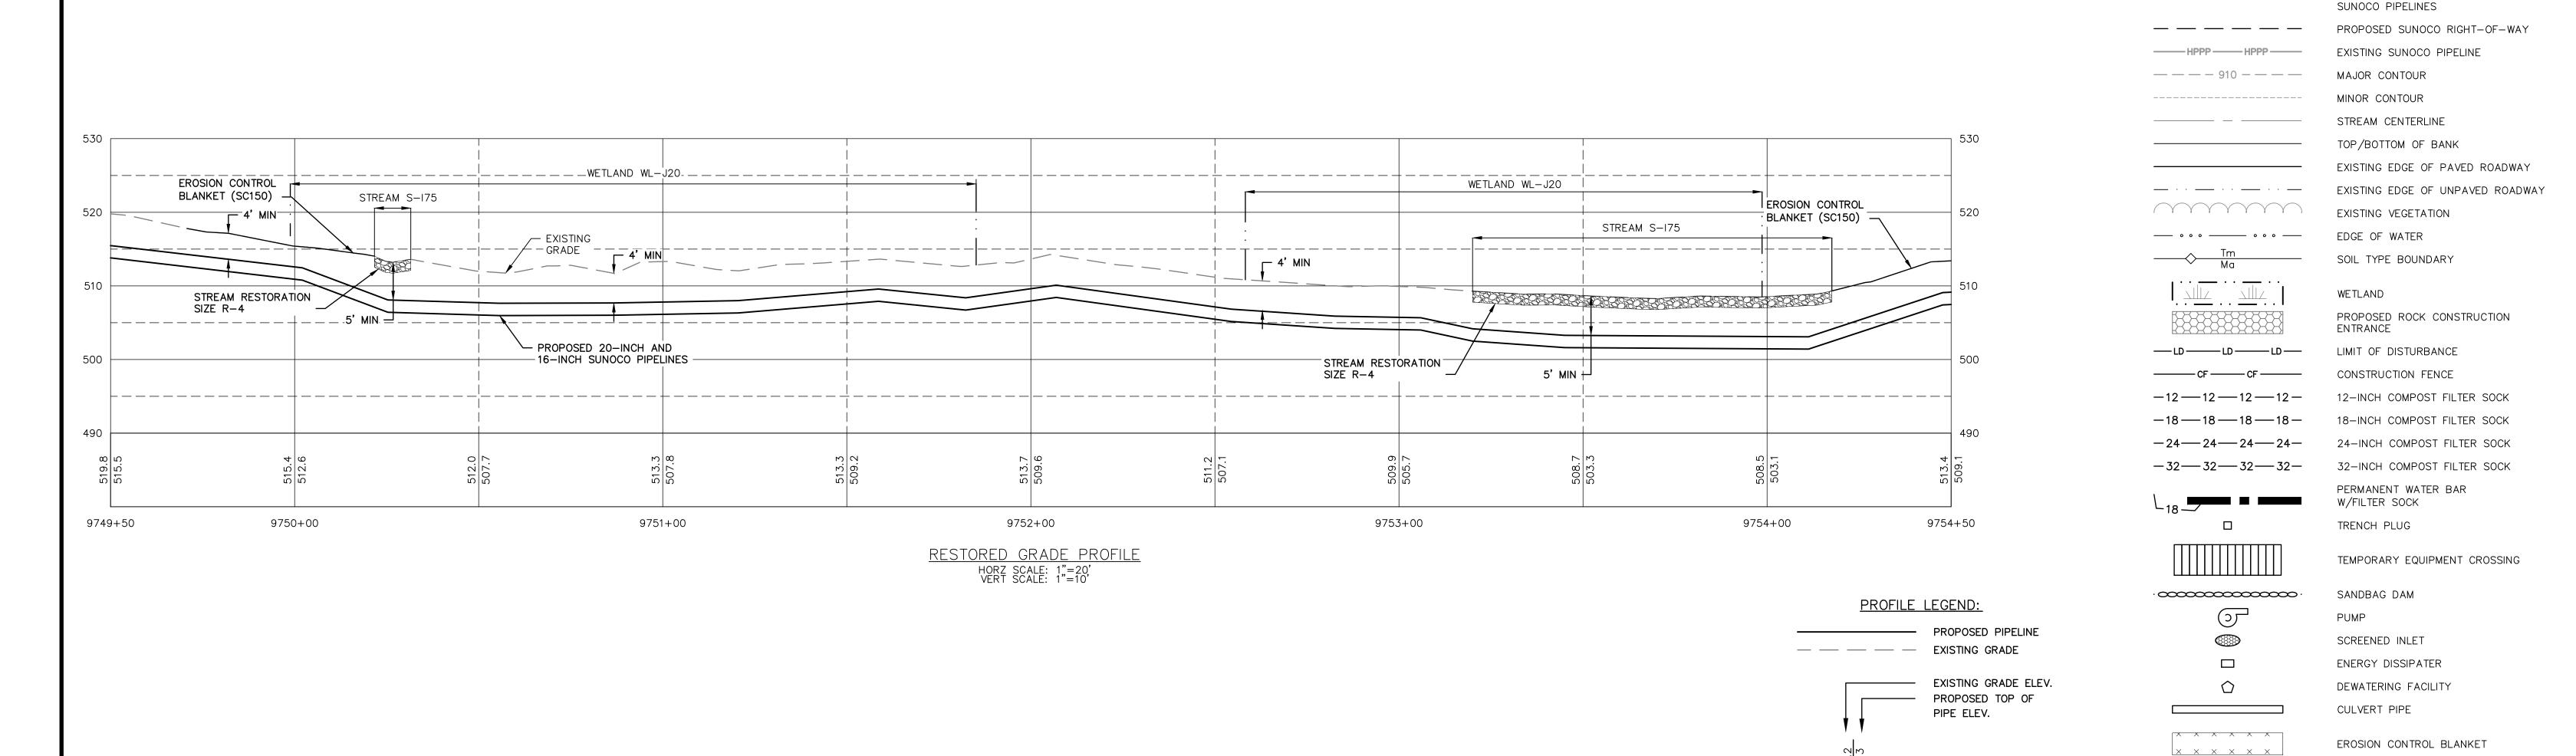

GRAPHIC SCALES

Baltimore, MD Bismarck, ND Denver, CO Douglassville, PA Houston, TX Pittsburgh, PA Williamsport, PA THE LOCATION OF THE PIPELINE FACILITIES AS SHOWN HEREON MUST BE CONSIDERED AS APPROXIMATE ONLY. BEFORE DIGGING OR FOR AN EXACT LOCATION PLEASE CONTACT YOUR STATES UNDERGROUND UTILITY LOCATION

REGISTERED PROFESSIONAL CHRISTOPHER D. ANTONI No. PE-057385-E /

DRAWN BY DLH CHECKED BY CDA APPROVED BY CDA 11/30/16 DATE SCALE AS NOTED

ENGINEERING RECORD

**Sunoco Logistics** Partners L.P.

REV. DATE APP#

PENNSYLVANIA PIPELINE PROJECT STREAMS S-I75 AND S-I76 RESTORATION PROFILE

STREAM RESTORATION

DESCRIPTION

CUMBERLAND COUNTY, PA

APPROVAL

CHRISTOPHER D. ANTON PE-057385-E


OLD DRAWING NO.


REV. NO.

STV PROJECT No.: 38-17335

S-175-G

DWG. NO.

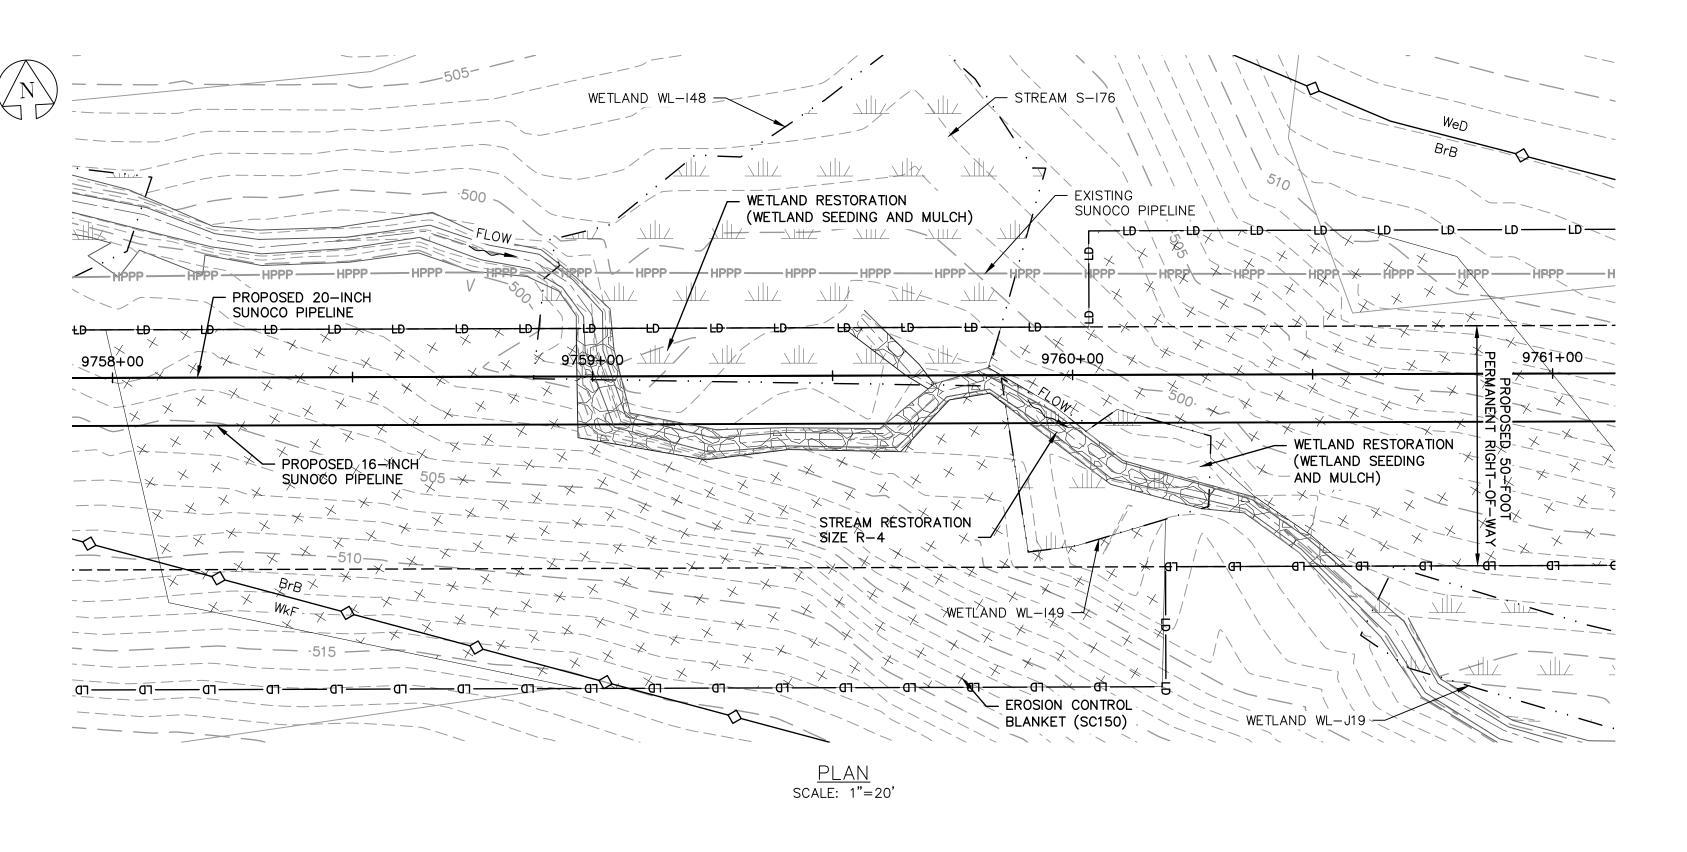

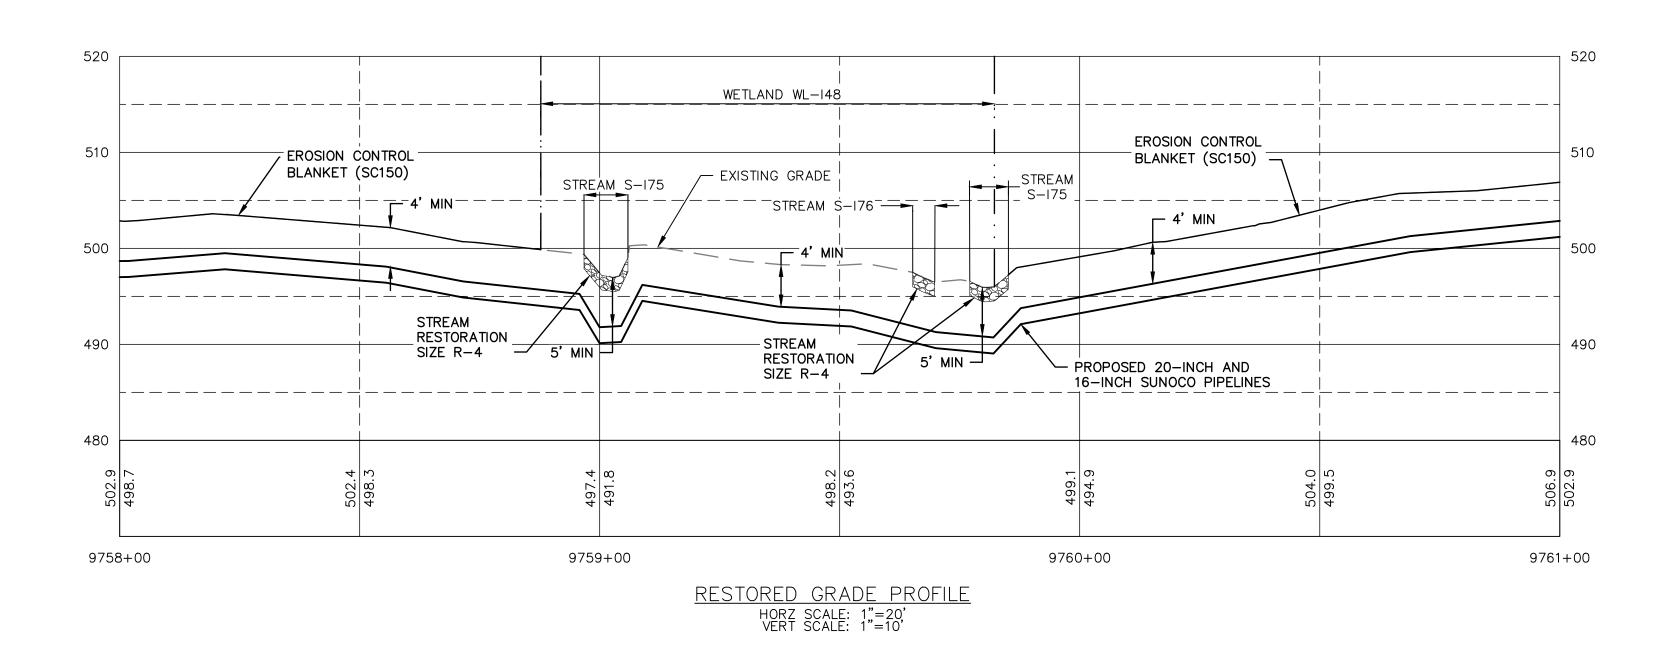

CONSTRUCTION.


- 1. REFERENCE E&S PLAN AND SITE RESTORATION NOTES AND DETAILS FOR ADDITIONAL CONSTRUCTION SEQUENCING, TYPICAL DETAILS AND NOTES (ES-0.01-ES-0.23); AND PLAN SHEETS FOR ADDITIONAL PLANS AND TOPOGRAPHY.
- 2. ALL EXISTING UTILITY INFORMATION IS APPROXIMATE. THE CONTRACTOR IS RESPONSIBLE FOR VERIFYING ALL EXISTING UTILITIES PRIOR TO
- 3. MAINTAIN 2'-0" MINIMUM VERTICAL SEPARATION BETWEEN THE PROPOSED PIPELINE AND OTHER UTILITIES.
- 4. THE BACKGROUND TOPOGRAPHY WAS OBTAINED FROM TOPOGRAPHIC SURVEYS PERFORMED IN SEPTEMBER 2016.
- 5. THE PROJECT IS LOCATED IN NAD83 PENNSYLVANIA STATE PLANE COORDINATE SYSTEM (SOUTH ZONE), NAVD88.
- 6. EXCAVATION IS LIMITED TO THE CENTERLINE WITH A TYPICAL TRENCH WIDTH OF 4-5'FOR 16/20"PIPELINE.


### WETLAND CROSSING NOTES:

- 1. REFERENCE NOTES AND DETAILS FOR WETLAND CONSTRUCTION SEQUENCING AND WETLAND RESTORATION (ES-0.03, ES-0.08, ES-0.10, AND ES-0.15).
- 2. A MINIMUM OF 4 FEET COVER UNDER WETLANDS AND UPLANDS IS REQUIRED.
- 3. FOR TEMPORARY TIMBER MAT REFERENCE (ES-0.10)
- 4. EROSION CONTROL BLANKET SHALL BE PLACED A MINIMUM OF 50 FEET EDGE OF WETLAND OR 100 FEET FROM EDGE OF WETLAND FOR SPECIAL PROTECTION WATERS (HQ OR EV).

### STREAM CROSSING NOTES:


- 1. REFERENCE NOTES AND DETAILS FOR STREAM CONSTRUCTION SEQUENCING AND STREAM RESTORATION (ES-0.01-ES-0.17).
- 2. FOR TEMPORARY EQUIPMENT CROSSINGS REFERENCE (ES-0.10).
- 3. SITE CONDITIONS MAY ALLOW FOR IMPLEMENTATION OF OTHER APPROVED PIPELINE INSTALLATION METHODS REFERENCED WITH THE NOTES AND DETAILS (ES-0.11-ES-0.14).
- 4. THE PIPELINES SHALL MAINTAIN A MINIMUM OF 5 FEET OF COVER UNDER STREAMS FROM THE TOP OF PIPE TO THE STREAM BED. THIS COVER WILL BE MAINTAINED AT A MINIMUM FROM TOP OF BANK TO TOP OF BANK.
- 5. REFERENCE THE STREAM BANK STABILIZATION DETAIL AND STREAM RESTORATION TABLE IN THE NOTES AND DETAILS WHERE RIP-RAP IS PROPOSED (ES-0.18).
- 6. EROSION CONTROL BLANKET SHALL BE PLACED A MINIMUM OF 50 FEET FROM TOP OF BANK OR 100 FEET FROM TOP OF BANK FOR SPECIAL PROTECTION WATERS (HQ OR EV).
- 7. TIMBER MATS SHALL EXTEND A MINIMUM OF 20 FEET BEYOND TOP OF BANK.
- 8. COMPOST FILTER SOCKS SHALL BE INSTALLED ALONG THE TOP OF THE STREAM BANK ACROSS THE RIGHT-OF-WAY WHEN PUMP BYPASS IS NOT IN

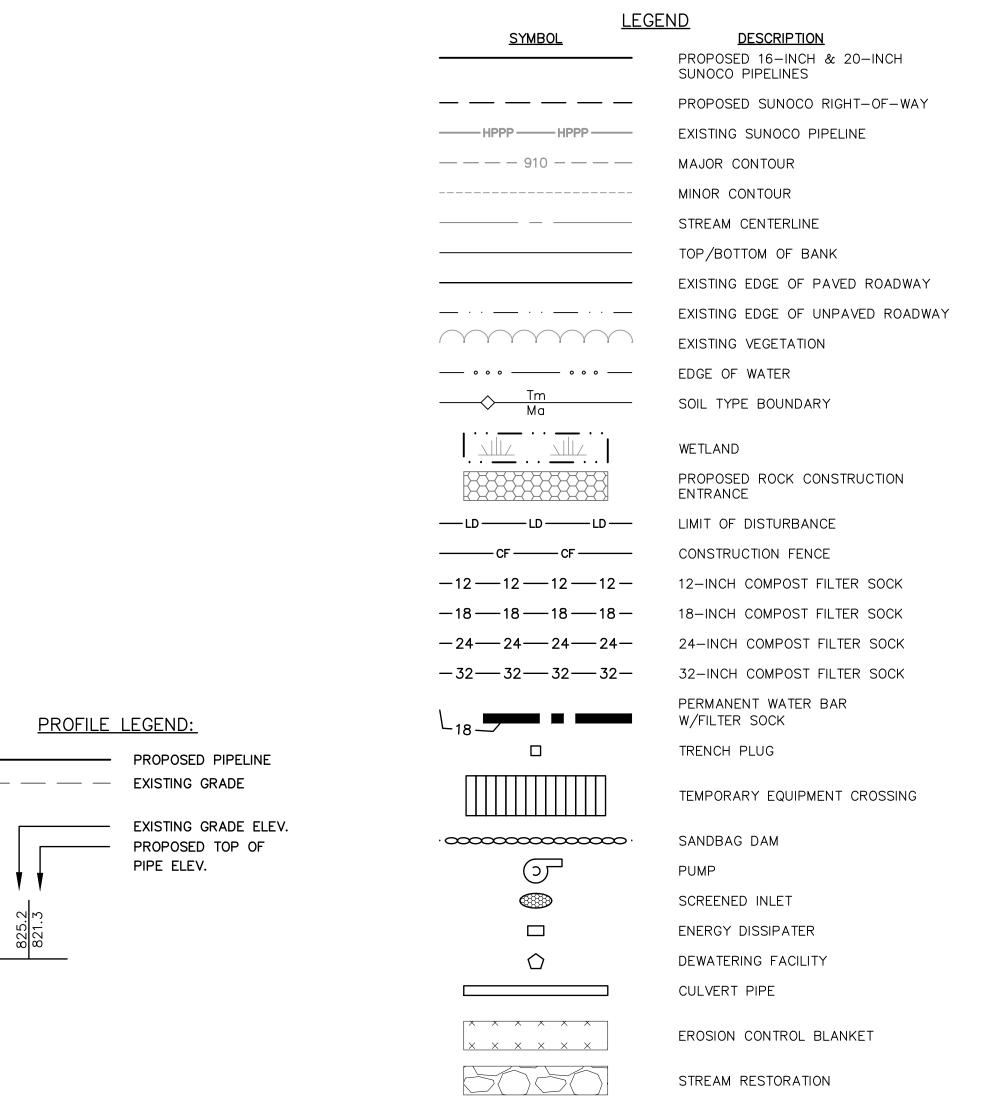

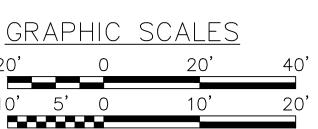

1"=10'

Baltimore, MD Bismarck, ND Denver, CO Douglassville, PA Houston, TX Pittsburgh, PA Williamsport, PA THE LOCATION OF THE PIPELINE FACILITIES AS SHOWN HEREON MUST BE CONSIDERED AS APPROXIMATE ONLY. BEFORE DIGGING OR FOR AN EXACT LOCATION PLEASE CONTACT YOUR STATES UNDERGROUND UTILITY LOCATION STV PROJECT No.: 38-17335

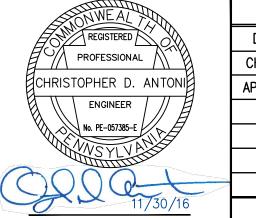

ENGINEERING RECORD DRAWN BY DLH CHECKED BY | CDA APPROVED BY CDA 11/30/16 DATE AS NOTED SCALE



Partners L.P.

PENNSYLVANIA PIPELINE PROJECT STREAMS S-I75 AND S-I76 RESTORATION PLAN AND PROFILE

CUMBERLAND COUNTY, PA

APPROVAL

REV. NO.


DWG. NO.

DESCRIPTION

CHRISTOPHER D. ANTON PE-057385-E

OLD DRAWING NO.

S-175-H

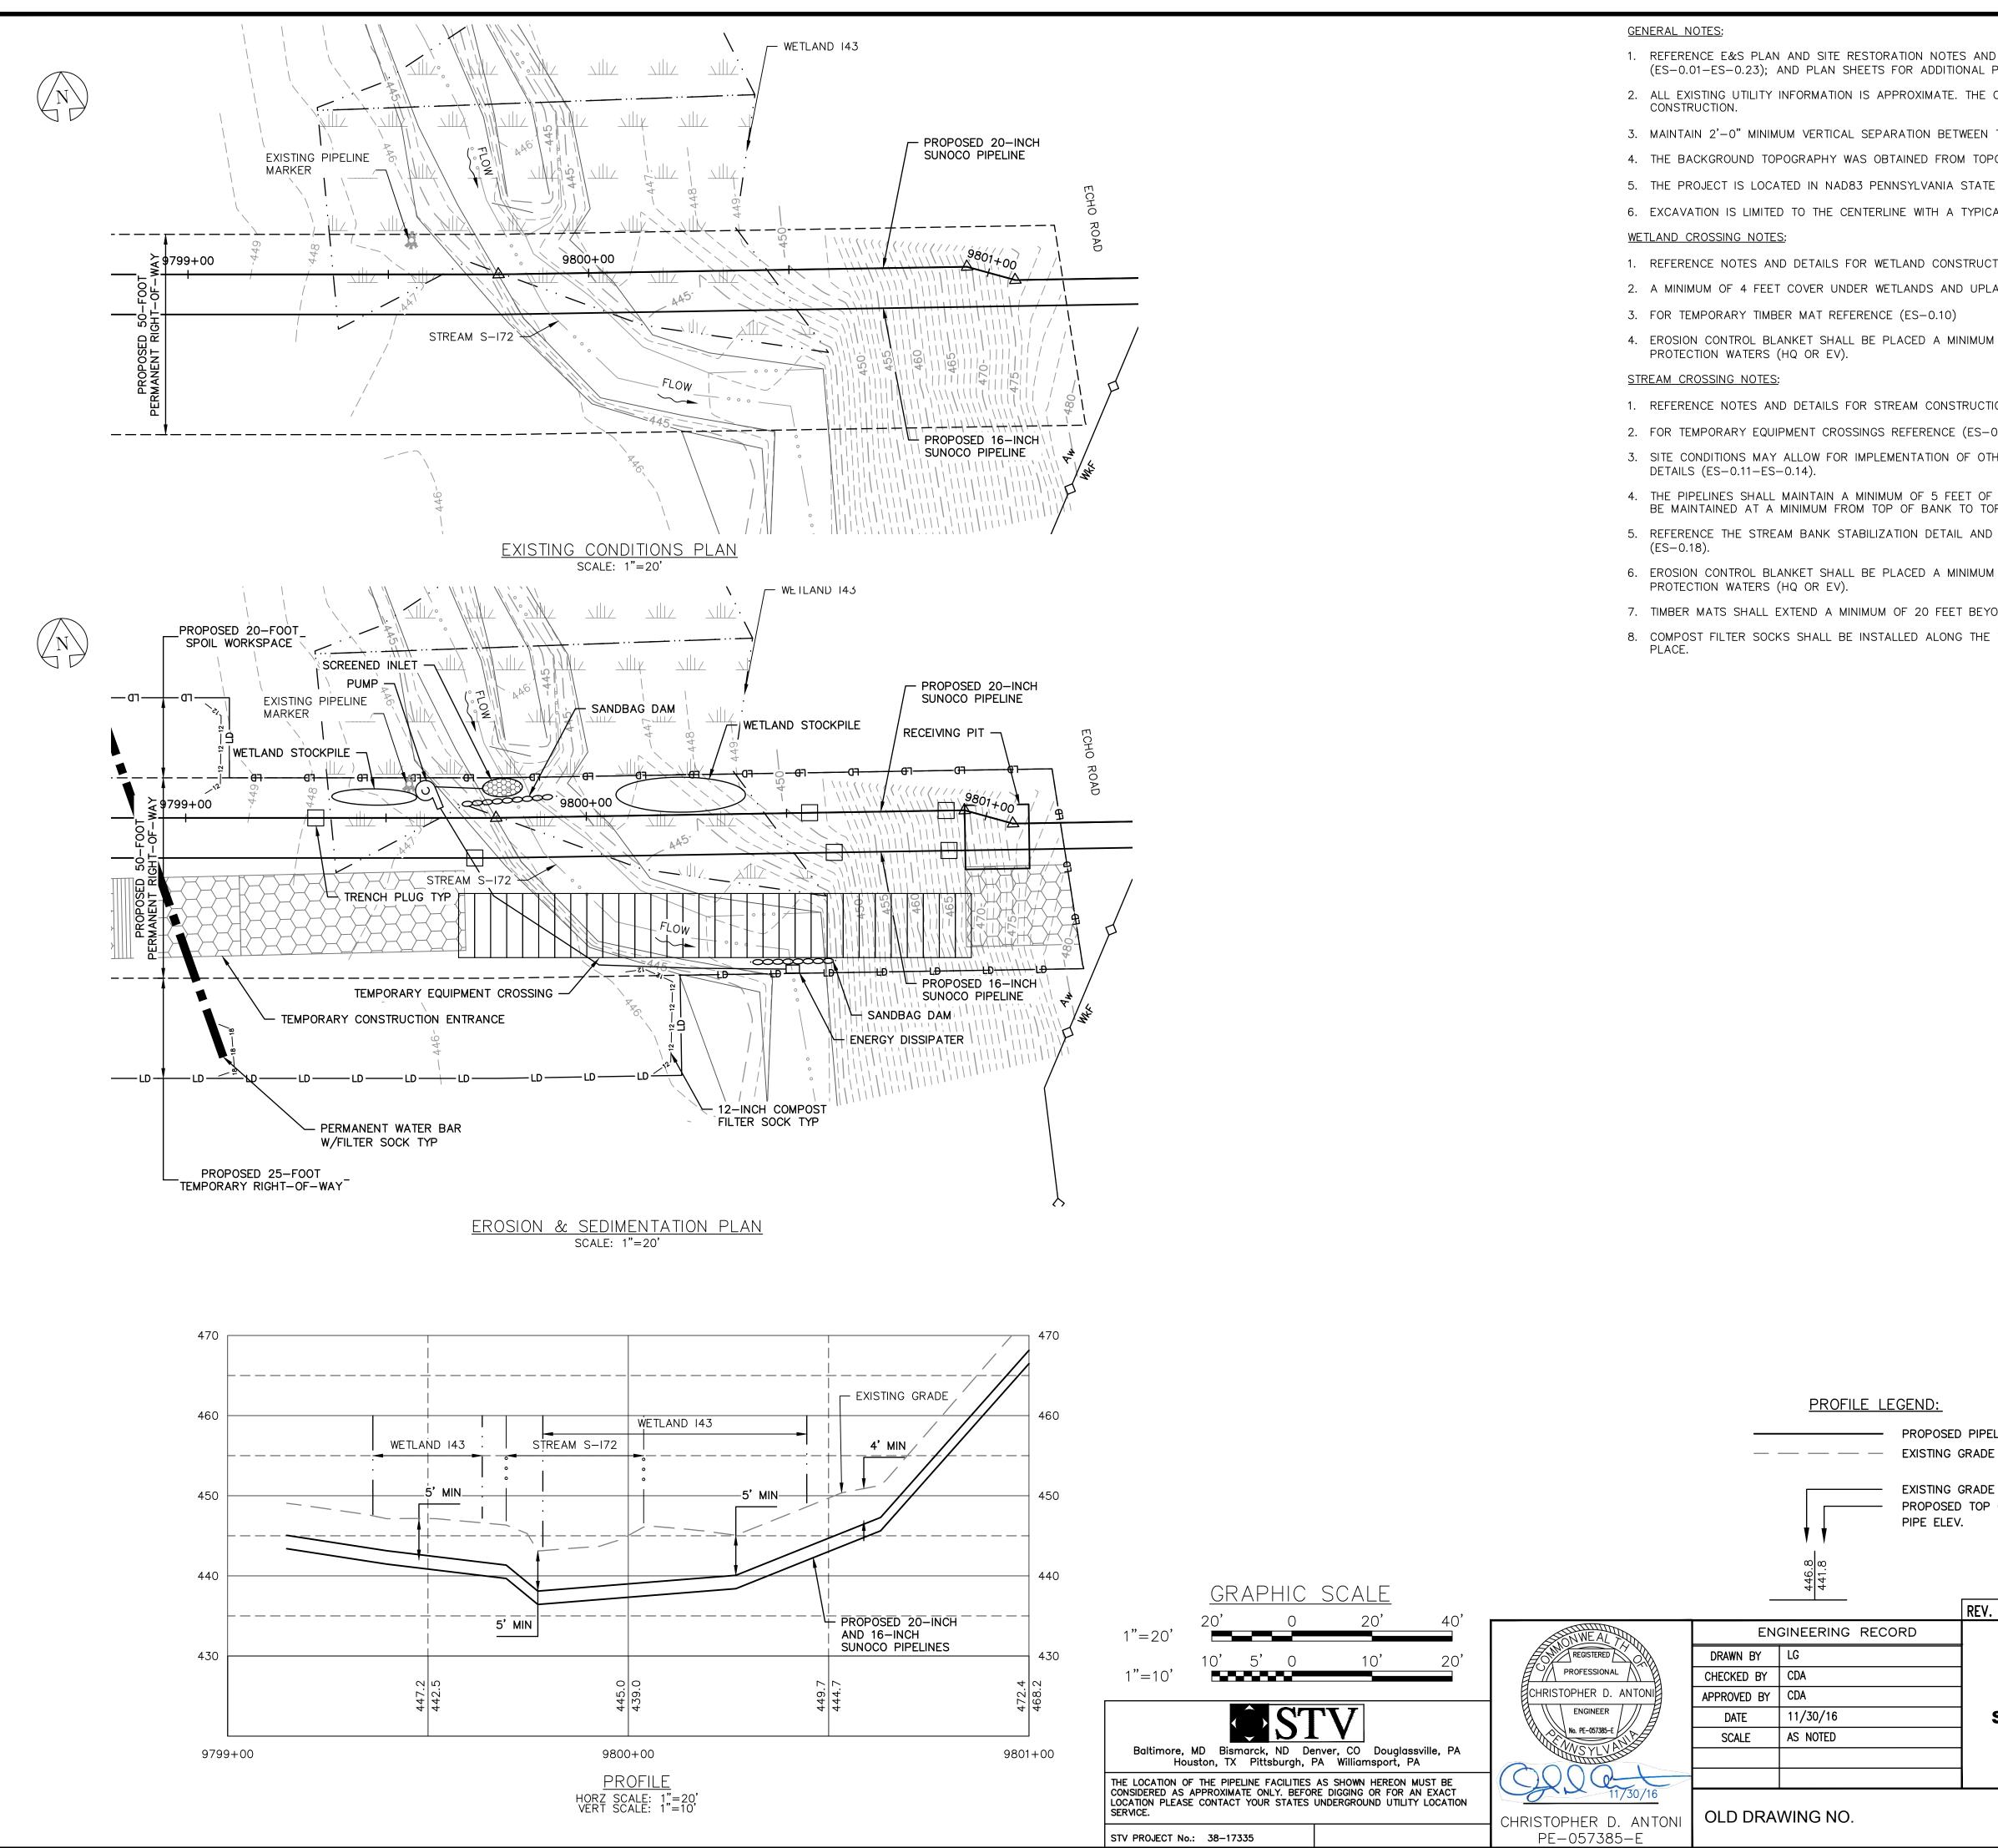

- 1. REFERENCE E&S PLAN AND SITE RESTORATION NOTES AND DETAILS FOR ADDITIONAL CONSTRUCTION SEQUENCING, TYPICAL DETAILS AND NOTES (ES-0.01-ES-0.23); AND PLAN SHEETS FOR ADDITIONAL PLANS AND TOPOGRAPHY.
- 2. ALL EXISTING UTILITY INFORMATION IS APPROXIMATE. THE CONTRACTOR IS RESPONSIBLE FOR VERIFYING ALL EXISTING UTILITIES PRIOR TO
- 3. MAINTAIN 2'-0" MINIMUM VERTICAL SEPARATION BETWEEN THE PROPOSED PIPELINE AND OTHER UTILITIES.
- 4. THE BACKGROUND TOPOGRAPHY WAS OBTAINED FROM TOPOGRAPHIC SURVEYS PERFORMED IN SEPTEMBER 2016.
- 5. THE PROJECT IS LOCATED IN NAD83 PENNSYLVANIA STATE PLANE COORDINATE SYSTEM (SOUTH ZONE), NAVD88.
- 6. EXCAVATION IS LIMITED TO THE CENTERLINE WITH A TYPICAL TRENCH WIDTH OF 4-5'FOR 16/20"PIPELINE.
- 1. REFERENCE NOTES AND DETAILS FOR WETLAND CONSTRUCTION SEQUENCING AND WETLAND RESTORATION (ES-0.03, ES-0.08, ES-0.10, AND ES-0.15).
- 2. A MINIMUM OF 4 FEET COVER UNDER WETLANDS AND UPLANDS IS REQUIRED.
- 3. FOR TEMPORARY TIMBER MAT REFERENCE (ES-0.10)
- 4. EROSION CONTROL BLANKET SHALL BE PLACED A MINIMUM OF 50 FEET EDGE OF WETLAND OR 100 FEET FROM EDGE OF WETLAND FOR SPECIAL
- 1. REFERENCE NOTES AND DETAILS FOR STREAM CONSTRUCTION SEQUENCING AND STREAM RESTORATION (ES-0.01-ES-0.17).
- 2. FOR TEMPORARY EQUIPMENT CROSSINGS REFERENCE (ES-0.10).
- 3. SITE CONDITIONS MAY ALLOW FOR IMPLEMENTATION OF OTHER APPROVED PIPELINE INSTALLATION METHODS REFERENCED WITH THE NOTES AND
- 4. THE PIPELINES SHALL MAINTAIN A MINIMUM OF 5 FEET OF COVER UNDER STREAMS FROM THE TOP OF PIPE TO THE STREAM BED. THIS COVER WILL BE MAINTAINED AT A MINIMUM FROM TOP OF BANK TO TOP OF BANK.
- 5. REFERENCE THE STREAM BANK STABILIZATION DETAIL AND STREAM RESTORATION TABLE IN THE NOTES AND DETAILS WHERE RIP-RAP IS PROPOSED
- 6. EROSION CONTROL BLANKET SHALL BE PLACED A MINIMUM OF 50 FEET FROM TOP OF BANK OR 100 FEET FROM TOP OF BANK FOR SPECIAL
- 7. TIMBER MATS SHALL EXTEND A MINIMUM OF 20 FEET BEYOND TOP OF BANK.

PIPE ELEV.


**Sunoco Logistics** 

DWG. NO.

S-I72-A

Partners L.P.

8. COMPOST FILTER SOCKS SHALL BE INSTALLED ALONG THE TOP OF THE STREAM BANK ACROSS THE RIGHT-OF-WAY WHEN PUMP BYPASS IS NOT IN

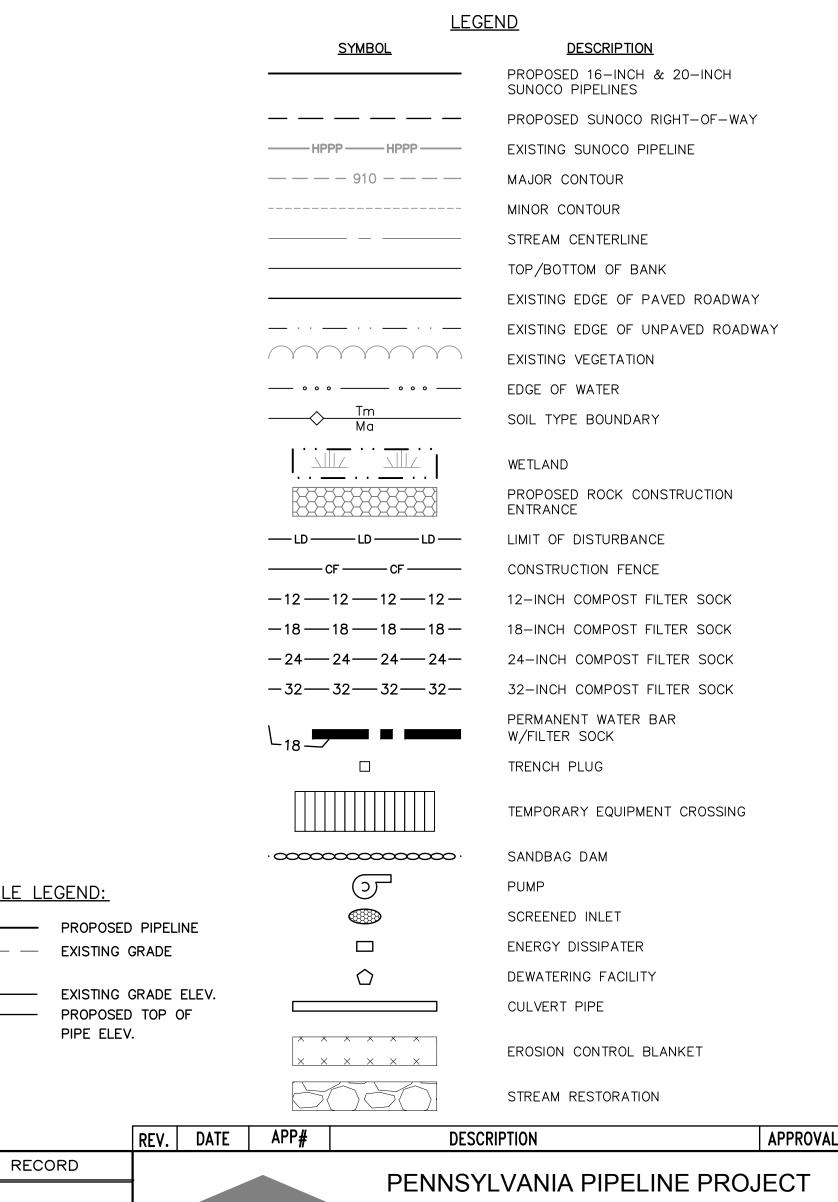


STREAM S-I72


**EROSION & SEDIMENTATION** 


CONTROL PLAN AND PROFILE


CUMBERLAND COUNTY, PA

REV. NO.

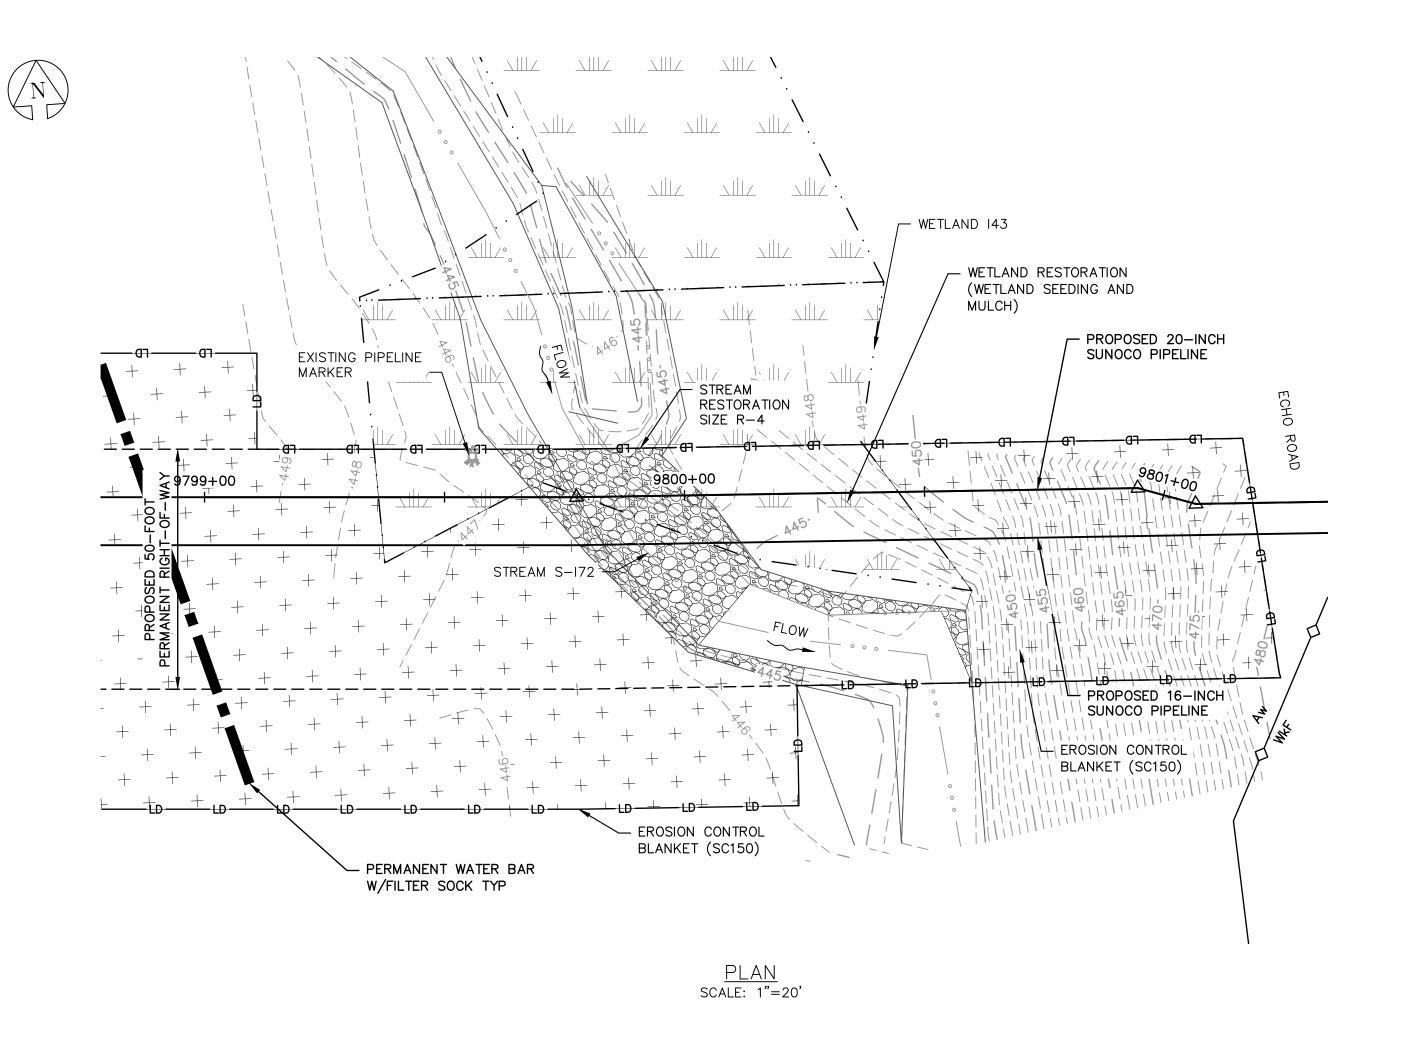

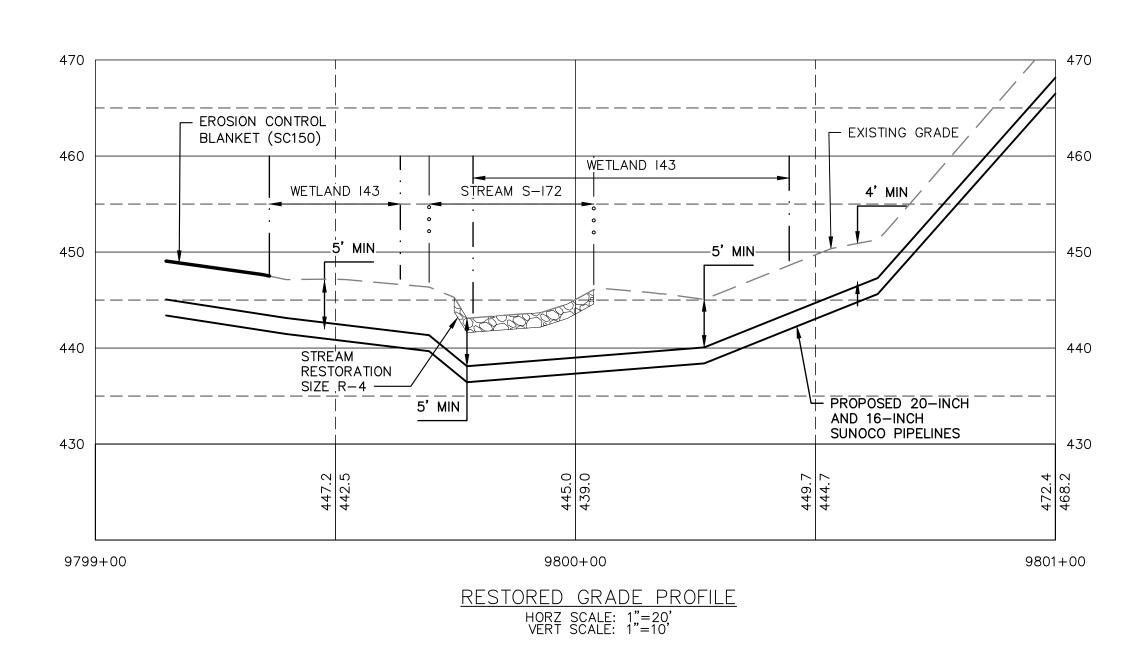

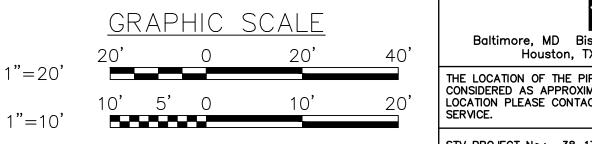

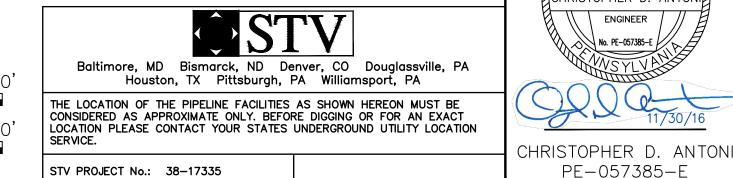


- 1. REFERENCE E&S PLAN AND SITE RESTORATION NOTES AND DETAILS FOR ADDITIONAL CONSTRUCTION SEQUENCING, TYPICAL DETAILS AND NOTES (ES-0.01-ES-0.23); AND PLAN SHEETS FOR ADDITIONAL PLANS AND TOPOGRAPHY.
- 2. ALL EXISTING UTILITY INFORMATION IS APPROXIMATE. THE CONTRACTOR IS RESPONSIBLE FOR VERIFYING ALL EXISTING UTILITIES PRIOR TO CONSTRUCTION.
- 3. MAINTAIN 2'-0" MINIMUM VERTICAL SEPARATION BETWEEN THE PROPOSED PIPELINE AND OTHER UTILITIES.
- 4. THE BACKGROUND TOPOGRAPHY WAS OBTAINED FROM TOPOGRAPHIC SURVEYS PERFORMED IN SEPTEMBER 2016.
- 5. THE PROJECT IS LOCATED IN NAD83 PENNSYLVANIA STATE PLANE COORDINATE SYSTEM (SOUTH ZONE), NAVD88.
- 6. EXCAVATION IS LIMITED TO THE CENTERLINE WITH A TYPICAL TRENCH WIDTH OF 4-5'FOR 16/20"PIPELINE.

### WETLAND CROSSING NOTES:

- 1. REFERENCE NOTES AND DETAILS FOR WETLAND CONSTRUCTION SEQUENCING AND WETLAND RESTORATION (ES-0.03, ES-0.08, ES-0.10, AND ES-0.15).
- 2. A MINIMUM OF 4 FEET COVER UNDER WETLANDS AND UPLANDS IS REQUIRED.
- 3. FOR TEMPORARY TIMBER MAT REFERENCE (ES-0.10)
- 4. EROSION CONTROL BLANKET SHALL BE PLACED A MINIMUM OF 50 FEET EDGE OF WETLAND OR 100 FEET FROM EDGE OF WETLAND FOR SPECIAL PROTECTION WATERS (HQ OR EV).

### STREAM CROSSING NOTES:

- 1. REFERENCE NOTES AND DETAILS FOR STREAM CONSTRUCTION SEQUENCING AND STREAM RESTORATION (ES-0.01-ES-0.17).
- 2. FOR TEMPORARY EQUIPMENT CROSSINGS REFERENCE (ES-0.10).
- 3. SITE CONDITIONS MAY ALLOW FOR IMPLEMENTATION OF OTHER APPROVED PIPELINE INSTALLATION METHODS REFERENCED WITH THE NOTES AND DETAILS (ES-0.11-ES-0.14).
- 4. THE PIPELINES SHALL MAINTAIN A MINIMUM OF 5 FEET OF COVER UNDER STREAMS FROM THE TOP OF PIPE TO THE STREAM BED. THIS COVER WILL BE MAINTAINED AT A MINIMUM FROM TOP OF BANK TO TOP OF BANK.
- 5. REFERENCE THE STREAM BANK STABILIZATION DETAIL AND STREAM RESTORATION TABLE IN THE NOTES AND DETAILS WHERE RIP-RAP IS PROPOSED (ES-0.18).
- 6. EROSION CONTROL BLANKET SHALL BE PLACED A MINIMUM OF 50 FEET FROM TOP OF BANK OR 100 FEET FROM TOP OF BANK FOR SPECIAL PROTECTION WATERS (HQ OR EV).
- 7. TIMBER MATS SHALL EXTEND A MINIMUM OF 20 FEET BEYOND TOP OF BANK.
- 8. COMPOST FILTER SOCKS SHALL BE INSTALLED ALONG THE TOP OF THE STREAM BANK ACROSS THE RIGHT-OF-WAY WHEN PUMP BYPASS IS NOT IN

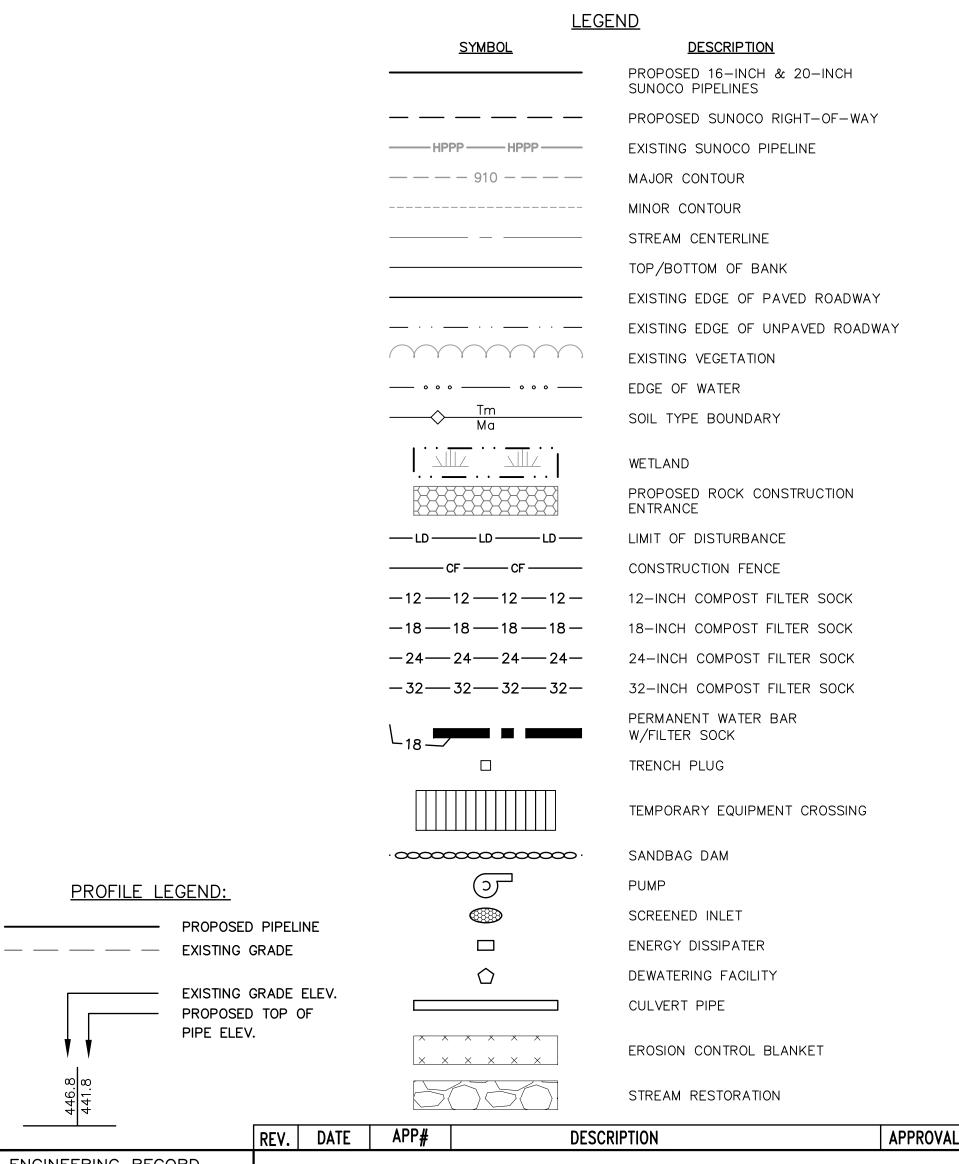

ENGINEERING RECORD DRAWN BY LG PROFESSIONAL CHECKED BY | CDA CHRISTOPHER D. ANTONI APPROVED BY CDA ENGINEER 11/30/16 **Sunoco Logistics** DATE No. PE-057385-E / Partners L.P. AS NOTED SCALE


OLD DRAWING NO.

PE-057385-E

PENNSYLVANIA PIPELINE PROJECT STREAM S-I72 **RESTORATION PLAN** 


CUMBERLAND COUNTY, PA

DWG. NO. REV. NO. S-I72-B

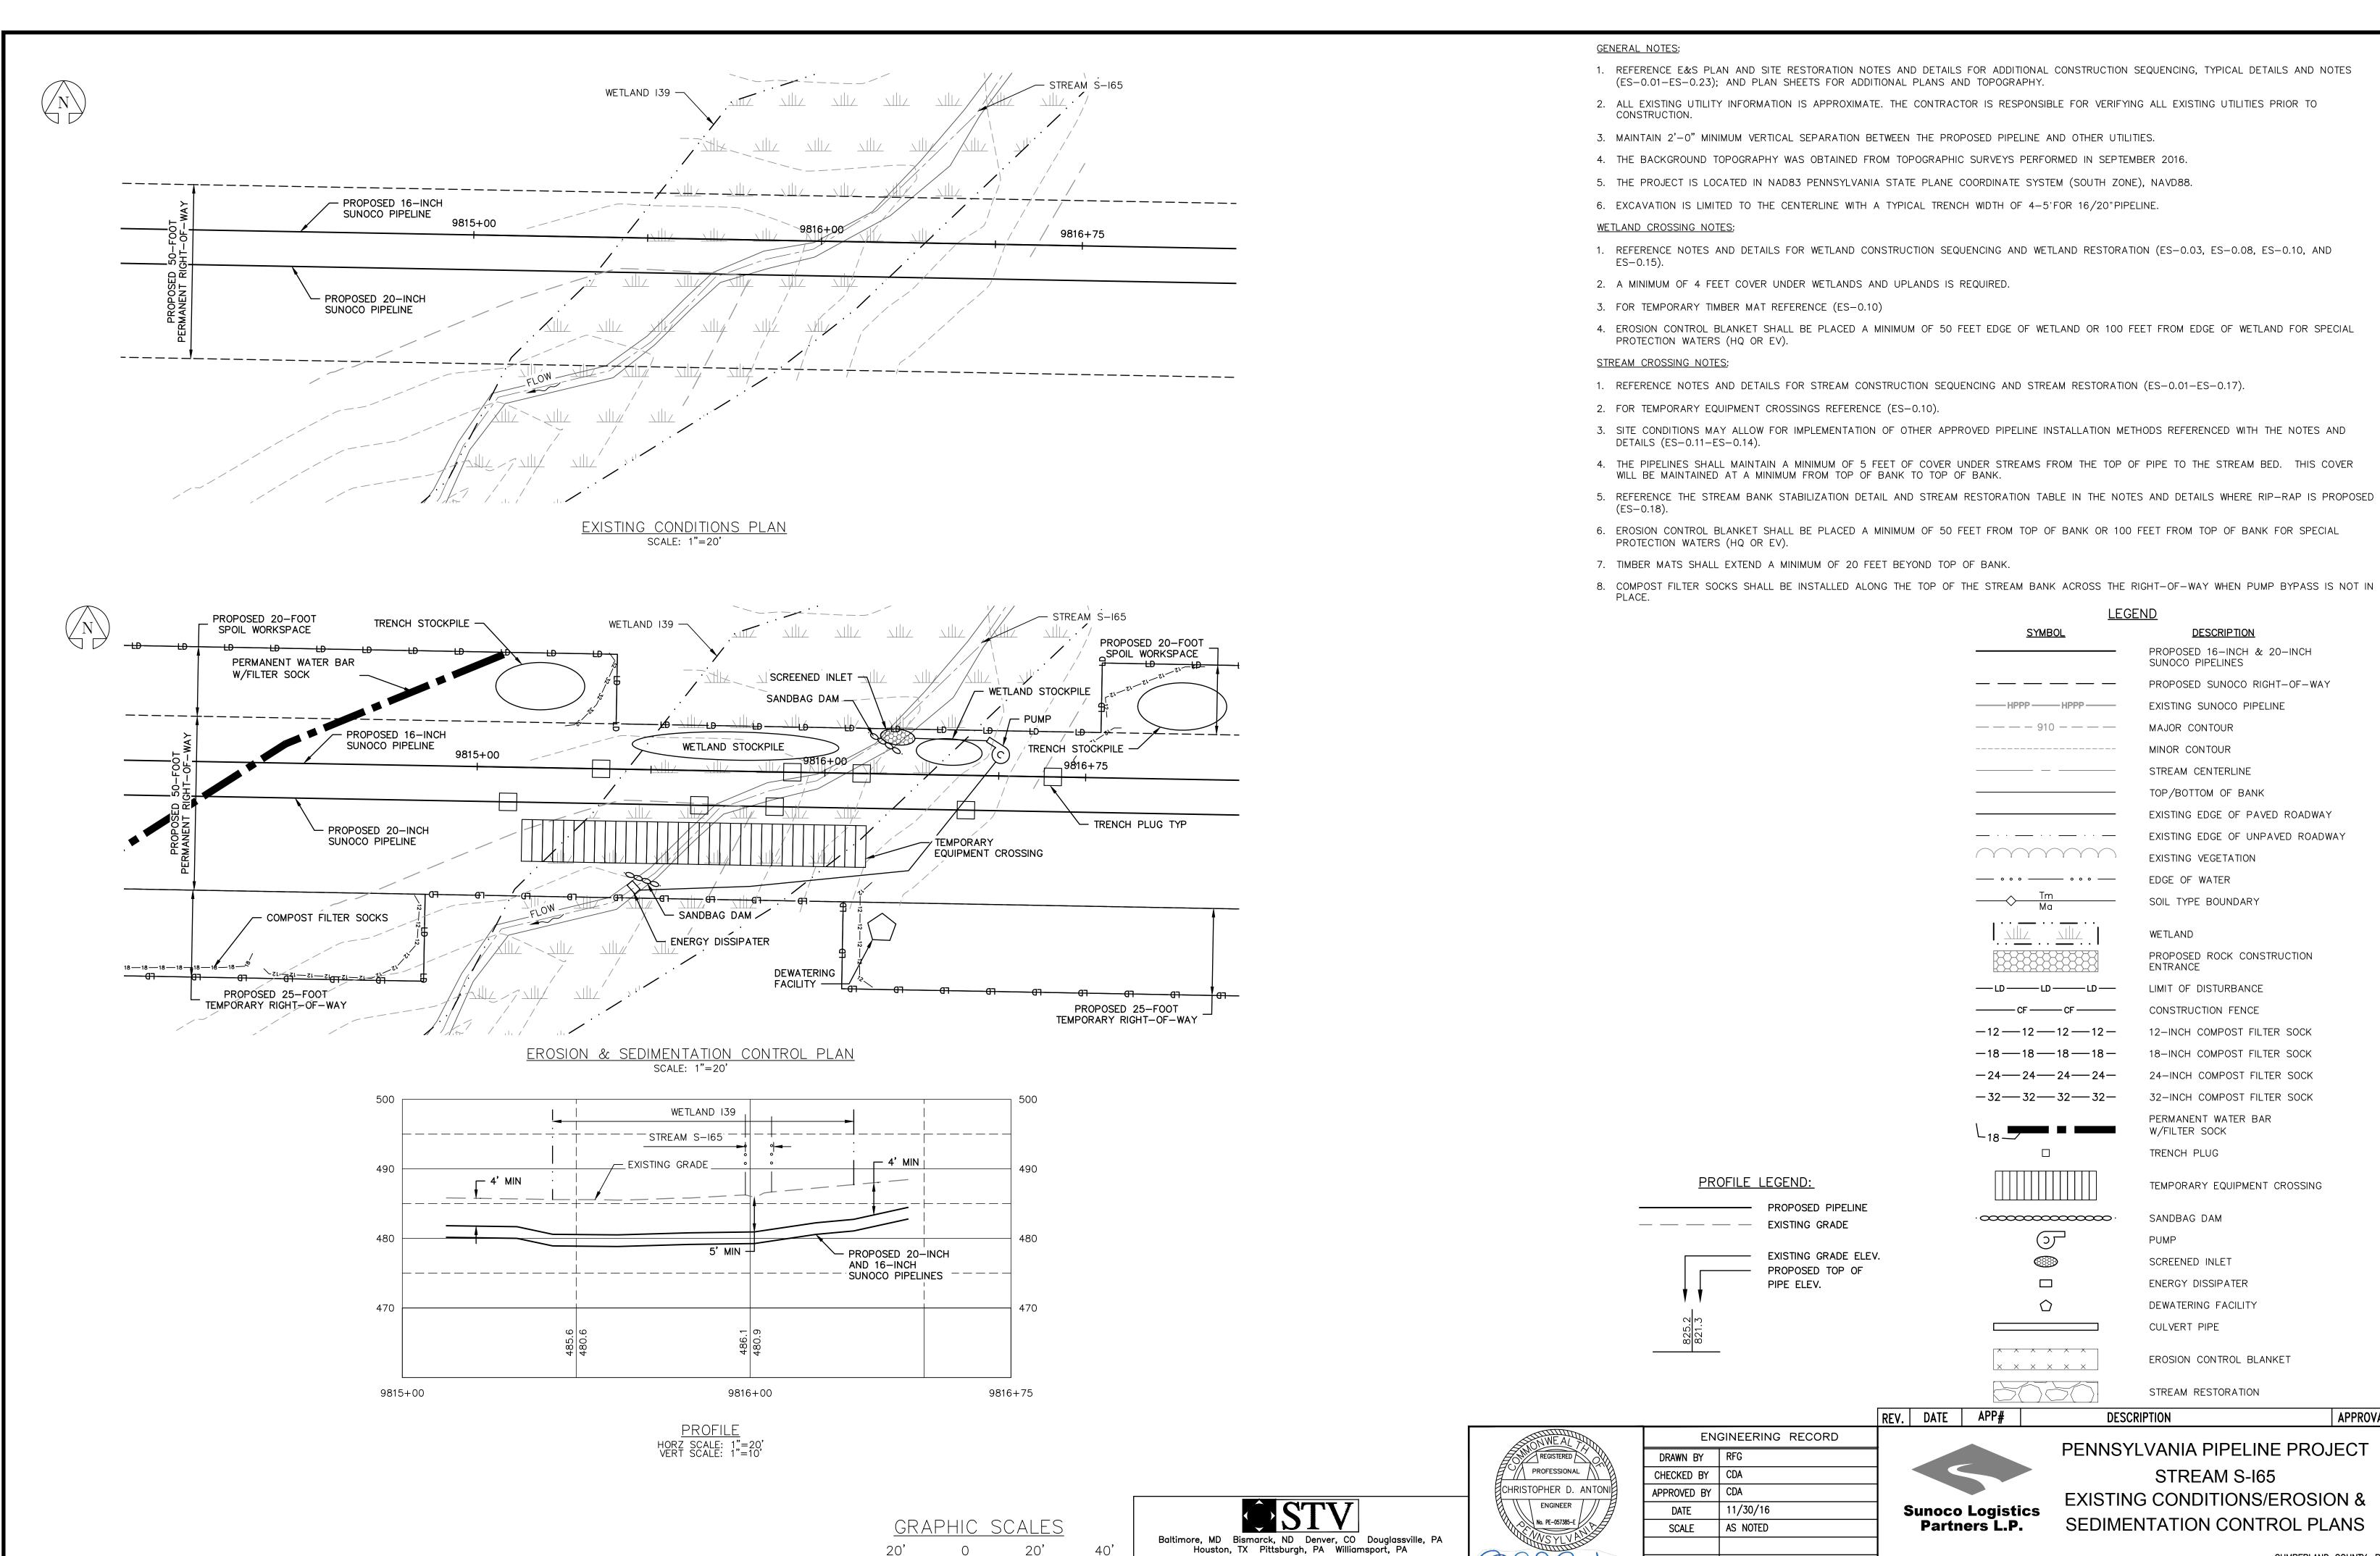

1"=20'

- 1. REFERENCE E&S PLAN AND SITE RESTORATION NOTES AND DETAILS FOR ADDITIONAL CONSTRUCTION SEQUENCING, TYPICAL DETAILS AND NOTES (ES-0.01-ES-0.23); AND PLAN SHEETS FOR ADDITIONAL PLANS AND TOPOGRAPHY.
- 2. ALL EXISTING UTILITY INFORMATION IS APPROXIMATE. THE CONTRACTOR IS RESPONSIBLE FOR VERIFYING ALL EXISTING UTILITIES PRIOR TO
- 3. MAINTAIN 2'-0" MINIMUM VERTICAL SEPARATION BETWEEN THE PROPOSED PIPELINE AND OTHER UTILITIES.
- 4. THE BACKGROUND TOPOGRAPHY WAS OBTAINED FROM TOPOGRAPHIC SURVEYS PERFORMED IN SEPTEMBER 2016.
- 5. THE PROJECT IS LOCATED IN NAD83 PENNSYLVANIA STATE PLANE COORDINATE SYSTEM (SOUTH ZONE), NAVD88.
- 6. EXCAVATION IS LIMITED TO THE CENTERLINE WITH A TYPICAL TRENCH WIDTH OF 4-5'FOR 16/20"PIPELINE.
- 1. REFERENCE NOTES AND DETAILS FOR WETLAND CONSTRUCTION SEQUENCING AND WETLAND RESTORATION (ES-0.03, ES-0.08, ES-0.10, AND
- 2. A MINIMUM OF 4 FEET COVER UNDER WETLANDS AND UPLANDS IS REQUIRED.
- 3. FOR TEMPORARY TIMBER MAT REFERENCE (ES-0.10)
- 4. EROSION CONTROL BLANKET SHALL BE PLACED A MINIMUM OF 50 FEET EDGE OF WETLAND OR 100 FEET FROM EDGE OF WETLAND FOR SPECIAL
- 1. REFERENCE NOTES AND DETAILS FOR STREAM CONSTRUCTION SEQUENCING AND STREAM RESTORATION (ES-0.01-ES-0.17).
- 2. FOR TEMPORARY EQUIPMENT CROSSINGS REFERENCE (ES-0.10).
- 3. SITE CONDITIONS MAY ALLOW FOR IMPLEMENTATION OF OTHER APPROVED PIPELINE INSTALLATION METHODS REFERENCED WITH THE NOTES AND
- 4. THE PIPELINES SHALL MAINTAIN A MINIMUM OF 5 FEET OF COVER UNDER STREAMS FROM THE TOP OF PIPE TO THE STREAM BED. THIS COVER WILL BE MAINTAINED AT A MINIMUM FROM TOP OF BANK TO TOP OF BANK.
- 6. EROSION CONTROL BLANKET SHALL BE PLACED A MINIMUM OF 50 FEET FROM TOP OF BANK OR 100 FEET FROM TOP OF BANK FOR SPECIAL
- 7. TIMBER MATS SHALL EXTEND A MINIMUM OF 20 FEET BEYOND TOP OF BANK.
- 8. COMPOST FILTER SOCKS SHALL BE INSTALLED ALONG THE TOP OF THE STREAM BANK ACROSS THE RIGHT-OF-WAY WHEN PUMP BYPASS IS NOT IN

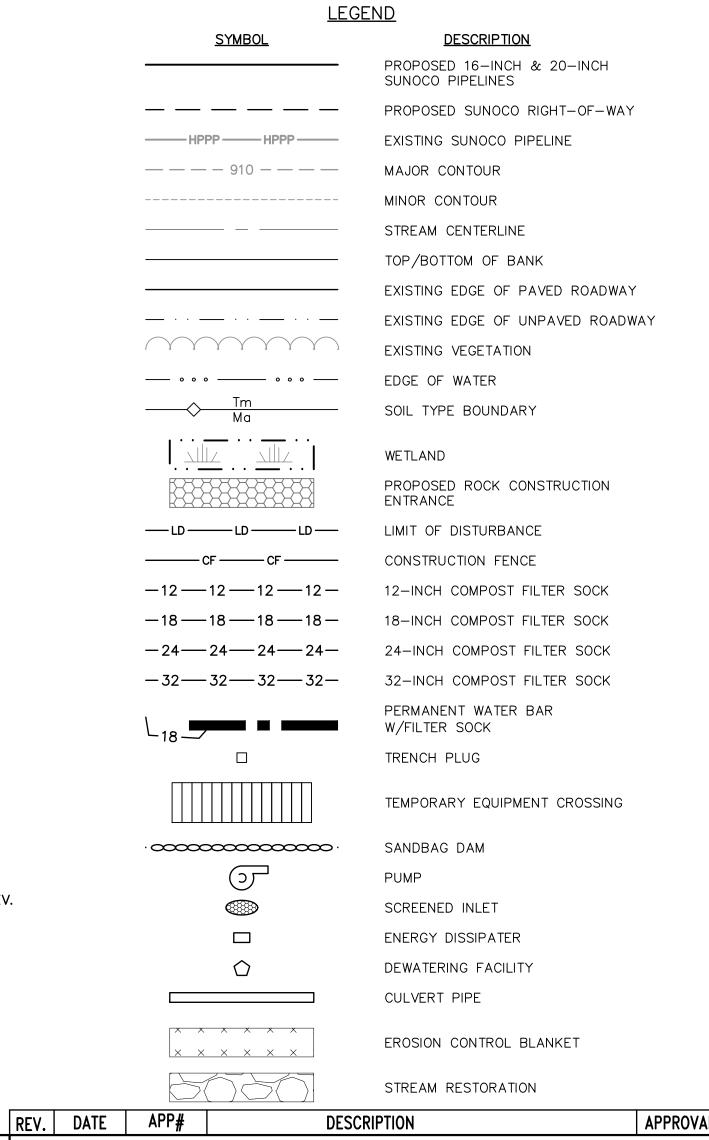

PE-057385-E

THE LOCATION OF THE PIPELINE FACILITIES AS SHOWN HEREON MUST BE CONSIDERED AS APPROXIMATE ONLY. BEFORE DIGGING OR FOR AN EXACT LOCATION PLEASE CONTACT YOUR STATES UNDERGROUND UTILITY LOCATION

STV PROJECT No.: 38-17335

Sunoco Logistics Partners L.P.

PENNSYLVANIA PIPELINE PROJECT STREAM S-I65 **EXISTING CONDITIONS/EROSION &** SEDIMENTATION CONTROL PLANS


> CUMBERLAND COUNTY, PA REV. NO.


> > 0


DWG. NO.


OLD DRAWING NO. CHRISTOPHER D. ANTONI


S-165-A

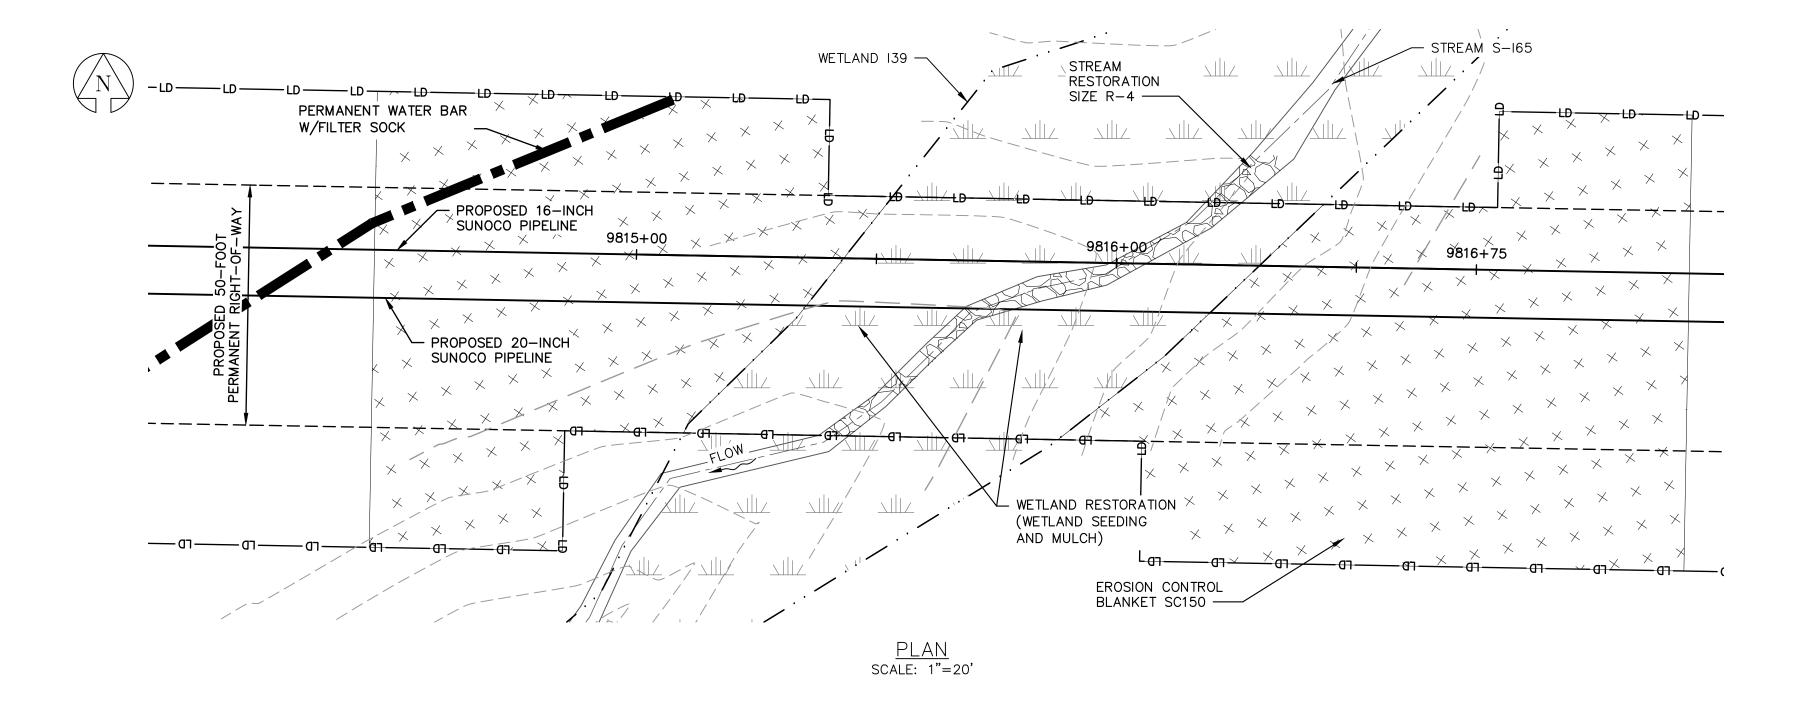

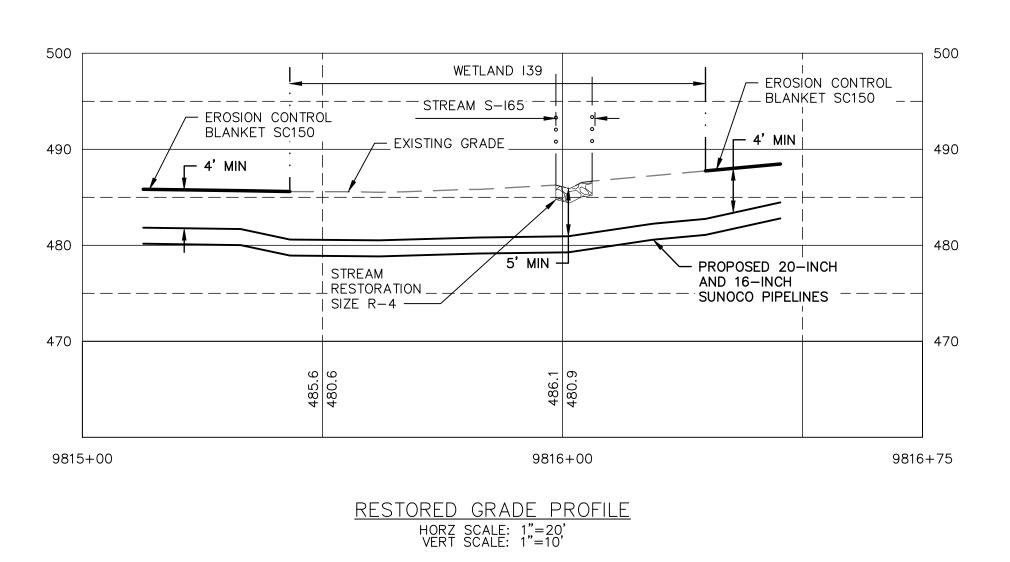

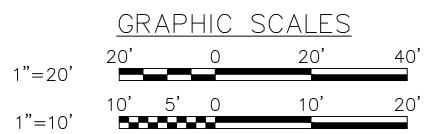

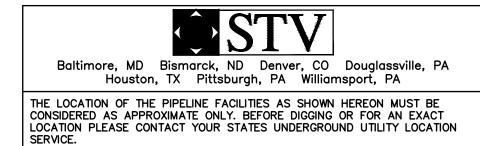

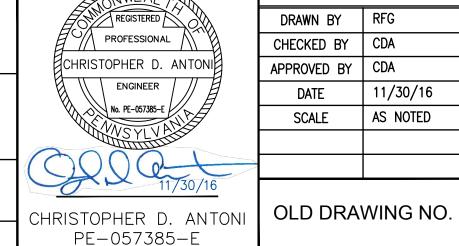

ENGINEERING RECORD DRAWN BY RFG CHECKED BY CDA APPROVED BY CDA 11/30/16 DATE SCALE AS NOTED

PROFILE LEGEND:

— — — EXISTING GRADE

PROPOSED PIPELINE

EXISTING GRADE ELEV.

PROPOSED TOP OF

PIPE ELEV.

REV. DATE APP# Sunoco Logistics Partners L.P.

APPROVA **DESCRIPTION** PENNSYLVANIA PIPELINE PROJECT STREAM S-I65 **RESTORATION PLAN** 

CUMBERLAND COUNTY, PA

DWG. NO. REV. NO. S-165-B 0

## — — — — 910 *— — —* —

1. REFERENCE E&S PLAN AND SITE RESTORATION NOTES AND DETAILS FOR ADDITIONAL CONSTRUCTION SEQUENCING, TYPICAL DETAILS AND NOTES

2. ALL EXISTING UTILITY INFORMATION IS APPROXIMATE. THE CONTRACTOR IS RESPONSIBLE FOR VERIFYING ALL EXISTING UTILITIES PRIOR TO

1. REFERENCE NOTES AND DETAILS FOR WETLAND CONSTRUCTION SEQUENCING AND WETLAND RESTORATION (ES-0.03, ES-0.08, ES-0.10, AND

4. EROSION CONTROL BLANKET SHALL BE PLACED A MINIMUM OF 50 FEET EDGE OF WETLAND OR 100 FEET FROM EDGE OF WETLAND FOR SPECIAL

3. SITE CONDITIONS MAY ALLOW FOR IMPLEMENTATION OF OTHER APPROVED PIPELINE INSTALLATION METHODS REFERENCED WITH THE NOTES AND

4. THE PIPELINES SHALL MAINTAIN A MINIMUM OF 5 FEET OF COVER UNDER STREAMS FROM THE TOP OF PIPE TO THE STREAM BED. THIS COVER

6. EROSION CONTROL BLANKET SHALL BE PLACED A MINIMUM OF 50 FEET FROM TOP OF BANK OR 100 FEET FROM TOP OF BANK FOR SPECIAL

5. REFERENCE THE STREAM BANK STABILIZATION DETAIL AND STREAM RESTORATION TABLE IN THE NOTES AND DETAILS WHERE RIP-RAP IS PROPOSED

8. COMPOST FILTER SOCKS SHALL BE INSTALLED ALONG THE TOP OF THE STREAM BANK ACROSS THE RIGHT-OF-WAY WHEN PUMP BYPASS IS NOT IN

<u>SYMBOL</u>

1. REFERENCE NOTES AND DETAILS FOR STREAM CONSTRUCTION SEQUENCING AND STREAM RESTORATION (ES-0.01-ES-0.17).

(ES-0.01-ES-0.23); AND PLAN SHEETS FOR ADDITIONAL PLANS AND TOPOGRAPHY.

2. A MINIMUM OF 4 FEET COVER UNDER WETLANDS AND UPLANDS IS REQUIRED.

WILL BE MAINTAINED AT A MINIMUM FROM TOP OF BANK TO TOP OF BANK.

7. TIMBER MATS SHALL EXTEND A MINIMUM OF 20 FEET BEYOND TOP OF BANK.

3. FOR TEMPORARY TIMBER MAT REFERENCE (ES-0.10)

2. FOR TEMPORARY EQUIPMENT CROSSINGS REFERENCE (ES-0.10).

PROTECTION WATERS (HQ OR EV).

DETAILS (ES-0.11-ES-0.14).

PROTECTION WATERS (HQ OR EV).

3. MAINTAIN 2'-0" MINIMUM VERTICAL SEPARATION BETWEEN THE PROPOSED PIPELINE AND OTHER UTILITIES.

6. EXCAVATION IS LIMITED TO THE CENTERLINE WITH A TYPICAL TRENCH WIDTH OF 4-5'FOR 16/20"PIPELINE.

4. THE BACKGROUND TOPOGRAPHY WAS OBTAINED FROM TOPOGRAPHIC SURVEYS PERFORMED IN SEPTEMBER 2016.

5. THE PROJECT IS LOCATED IN NAD83 PENNSYLVANIA STATE PLANE COORDINATE SYSTEM (SOUTH ZONE), NAVD88.

MINOR CONTOUR STREAM CENTERLINE TOP/BOTTOM OF BANK

<u>LEGEND</u>

EXISTING EDGE OF PAVED ROADWAY EXISTING EDGE OF UNPAVED ROADWAY

**DESCRIPTION** 

EXISTING SUNOCO PIPELINE

SUNOCO PIPELINES

MAJOR CONTOUR

PROPOSED 16-INCH & 20-INCH

PROPOSED SUNOCO RIGHT-OF-WAY

EXISTING VEGETATION EDGE OF WATER — · · · · — · · · · — SOIL TYPE BOUNDARY

WETLAND PROPOSED ROCK CONSTRUCTION ENTRANCE —LD——LD——LD— LIMIT OF DISTURBANCE

CONSTRUCTION FENCE 12-INCH COMPOST FILTER SOCK

18-INCH COMPOST FILTER SOCK -18 - 18 - 18 - 18 - 18 --24--24--24--24-

24-INCH COMPOST FILTER SOCK 32-INCH COMPOST FILTER SOCK -32—32—32—32— PERMANENT WATER BAR

> W/FILTER SOCK TRENCH PLUG

TEMPORARY EQUIPMENT CROSSING

SANDBAG DAM  $\cdot$ PUMP

SCREENED INLET ENERGY DISSIPATER

DEWATERING FACILITY

CULVERT PIPE EROSION CONTROL BLANKET

 $\times$   $\times$   $\times$   $\times$   $\times$ 

STREAM RESTORATION

STV PROJECT No.: 38-17335

**GENERAL NOTES:** 

CONSTRUCTION.


WETLAND CROSSING NOTES:


STREAM CROSSING NOTES:


(ES-0.18).

PLACE.

ES-0.15).

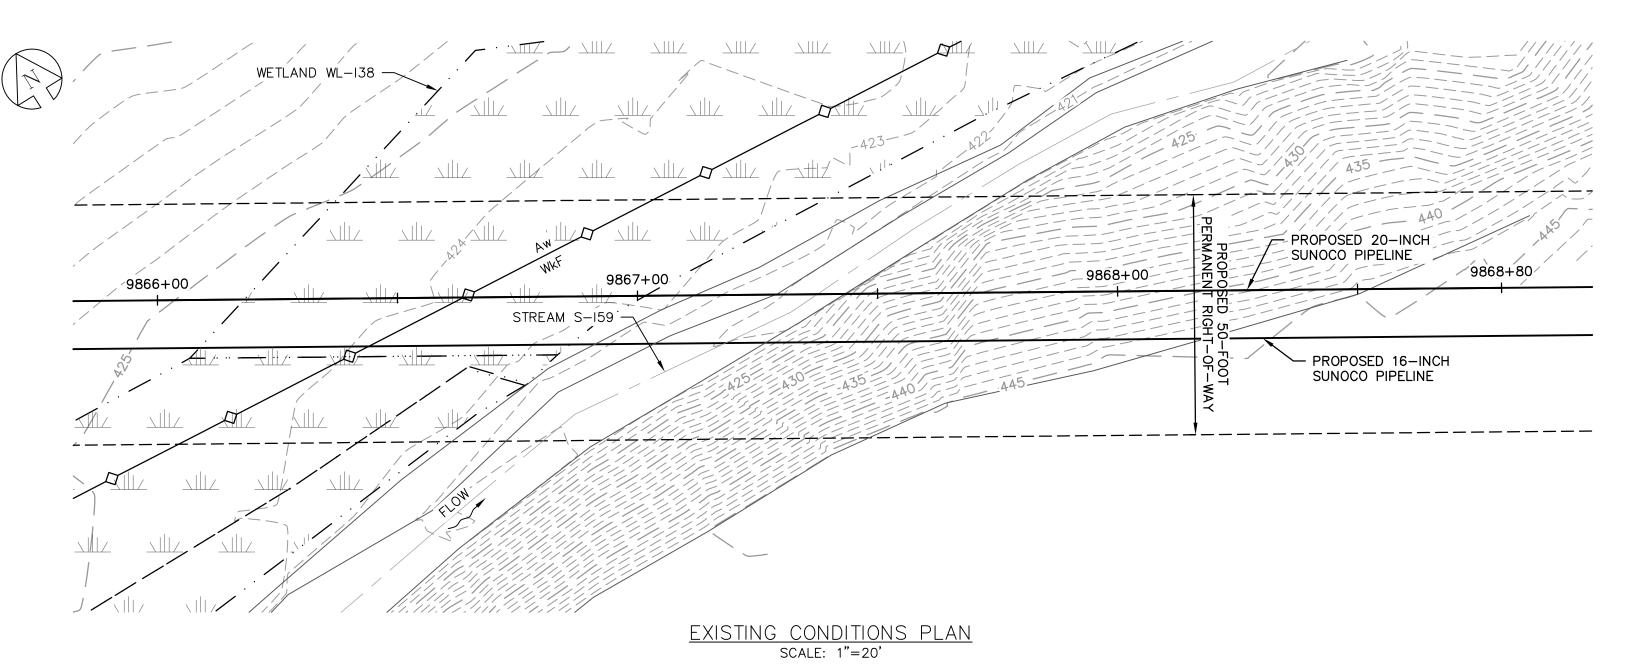

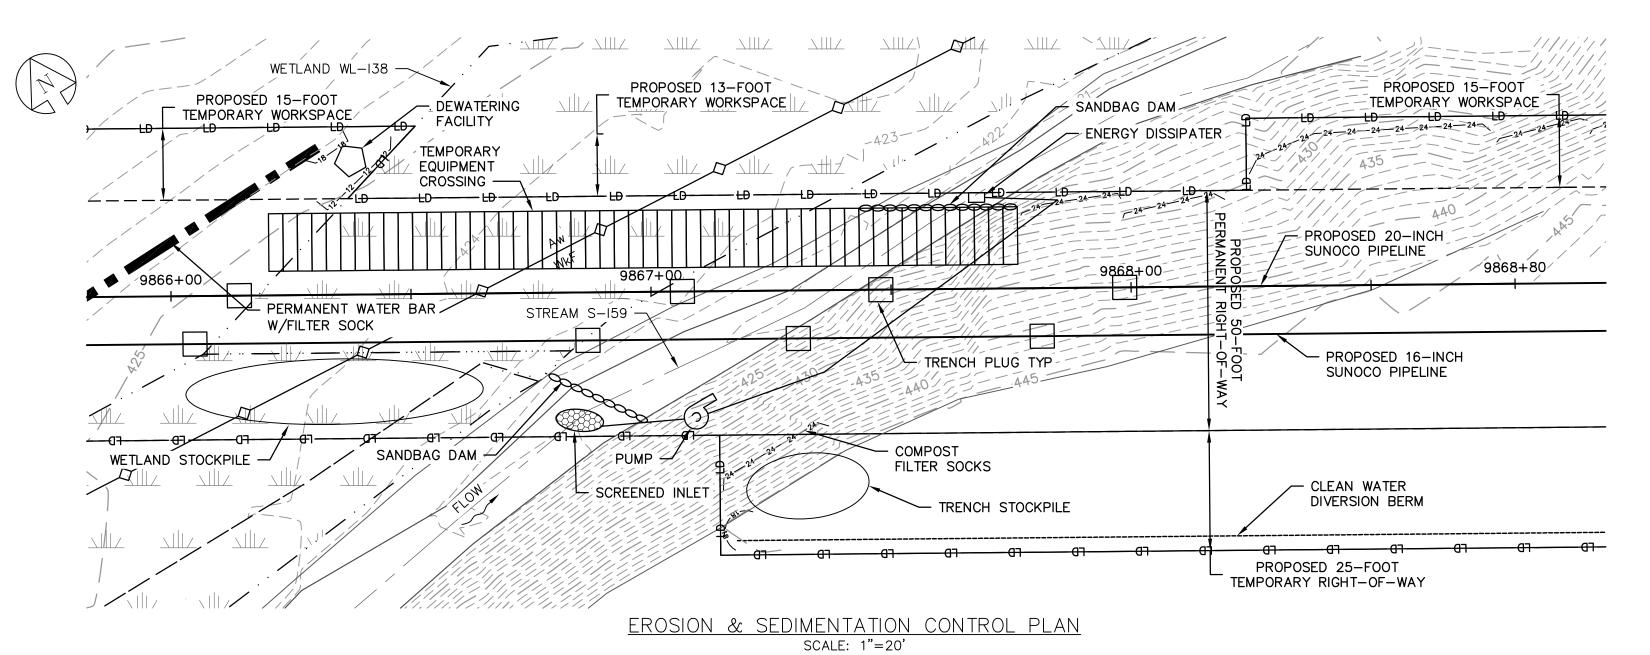

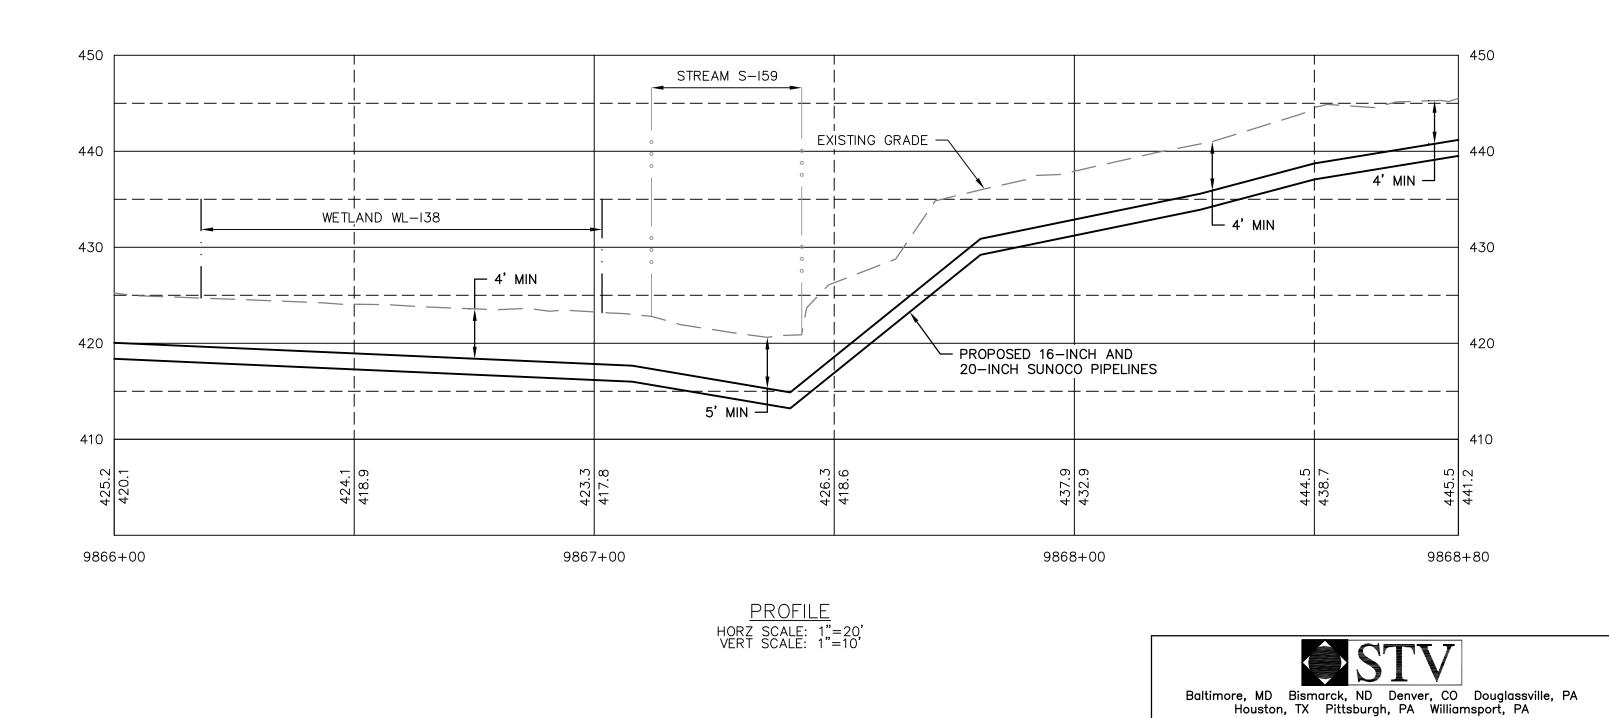


- 1. REFERENCE E&S PLAN AND SITE RESTORATION NOTES AND DETAILS FOR ADDITIONAL CONSTRUCTION SEQUENCING, TYPICAL DETAILS AND NOTES (ES-0.01-ES-0.23); AND PLAN SHEETS FOR ADDITIONAL PLANS AND TOPOGRAPHY.
- 2. ALL EXISTING UTILITY INFORMATION IS APPROXIMATE. THE CONTRACTOR IS RESPONSIBLE FOR VERIFYING ALL EXISTING UTILITIES PRIOR TO CONSTRUCTION.
- 3. MAINTAIN 2'-0" MINIMUM VERTICAL SEPARATION BETWEEN THE PROPOSED PIPELINE AND OTHER UTILITIES.
- 4. THE BACKGROUND TOPOGRAPHY WAS OBTAINED FROM TOPOGRAPHIC SURVEYS PERFORMED IN SEPTEMBER 2016.
- 5. THE PROJECT IS LOCATED IN NAD83 PENNSYLVANIA STATE PLANE COORDINATE SYSTEM (SOUTH ZONE), NAVD88.
- 6. EXCAVATION IS LIMITED TO THE CENTERLINE WITH A TYPICAL TRENCH WIDTH OF 4-5'FOR 16/20"PIPELINE.


### WETLAND CROSSING NOTES:

- 1. REFERENCE NOTES AND DETAILS FOR WETLAND CONSTRUCTION SEQUENCING AND WETLAND RESTORATION (ES-0.03, ES-0.08, ES-0.10, AND ES-0.15).
- 2. A MINIMUM OF 4 FEET COVER UNDER WETLANDS AND UPLANDS IS REQUIRED.
- 3. FOR TEMPORARY TIMBER MAT REFERENCE (ES-0.10)
- 4. EROSION CONTROL BLANKET SHALL BE PLACED A MINIMUM OF 50 FEET EDGE OF WETLAND OR 100 FEET FROM EDGE OF WETLAND FOR SPECIAL PROTECTION WATERS (HQ OR EV).

### STREAM CROSSING NOTES:

- 1. REFERENCE NOTES AND DETAILS FOR STREAM CONSTRUCTION SEQUENCING AND STREAM RESTORATION (ES-0.01-ES-0.17).
- 2. FOR TEMPORARY EQUIPMENT CROSSINGS REFERENCE (ES-0.10).
- 3. SITE CONDITIONS MAY ALLOW FOR IMPLEMENTATION OF OTHER APPROVED PIPELINE INSTALLATION METHODS REFERENCED WITH THE NOTES AND DETAILS (ES-0.11-ES-0.14).
- 4. THE PIPELINES SHALL MAINTAIN A MINIMUM OF 5 FEET OF COVER UNDER STREAMS FROM THE TOP OF PIPE TO THE STREAM BED. THIS COVER WILL BE MAINTAINED AT A MINIMUM FROM TOP OF BANK TO TOP OF BANK.
- 5. REFERENCE THE STREAM BANK STABILIZATION DETAIL AND STREAM RESTORATION TABLE IN THE NOTES AND DETAILS WHERE RIP-RAP IS PROPOSED (ES-0.18).
- 6. EROSION CONTROL BLANKET SHALL BE PLACED A MINIMUM OF 50 FEET FROM TOP OF BANK OR 100 FEET FROM TOP OF BANK FOR SPECIAL PROTECTION WATERS (HQ OR EV).
- 7. TIMBER MATS SHALL EXTEND A MINIMUM OF 20 FEET BEYOND TOP OF BANK.
- 8. COMPOST FILTER SOCKS SHALL BE INSTALLED ALONG THE TOP OF THE STREAM BANK ACROSS THE RIGHT-OF-WAY WHEN PUMP BYPASS IS NOT IN PLACE.

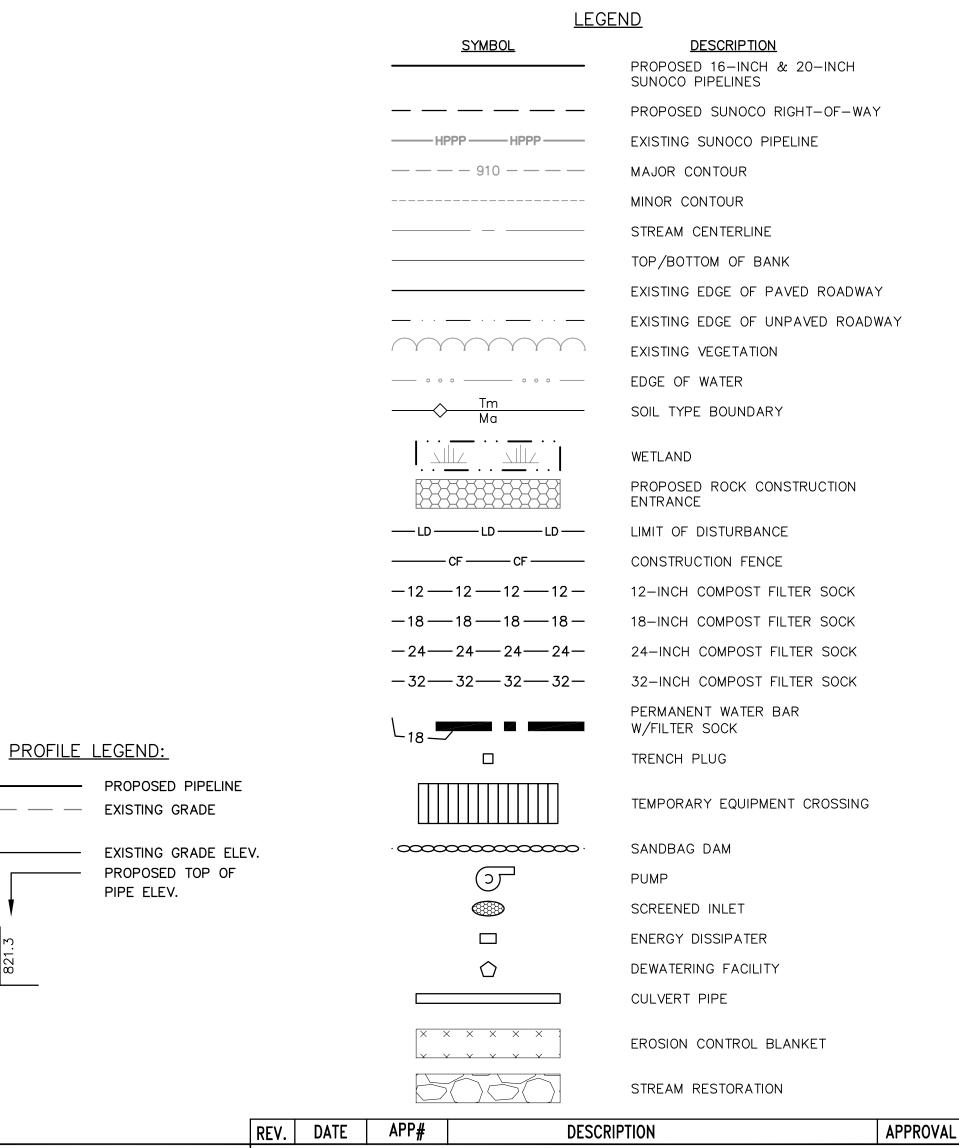

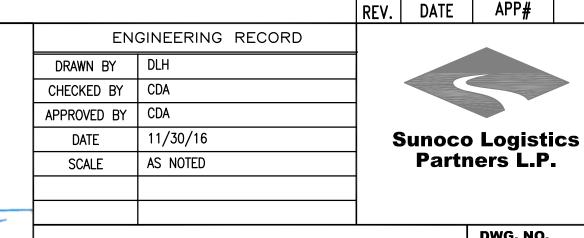

PENNSYLVANIA PIPELINE PROJECT STREAM S-I59 **EXISTING CONDITIONS/EROSION &** SEDIMENTATION CONTROL PLANS

CUMBERLAND COUNTY, PA

OLD DRAWING NO. CHRISTOPHER D. ANTONI

PROFESSIONAL

CHRISTOPHER D. ANTONI

ENGINEER


No. PE-057385-E /


PE-057385-E

THE LOCATION OF THE PIPELINE FACILITIES AS SHOWN HEREON MUST BE CONSIDERED AS APPROXIMATE ONLY. BEFORE DIGGING OR FOR AN EXACT LOCATION PLEASE CONTACT YOUR STATES UNDERGROUND UTILITY LOCATION

STV PROJECT No.: 38-17335


DWG. NO. S-I59-A REV. NO.

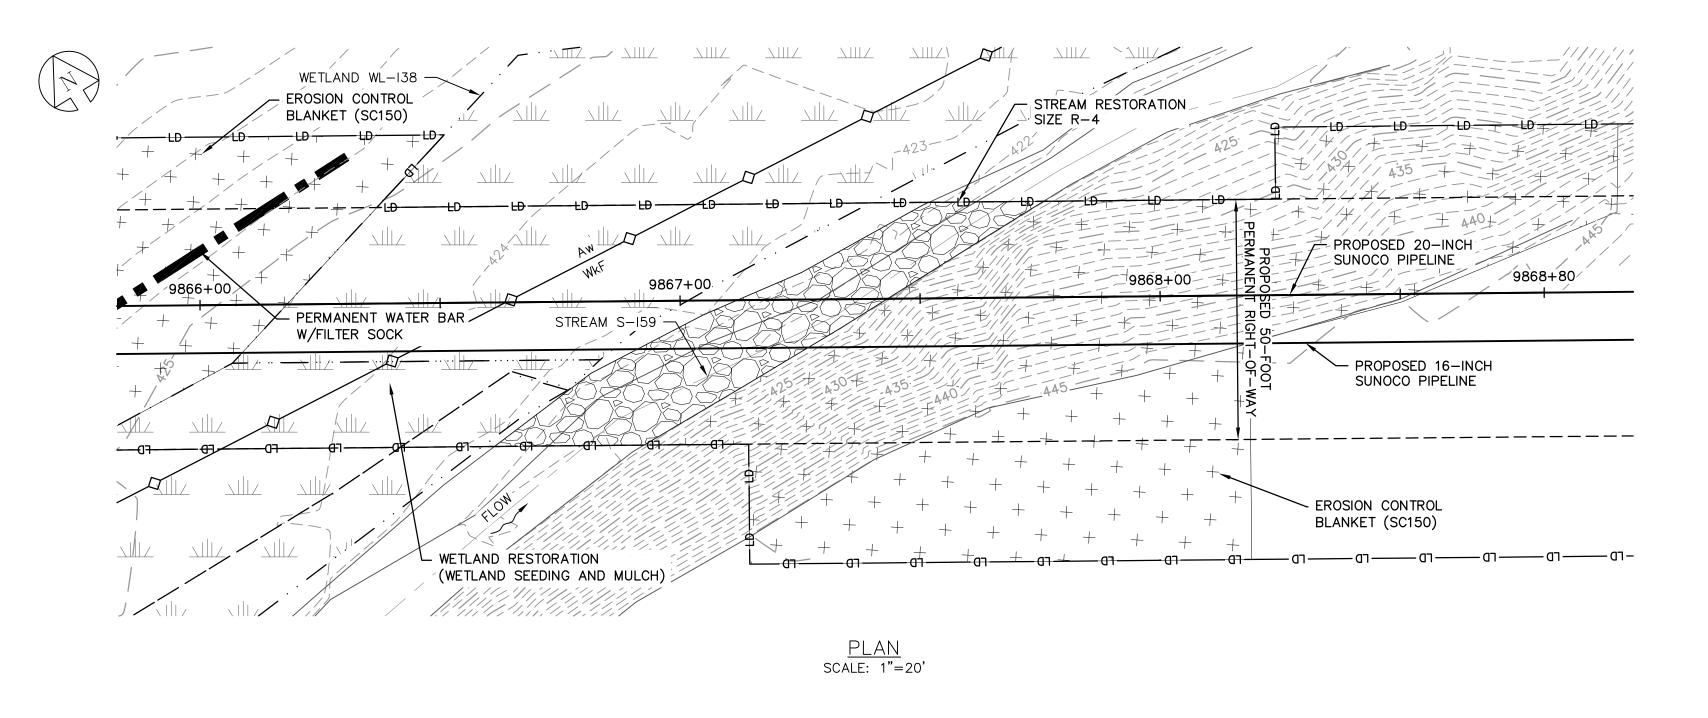


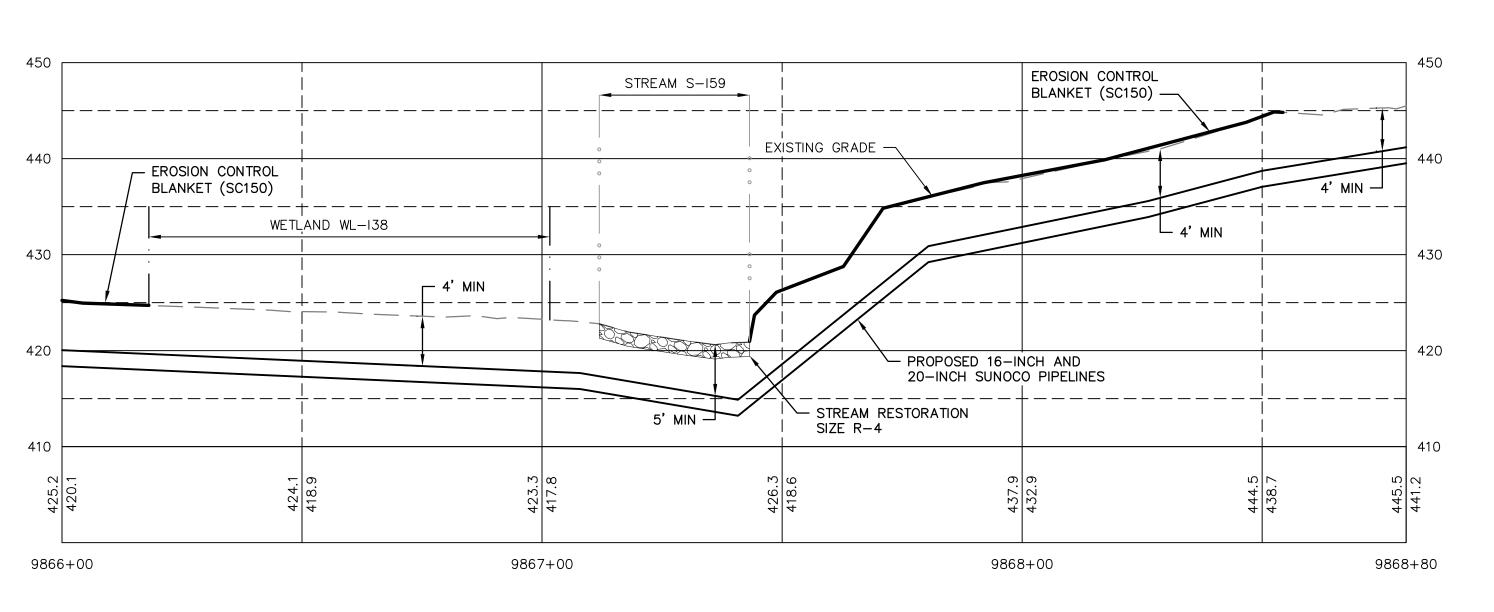

RESTORED GRADE PROFILE

HORZ SCALE: 1"=20'
VERT SCALE: 1"=10'

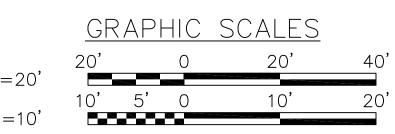

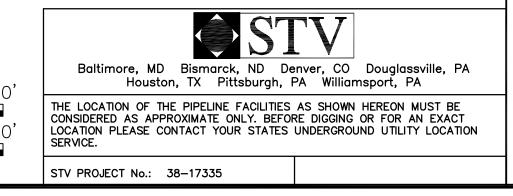


- 1. REFERENCE E&S PLAN AND SITE RESTORATION NOTES AND DETAILS FOR ADDITIONAL CONSTRUCTION SEQUENCING, TYPICAL DETAILS AND NOTES (ES-0.01-ES-0.23); AND PLAN SHEETS FOR ADDITIONAL PLANS AND TOPOGRAPHY.
- 2. ALL EXISTING UTILITY INFORMATION IS APPROXIMATE. THE CONTRACTOR IS RESPONSIBLE FOR VERIFYING ALL EXISTING UTILITIES PRIOR TO CONSTRUCTION.
- 3. MAINTAIN 2'-0" MINIMUM VERTICAL SEPARATION BETWEEN THE PROPOSED PIPELINE AND OTHER UTILITIES.
- 4. THE BACKGROUND TOPOGRAPHY WAS OBTAINED FROM TOPOGRAPHIC SURVEYS PERFORMED IN SEPTEMBER 2016.
- 5. THE PROJECT IS LOCATED IN NAD83 PENNSYLVANIA STATE PLANE COORDINATE SYSTEM (SOUTH ZONE), NAVD88.
- 6. EXCAVATION IS LIMITED TO THE CENTERLINE WITH A TYPICAL TRENCH WIDTH OF 4-5' FOR 16/20" PIPELINE.


### WETLAND CROSSING NOTES:

- 1. REFERENCE NOTES AND DETAILS FOR WETLAND CONSTRUCTION SEQUENCING AND WETLAND RESTORATION (ES-0.03, ES-0.08, ES-0.10, AND ES-0.15).
- 2. A MINIMUM OF 4 FEET COVER UNDER WETLANDS AND UPLANDS IS REQUIRED.
- 3. FOR TEMPORARY TIMBER MAT REFERENCE (ES-0.10)
- 4. EROSION CONTROL BLANKET SHALL BE PLACED A MINIMUM OF 50 FEET EDGE OF WETLAND OR 100 FEET FROM EDGE OF WETLAND FOR SPECIAL PROTECTION WATERS (HQ OR EV).

### STREAM CROSSING NOTES:

- 1. REFERENCE NOTES AND DETAILS FOR STREAM CONSTRUCTION SEQUENCING AND STREAM RESTORATION (ES-0.01-ES-0.17).
- 2. FOR TEMPORARY EQUIPMENT CROSSINGS REFERENCE (ES-0.10).
- 3. SITE CONDITIONS MAY ALLOW FOR IMPLEMENTATION OF OTHER APPROVED PIPELINE INSTALLATION METHODS REFERENCED WITH THE NOTES AND DETAILS (ES-0.11-ES-0.14).
- 4. THE PIPELINES SHALL MAINTAIN A MINIMUM OF 5 FEET OF COVER UNDER STREAMS FROM THE TOP OF PIPE TO THE STREAM BED. THIS COVER WILL BE MAINTAINED AT A MINIMUM FROM TOP OF BANK TO TOP OF BANK.
- 5. REFERENCE THE STREAM BANK STABILIZATION DETAIL AND STREAM RESTORATION TABLE IN THE NOTES AND DETAILS WHERE RIP-RAP IS PROPOSED (ES-0.18).
- 6. EROSION CONTROL BLANKET SHALL BE PLACED A MINIMUM OF 50 FEET FROM TOP OF BANK OR 100 FEET FROM TOP OF BANK FOR SPECIAL PROTECTION WATERS (HQ OR EV).
- 7. TIMBER MATS SHALL EXTEND A MINIMUM OF 20 FEET BEYOND TOP OF BANK.
- 8. COMPOST FILTER SOCKS SHALL BE INSTALLED ALONG THE TOP OF THE STREAM BANK ACROSS THE RIGHT—OF—WAY WHEN PUMP BYPASS IS NOT IN PLACE.

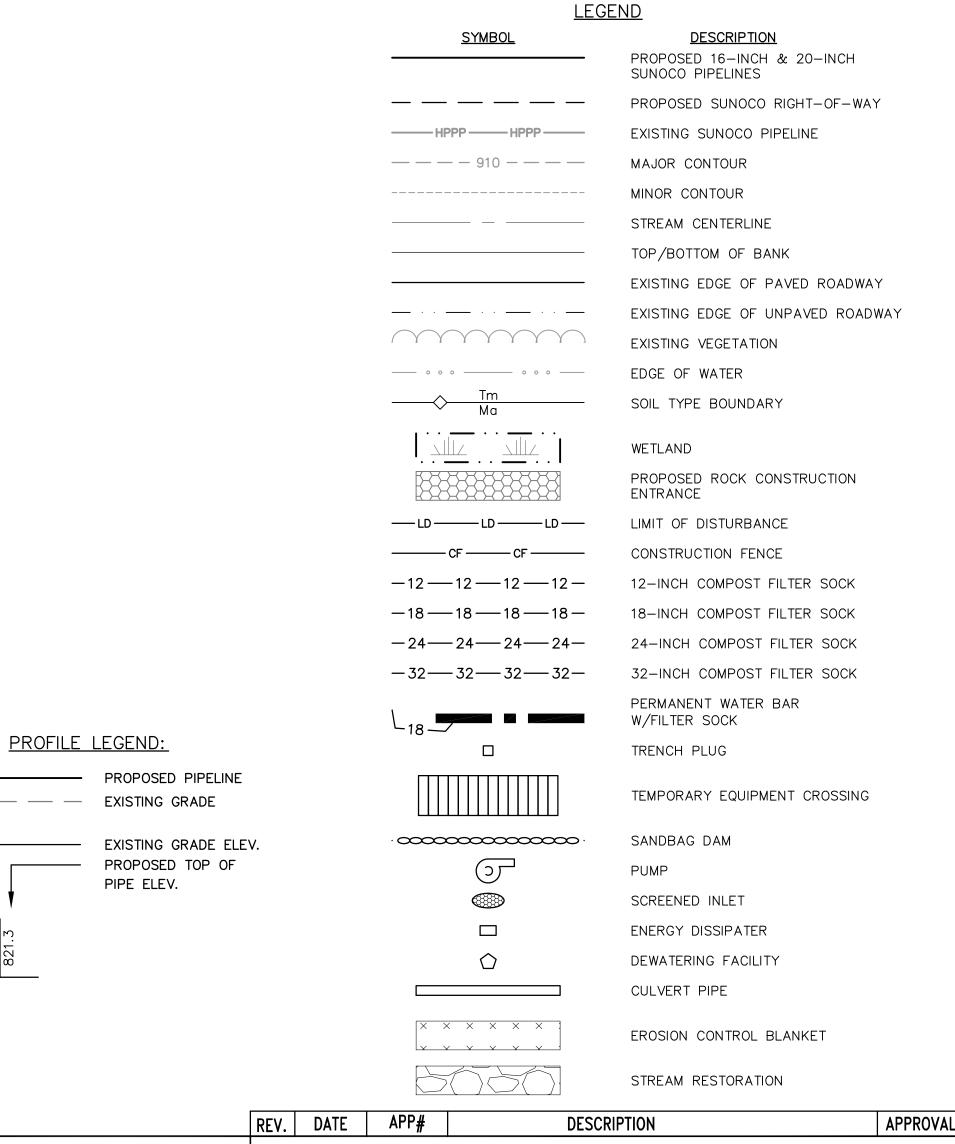

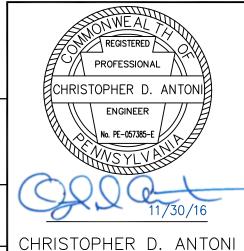

PE-057385-E

DRAWN BY DLH

CHECKED BY CDA

APPROVED BY CDA

DATE 11/30/16


SCALE AS NOTED

OLD DRAWING NO.


PENNSYLVANIA PIPELINE PROJECT
STREAM S-159
RESTORATION PLAN
Partners L.P.

CUMBERLAND COUNTY, PA

DWG. NO. REV. NO. 0

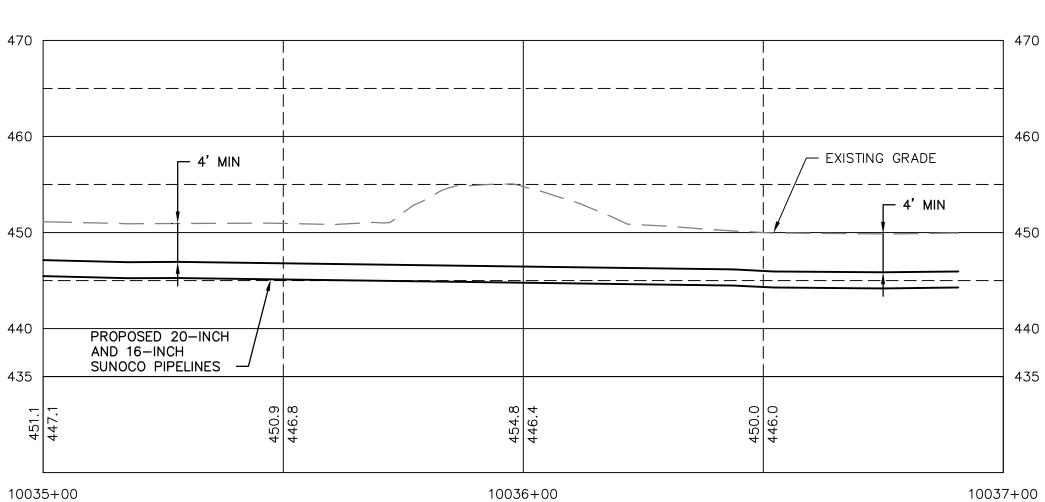

<u>PROFILE</u>

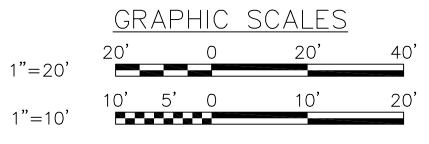

Baltimore, MD Bismarck, ND Denver, CO Douglassville, PA Houston, TX Pittsburgh, PA Williamsport, PA THE LOCATION OF THE PIPELINE FACILITIES AS SHOWN HEREON MUST BE CONSIDERED AS APPROXIMATE ONLY. BEFORE DIGGING OR FOR AN EXACT LOCATION PLEASE CONTACT YOUR STATES UNDERGROUND UTILITY LOCATION STV PROJECT No.: 38-17335

**GENERAL NOTES:** 

- 1. REFERENCE E&S PLAN AND SITE RESTORATION NOTES AND DETAILS FOR ADDITIONAL CONSTRUCTION SEQUENCING, TYPICAL DETAILS AND NOTES (ES-0.01-ES-0.23); AND PLAN SHEETS FOR ADDITIONAL PLANS AND TOPOGRAPHY.
- 2. ALL EXISTING UTILITY INFORMATION IS APPROXIMATE. THE CONTRACTOR IS RESPONSIBLE FOR VERIFYING ALL EXISTING UTILITIES PRIOR TO CONSTRUCTION.
- 3. MAINTAIN 2'-0" MINIMUM VERTICAL SEPARATION BETWEEN THE PROPOSED PIPELINE AND OTHER UTILITIES.
- 4. THE BACKGROUND TOPOGRAPHY WAS OBTAINED FROM TOPOGRAPHIC SURVEYS PERFORMED IN SEPTEMBER 2016.
- 5. THE PROJECT IS LOCATED IN NAD83 PENNSYLVANIA STATE PLANE COORDINATE SYSTEM (SOUTH ZONE), NAVD88.
- 6. EXCAVATION IS LIMITED TO THE CENTERLINE WITH A TYPICAL TRENCH WIDTH OF 4-5'FOR 16/20" PIPELINE.

### WETLAND CROSSING NOTES:

- 1. REFERENCE NOTES AND DETAILS FOR WETLAND CONSTRUCTION SEQUENCING AND WETLAND RESTORATION (ES-0.03, ES-0.08, ES-0.10, AND ES-0.15).
- 2. A MINIMUM OF 4 FEET COVER UNDER WETLANDS AND UPLANDS IS REQUIRED.
- 3. FOR TEMPORARY TIMBER MAT REFERENCE (ES-0.10)
- 4. EROSION CONTROL BLANKET SHALL BE PLACED A MINIMUM OF 50 FEET EDGE OF WETLAND OR 100 FEET FROM EDGE OF WETLAND FOR SPECIAL PROTECTION WATERS (HQ OR EV).

### STREAM CROSSING NOTES:

- 1. REFERENCE NOTES AND DETAILS FOR STREAM CONSTRUCTION SEQUENCING AND STREAM RESTORATION (ES-0.01-ES-0.17).
- 2. FOR TEMPORARY EQUIPMENT CROSSINGS REFERENCE (ES-0.10).

PROFILE LEGEND:

PROPOSED PIPELINE


PIPE ELEV.

EXISTING GRADE

EXISTING GRADE ELEV. PROPOSED TOP OF

- 3. SITE CONDITIONS MAY ALLOW FOR IMPLEMENTATION OF OTHER APPROVED PIPELINE INSTALLATION METHODS REFERENCED WITH THE NOTES AND DETAILS (ES-0.11-ES-0.14).
- 4. THE PIPELINES SHALL MAINTAIN A MINIMUM OF 5 FEET OF COVER UNDER STREAMS FROM THE TOP OF PIPE TO THE STREAM BED. THIS COVER WILL BE MAINTAINED AT A MINIMUM FROM TOP OF BANK TO TOP OF BANK.
- 5. REFERENCE THE STREAM BANK STABILIZATION DETAIL AND STREAM RESTORATION TABLE IN THE NOTES AND DETAILS WHERE RIP-RAP IS PROPOSED (ES-0.18).
- 6. EROSION CONTROL BLANKET SHALL BE PLACED A MINIMUM OF 50 FEET FROM TOP OF BANK OR 100 FEET FROM TOP OF BANK FOR SPECIAL PROTECTION WATERS (HQ OR EV).
- 7. TIMBER MATS SHALL EXTEND A MINIMUM OF 20 FEET BEYOND TOP OF BANK.
- 8. COMPOST FILTER SOCKS SHALL BE INSTALLED ALONG THE TOP OF THE STREAM BANK ACROSS THE RIGHT-OF-WAY WHEN PUMP BYPASS IS NOT IN

<u>LEGEND</u> <u>SYMBOL</u> **DESCRIPTION** PROPOSED 16-INCH & 20-INCH SUNOCO PIPELINES PROPOSED SUNOCO RIGHT-OF-WAY EXISTING SUNOCO PIPELINE MAJOR CONTOUR MINOR CONTOUR STREAM CENTERLINE TOP/BOTTOM OF BANK EXISTING EDGE OF PAVED ROADWAY EXISTING EDGE OF UNPAVED ROADWAY EXISTING VEGETATION SOIL TYPE BOUNDARY WETLAND · — · · — · PROPOSED ROCK CONSTRUCTION ENTRANCE LIMIT OF DISTURBANCE ——— CF ——— CF ——— CONSTRUCTION FENCE 12-INCH COMPOST FILTER SOCK -18 --- 18 --- 18 --- 18 ---18-INCH COMPOST FILTER SOCK -24--24--24--24-24-INCH COMPOST FILTER SOCK -32—32—32—32— 32-INCH COMPOST FILTER SOCK PERMANENT WATER BAR W/FILTER SOCK TRENCH PLUG TEMPORARY EQUIPMENT CROSSING • SANDBAG DAM PUMP SCREENED INLET ENERGY DISSIPATER  $\bigcirc$ DEWATERING FACILITY CULVERT PIPE EROSION CONTROL BLANKET STREAM RESTORATION REV. DATE APP# DESCRIPTION APPROVAL

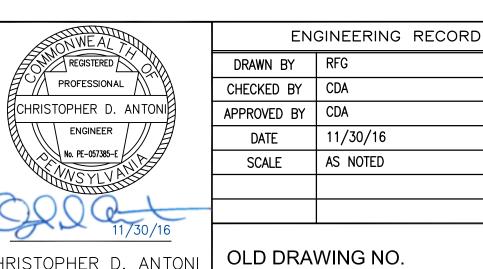

CHRISTOPHER D. ANTONI

PE-057385-E


**Sunoco Logistics** Partners L.P.


DWG. NO.


PENNSYLVANIA PIPELINE PROJECT WETLAND WL-K41 **EXISTING CONDITIONS/EROSION &** SEDIMENTATION CONTROL PLANS

CUMBERLAND COUNTY, PA

REV. NO. WL-K41-A

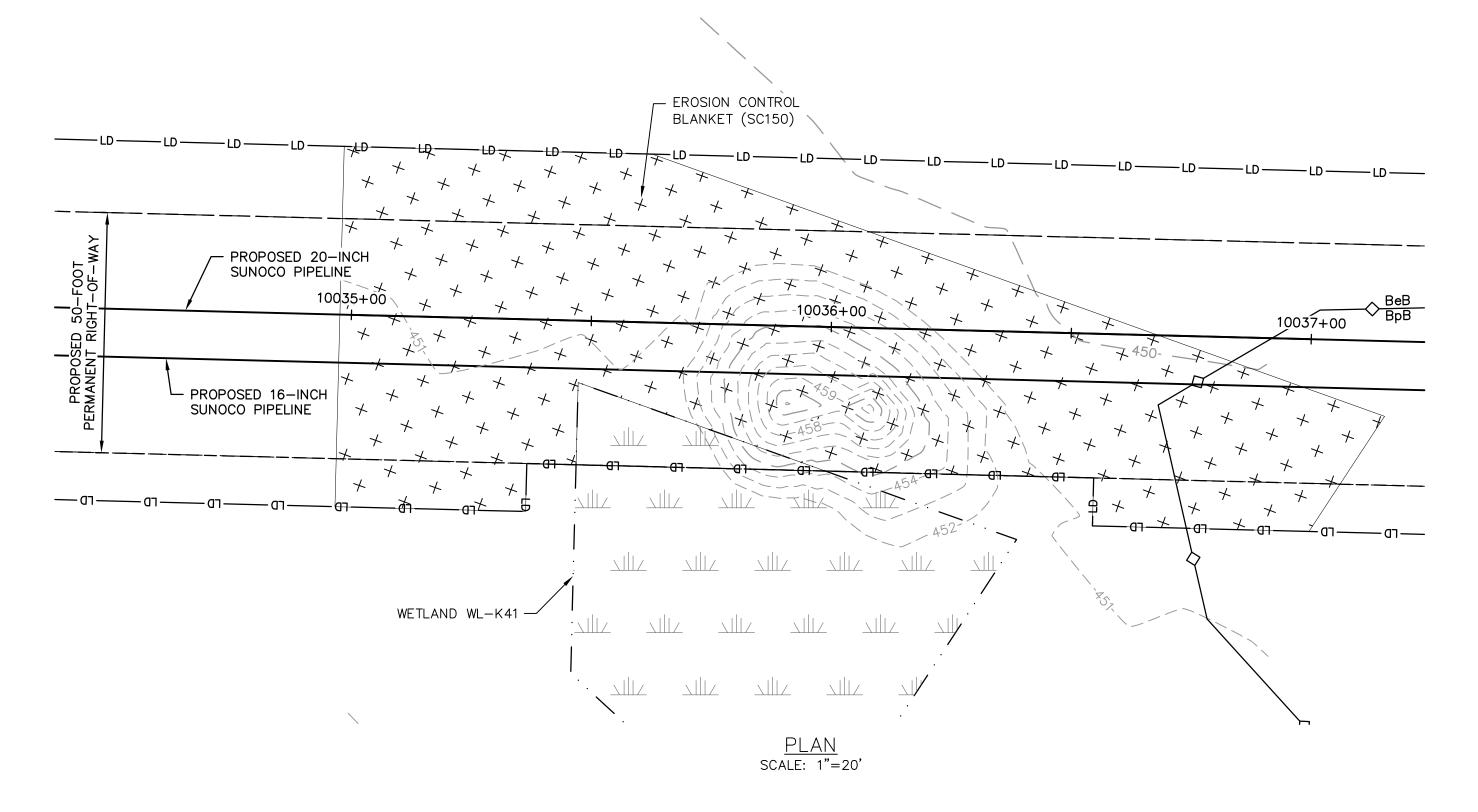

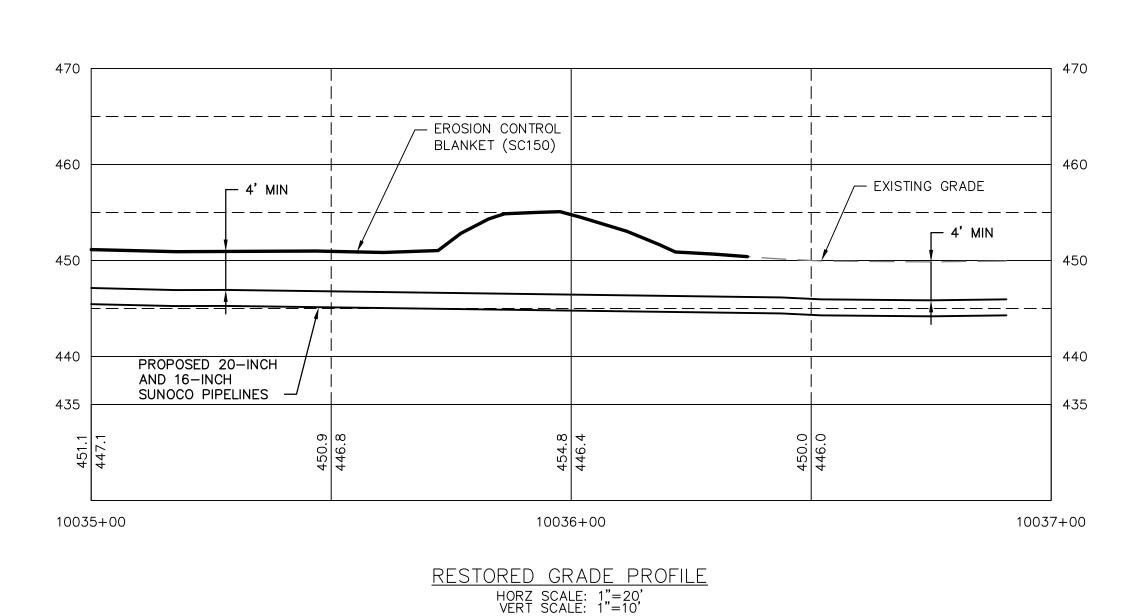

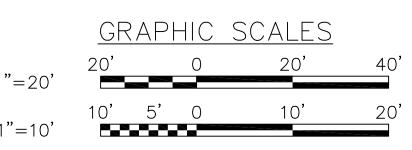

Baltimore, MD Bismarck, ND Denver, CO Douglassville, PA Houston, TX Pittsburgh, PA Williamsport, PA THE LOCATION OF THE PIPELINE FACILITIES AS SHOWN HEREON MUST BE CONSIDERED AS APPROXIMATE ONLY. BEFORE DIGGING OR FOR AN EXACT LOCATION PLEASE CONTACT YOUR STATES UNDERGROUND UTILITY LOCATION STV PROJECT No.: 38-17335

### **GENERAL NOTES:**

- 1. REFERENCE E&S PLAN AND SITE RESTORATION NOTES AND DETAILS FOR ADDITIONAL CONSTRUCTION SEQUENCING, TYPICAL DETAILS AND NOTES (ES-0.01-ES-0.23); AND PLAN SHEETS FOR ADDITIONAL PLANS AND TOPOGRAPHY.
- 2. ALL EXISTING UTILITY INFORMATION IS APPROXIMATE. THE CONTRACTOR IS RESPONSIBLE FOR VERIFYING ALL EXISTING UTILITIES PRIOR TO CONSTRUCTION.
- 3. MAINTAIN 2'-0" MINIMUM VERTICAL SEPARATION BETWEEN THE PROPOSED PIPELINE AND OTHER UTILITIES.
- 4. THE BACKGROUND TOPOGRAPHY WAS OBTAINED FROM TOPOGRAPHIC SURVEYS PERFORMED IN SEPTEMBER 2016.
- 5. THE PROJECT IS LOCATED IN NAD83 PENNSYLVANIA STATE PLANE COORDINATE SYSTEM (SOUTH ZONE), NAVD88.
- 6. EXCAVATION IS LIMITED TO THE CENTERLINE WITH A TYPICAL TRENCH WIDTH OF 4-5'FOR 16/20"PIPELINE.

### WETLAND CROSSING NOTES:

- 1. REFERENCE NOTES AND DETAILS FOR WETLAND CONSTRUCTION SEQUENCING AND WETLAND RESTORATION (ES-0.03, ES-0.08, ES-0.10, AND ES-0.15).
- 2. A MINIMUM OF 4 FEET COVER UNDER WETLANDS AND UPLANDS IS REQUIRED.
- 3. FOR TEMPORARY TIMBER MAT REFERENCE (ES-0.10)
- 4. EROSION CONTROL BLANKET SHALL BE PLACED A MINIMUM OF 50 FEET EDGE OF WETLAND OR 100 FEET FROM EDGE OF WETLAND FOR SPECIAL PROTECTION WATERS (HQ OR EV).

### STREAM CROSSING NOTES:

- 1. REFERENCE NOTES AND DETAILS FOR STREAM CONSTRUCTION SEQUENCING AND STREAM RESTORATION (ES-0.01-ES-0.17).
- 2. FOR TEMPORARY EQUIPMENT CROSSINGS REFERENCE (ES-0.10).
- 3. SITE CONDITIONS MAY ALLOW FOR IMPLEMENTATION OF OTHER APPROVED PIPELINE INSTALLATION METHODS REFERENCED WITH THE NOTES AND DETAILS (ES-0.11-ES-0.14).
- 4. THE PIPELINES SHALL MAINTAIN A MINIMUM OF 5 FEET OF COVER UNDER STREAMS FROM THE TOP OF PIPE TO THE STREAM BED. THIS COVER WILL BE MAINTAINED AT A MINIMUM FROM TOP OF BANK TO TOP OF BANK.
- 5. REFERENCE THE STREAM BANK STABILIZATION DETAIL AND STREAM RESTORATION TABLE IN THE NOTES AND DETAILS WHERE RIP-RAP IS PROPOSED (ES-0.18).
- 6. EROSION CONTROL BLANKET SHALL BE PLACED A MINIMUM OF 50 FEET FROM TOP OF BANK OR 100 FEET FROM TOP OF BANK FOR SPECIAL PROTECTION WATERS (HQ OR EV).
- 7. TIMBER MATS SHALL EXTEND A MINIMUM OF 20 FEET BEYOND TOP OF BANK.
- 8. COMPOST FILTER SOCKS SHALL BE INSTALLED ALONG THE TOP OF THE STREAM BANK ACROSS THE RIGHT-OF-WAY WHEN PUMP BYPASS IS NOT IN

<u>LEGEND</u> <u>SYMBOL</u> **DESCRIPTION** PROPOSED 16-INCH & 20-INCH SUNOCO PIPELINES PROPOSED SUNOCO RIGHT-OF-WAY EXISTING SUNOCO PIPELINE MAJOR CONTOUR MINOR CONTOUR STREAM CENTERLINE TOP/BOTTOM OF BANK EXISTING EDGE OF PAVED ROADWAY EXISTING EDGE OF UNPAVED ROADWAY EXISTING VEGETATION SOIL TYPE BOUNDARY · \_ \_ · · WETLAND · — · · — · PROPOSED ROCK CONSTRUCTION ENTRANCE LIMIT OF DISTURBANCE CONSTRUCTION FENCE ——— CF ——— CF ——— 12-INCH COMPOST FILTER SOCK —18 ——18 ——18 — 18-INCH COMPOST FILTER SOCK -24--24--24--24-24-INCH COMPOST FILTER SOCK -32—32—32—32— 32-INCH COMPOST FILTER SOCK PERMANENT WATER BAR W/FILTER SOCK TRENCH PLUG TEMPORARY EQUIPMENT CROSSING • SANDBAG DAM **F** PUMP SCREENED INLET ENERGY DISSIPATER  $\bigcirc$ DEWATERING FACILITY CULVERT PIPE EROSION CONTROL BLANKET STREAM RESTORATION REV. DATE APP#

DESCRIPTION

REGISTERED PROFESSIONAL CHRISTOPHER D. ANTON ENGINEER No. PE-057385-E

CHRISTOPHER D. ANTONI

PE-057385-E

ENGINEERING RECORD DRAWN BY RFG CHECKED BY CDA APPROVED BY CDA 11/30/16 AS NOTED SCALE

OLD DRAWING NO.

PROFILE LEGEND:

PROPOSED PIPELINE

PIPE ELEV.

EXISTING GRADE

EXISTING GRADE ELEV.

PROPOSED TOP OF

**Sunoco Logistics** Partners L.P.


DWG. NO.


PENNSYLVANIA PIPELINE PROJECT WETLAND WL-K41 **EXISTING CONDITIONS/EROSION &** SEDIMENTATION CONTROL PLANS


CUMBERLAND COUNTY, PA

REV. NO. WL-K41-B

APPROVAL

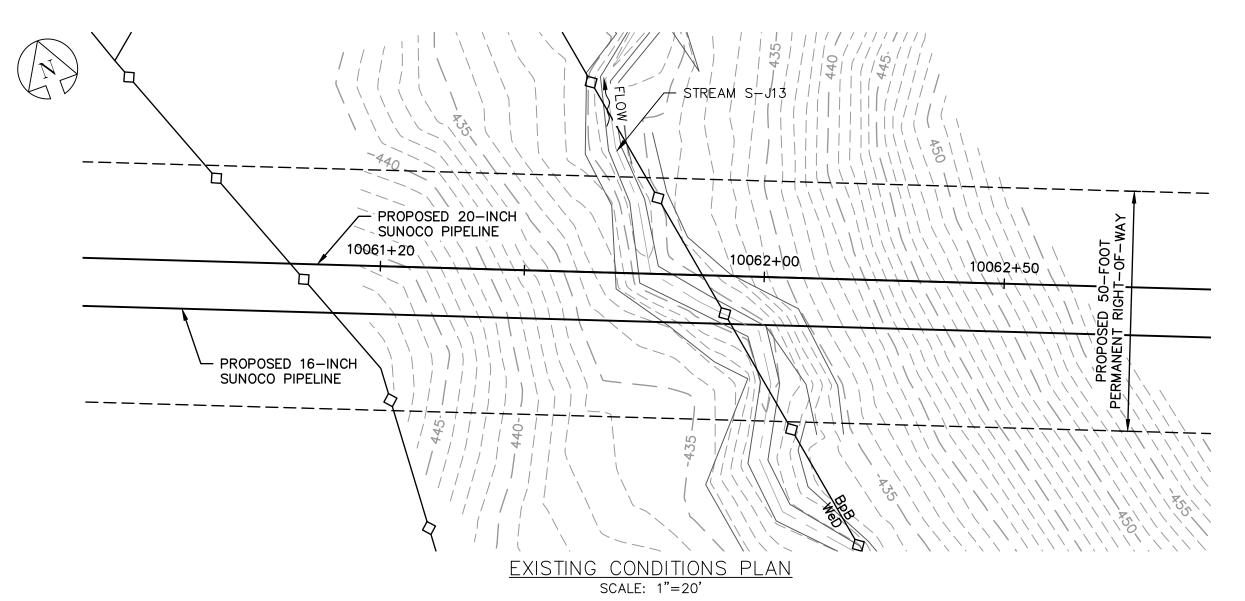


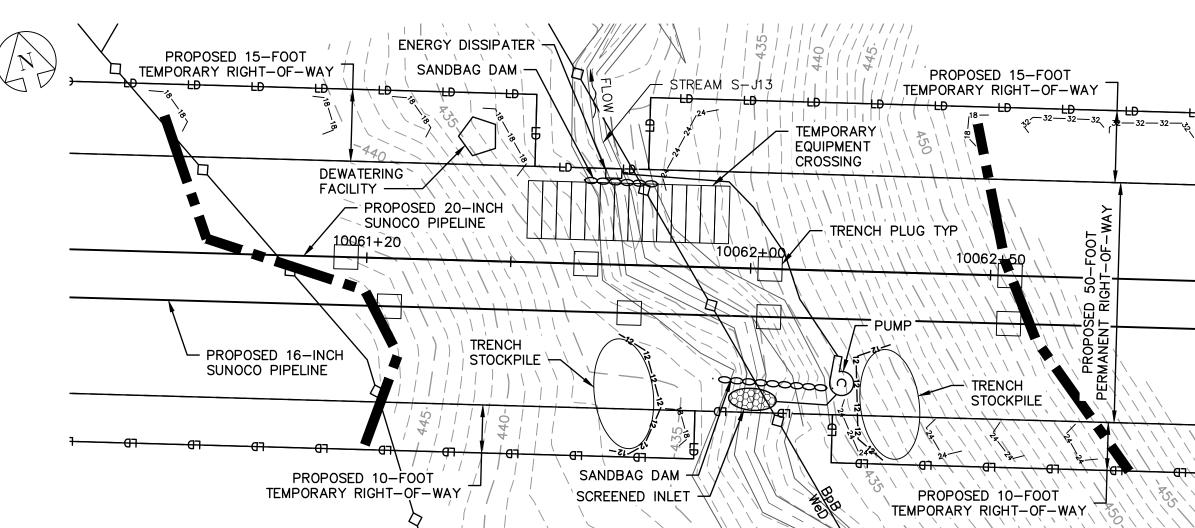


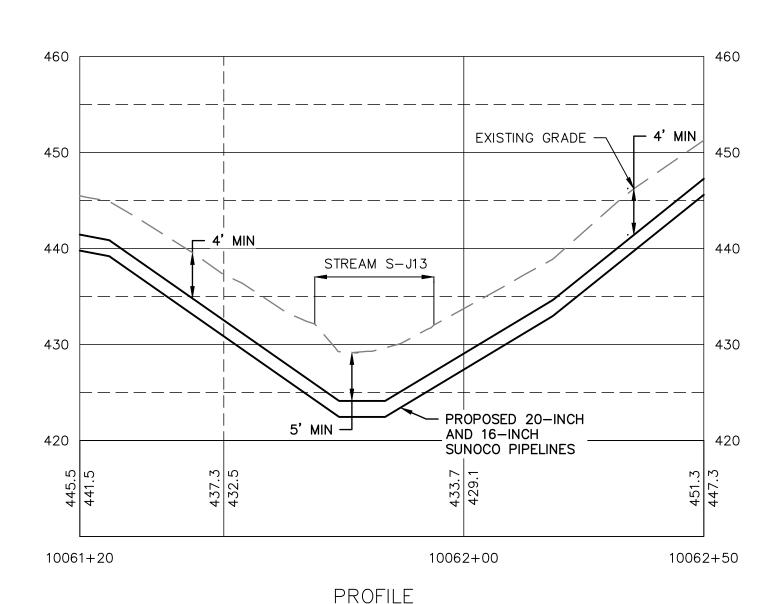

HORZ SCALE: 1"=20' VERT SCALE: 1"=10'

EROSION & SEDIMENTATION CONTROL PLAN SCALE: 1"=20'

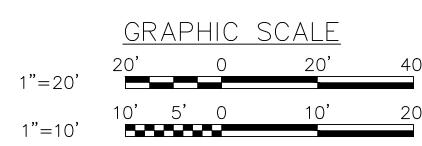

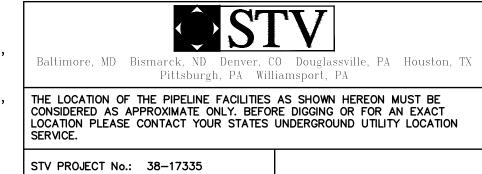

### **GENERAL NOTES:**

- 1. REFERENCE E&S PLAN AND SITE RESTORATION NOTES AND DETAILS FOR ADDITIONAL CONSTRUCTION SEQUENCING, TYPICAL DETAILS AND NOTES (ES-0.01-ES-0.23); AND PLAN SHEETS FOR ADDITIONAL PLANS AND TOPOGRAPHY.
- 2. ALL EXISTING UTILITY INFORMATION IS APPROXIMATE. THE CONTRACTOR IS RESPONSIBLE FOR VERIFYING ALL EXISTING UTILITIES PRIOR TO CONSTRUCTION.
- 3. MAINTAIN 2'-0" MINIMUM VERTICAL SEPARATION BETWEEN THE PROPOSED PIPELINE AND OTHER UTILITIES.
- 4. THE BACKGROUND TOPOGRAPHY WAS OBTAINED FROM TOPOGRAPHIC SURVEYS PERFORMED IN SEPTEMBER 2016.
- 5. THE PROJECT IS LOCATED IN NAD83 PENNSYLVANIA STATE PLANE COORDINATE SYSTEM (SOUTH ZONE), NAVD88.
- 6. EXCAVATION IS LIMITED TO THE CENTERLINE WITH A TYPICAL TRENCH WIDTH OF 4-5'FOR 16/20"PIPELINE.

### WETLAND CROSSING NOTES:

- 1. REFERENCE NOTES AND DETAILS FOR WETLAND CONSTRUCTION SEQUENCING AND WETLAND RESTORATION (ES-0.03, ES-0.08, ES-0.10, AND ES-0.15).
- 2. A MINIMUM OF 4 FEET COVER UNDER WETLANDS AND UPLANDS IS REQUIRED.
- 3. FOR TEMPORARY TIMBER MAT REFERENCE (ES-0.10)
- 4. EROSION CONTROL BLANKET SHALL BE PLACED A MINIMUM OF 50 FEET EDGE OF WETLAND OR 100 FEET FROM EDGE OF WETLAND FOR SPECIAL PROTECTION WATERS (HQ OR EV).

### STREAM CROSSING NOTES:

- 1. REFERENCE NOTES AND DETAILS FOR STREAM CONSTRUCTION SEQUENCING AND STREAM RESTORATION (ES-0.01-ES-0.17).
- 2. FOR TEMPORARY EQUIPMENT CROSSINGS REFERENCE (ES-0.10).
- 3. SITE CONDITIONS MAY ALLOW FOR IMPLEMENTATION OF OTHER APPROVED PIPELINE INSTALLATION METHODS REFERENCED WITH THE NOTES AND DETAILS (ES-0.11-ES-0.14).
- 4. THE PIPELINES SHALL MAINTAIN A MINIMUM OF 5 FEET OF COVER UNDER STREAMS FROM THE TOP OF PIPE TO THE STREAM BED. THIS COVER WILL BE MAINTAINED AT A MINIMUM FROM TOP OF BANK TO TOP OF BANK.
- 5. REFERENCE THE STREAM BANK STABILIZATION DETAIL AND STREAM RESTORATION TABLE IN THE NOTES AND DETAILS WHERE RIP-RAP IS PROPOSED (ES-0.18).
- 6. EROSION CONTROL BLANKET SHALL BE PLACED A MINIMUM OF 50 FEET FROM TOP OF BANK OR 100 FEET FROM TOP OF BANK FOR SPECIAL PROTECTION WATERS (HQ OR EV).
- 7. TIMBER MATS SHALL EXTEND A MINIMUM OF 20 FEET BEYOND TOP OF BANK.
- 8. COMPOST FILTER SOCKS SHALL BE INSTALLED ALONG THE TOP OF THE STREAM BANK ACROSS THE RIGHT-OF-WAY WHEN PUMP BYPASS IS NOT IN PLACE.

<u>LEGEND</u> <u>SYMBOL</u> **DESCRIPTION** PROPOSED 16-INCH & 20-INCH SUNOCO PIPELINES PROPOSED SUNOCO RIGHT-OF-WAY ——— HPPP ——— HPPP ——— EXISTING SUNOCO PIPELINE — — — — 910 — — — — MAJOR CONTOUR MINOR CONTOUR STREAM CENTERLINE TOP/BOTTOM OF BANK EXISTING EDGE OF PAVED ROADWAY EXISTING EDGE OF UNPAVED ROADWAY EXISTING VEGETATION EDGE OF WATER SOIL TYPE BOUNDARY WETLAND PROPOSED ROCK CONSTRUCTION ENTRANCE LIMIT OF DISTURBANCE —LD——LD——LD— CONSTRUCTION FENCE 12-INCH COMPOST FILTER SOCK -18 --- 18 --- 18 --- 18 ---18-INCH COMPOST FILTER SOCK -24-24-24-24-24-INCH COMPOST FILTER SOCK -32—32—32—32— 32-INCH COMPOST FILTER SOCK PERMANENT WATER BAR W/FILTER SOCK TRENCH PLUG TEMPORARY EQUIPMENT CROSSING • SANDBAG DAM PUMP SCREENED INLET ENERGY DISSIPATER DEWATERING FACILITY CULVERT PIPE EROSION CONTROL BLANKET  $\times$   $\times$   $\times$   $\times$   $\times$ STREAM RESTORATION



CHRISTOPHER D. ANTONI

PE-057385-E

ENGINEERING RECORD DRAWN BY RFG CHECKED BY CDA APPROVED BY CDA 11/30/16 DATE AS NOTED SCALE

PROFILE LEGEND:

— — — EXISTING GRADE

PROPOSED PIPELINE

PIPE ELEV.

EXISTING GRADE ELEV.

PROPOSED TOP OF

REV. DATE APP# **Sunoco Logistics** 

PENNSYLVANIA PIPELINE PROJECT STREAM S-J13 **EXISTING CONDITIONS/EROSION &** SEDIMENTATION CONTROL PLANS Partners L.P.


**DESCRIPTION** 


CUMBERLAND COUNTY, PA REV. NO.


APPROVA


0


DWG. NO. OLD DRAWING NO. S-J13-A

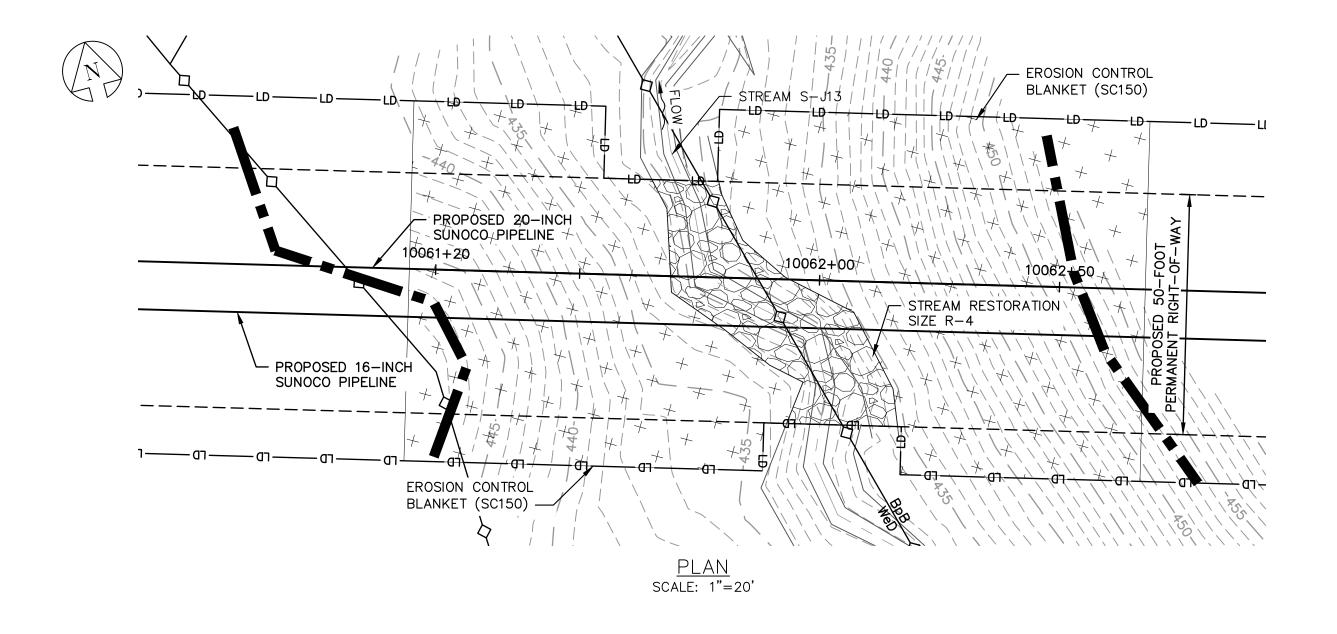

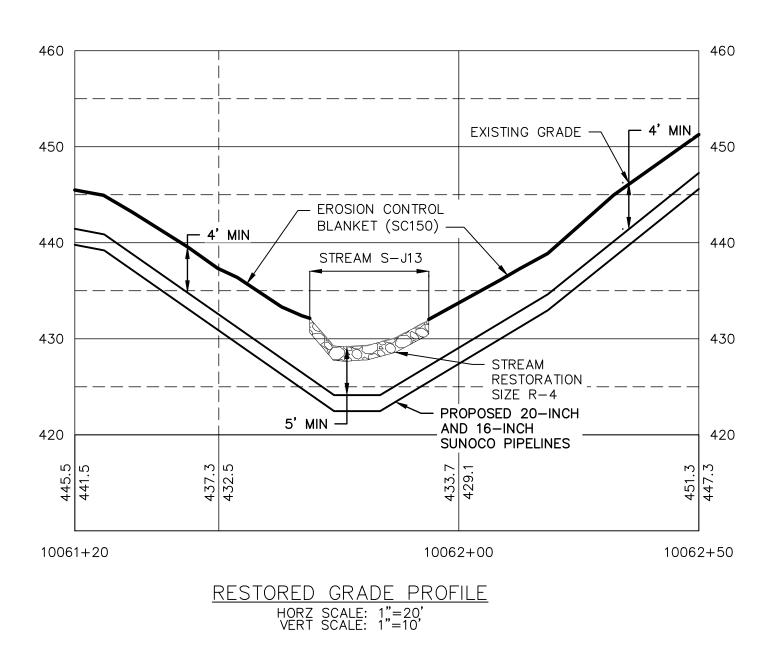

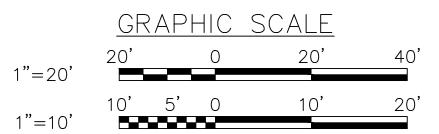

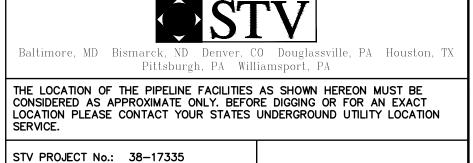

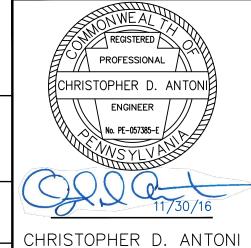

PE-057385-E

ENGINEERING RECORD

DRAWN BY RFG

CHECKED BY CDA

APPROVED BY CDA

DATE 11/30/16

SCALE AS NOTED

OLD DRAWING NO.

PROFILE LEGEND:

— — — EXISTING GRADE

— PROPOSED PIPELINE

EXISTING GRADE ELEV.

PROPOSED TOP OF

PIPE ELEV.

REV. DATE APP#

Sunoco Logistics Partners L.P.

DESCRIPTION APPROVA
PENNSYLVANIA PIPELINE PROJECT
STREAM S-J13

**RESTORATION PLAN** 

STREAM RESTORATION

CUMBERLAND COUNTY, PA

REV. NO.

0

DWG. NO. S-J13-B

### **GENERAL NOTES:**

- 1. REFERENCE E&S PLAN AND SITE RESTORATION NOTES AND DETAILS FOR ADDITIONAL CONSTRUCTION SEQUENCING, TYPICAL DETAILS AND NOTES (ES-0.01-ES-0.23); AND PLAN SHEETS FOR ADDITIONAL PLANS AND TOPOGRAPHY.
- 2. ALL EXISTING UTILITY INFORMATION IS APPROXIMATE. THE CONTRACTOR IS RESPONSIBLE FOR VERIFYING ALL EXISTING UTILITIES PRIOR TO CONSTRUCTION.
- 3. MAINTAIN 2'-0" MINIMUM VERTICAL SEPARATION BETWEEN THE PROPOSED PIPELINE AND OTHER UTILITIES.
- 4. THE BACKGROUND TOPOGRAPHY WAS OBTAINED FROM TOPOGRAPHIC SURVEYS PERFORMED IN SEPTEMBER 2016.
- 5. THE PROJECT IS LOCATED IN NAD83 PENNSYLVANIA STATE PLANE COORDINATE SYSTEM (SOUTH ZONE), NAVD88.
- 6. EXCAVATION IS LIMITED TO THE CENTERLINE WITH A TYPICAL TRENCH WIDTH OF 4-5'FOR 16/20"PIPELINE.

### WETLAND CROSSING NOTES:

- 1. REFERENCE NOTES AND DETAILS FOR WETLAND CONSTRUCTION SEQUENCING AND WETLAND RESTORATION (ES-0.03, ES-0.08, ES-0.10, AND ES-0.15).
- 2. A MINIMUM OF 4 FEET COVER UNDER WETLANDS AND UPLANDS IS REQUIRED.
- 3. FOR TEMPORARY TIMBER MAT REFERENCE (ES-0.10)
- 4. EROSION CONTROL BLANKET SHALL BE PLACED A MINIMUM OF 50 FEET EDGE OF WETLAND OR 100 FEET FROM EDGE OF WETLAND FOR SPECIAL PROTECTION WATERS (HQ OR EV).

### STREAM CROSSING NOTES:

- 1. REFERENCE NOTES AND DETAILS FOR STREAM CONSTRUCTION SEQUENCING AND STREAM RESTORATION (ES-0.01-ES-0.17).
- 2. FOR TEMPORARY EQUIPMENT CROSSINGS REFERENCE (ES-0.10).
- 3. SITE CONDITIONS MAY ALLOW FOR IMPLEMENTATION OF OTHER APPROVED PIPELINE INSTALLATION METHODS REFERENCED WITH THE NOTES AND DETAILS (ES-0.11-ES-0.14).
- 4. THE PIPELINES SHALL MAINTAIN A MINIMUM OF 5 FEET OF COVER UNDER STREAMS FROM THE TOP OF PIPE TO THE STREAM BED. THIS COVER WILL BE MAINTAINED AT A MINIMUM FROM TOP OF BANK TO TOP OF BANK.
- 5. REFERENCE THE STREAM BANK STABILIZATION DETAIL AND STREAM RESTORATION TABLE IN THE NOTES AND DETAILS WHERE RIP—RAP IS PROPOSED (ES—0.18).
- 6. EROSION CONTROL BLANKET SHALL BE PLACED A MINIMUM OF 50 FEET FROM TOP OF BANK OR 100 FEET FROM TOP OF BANK FOR SPECIAL PROTECTION WATERS (HQ OR EV).
- 7. TIMBER MATS SHALL EXTEND A MINIMUM OF 20 FEET BEYOND TOP OF BANK.
- 8. COMPOST FILTER SOCKS SHALL BE INSTALLED ALONG THE TOP OF THE STREAM BANK ACROSS THE RIGHT-OF-WAY WHEN PUMP BYPASS IS NOT IN PLACE.

  LEGEND

<u>SYMBOL</u>

— — — — 910 — — — —

\_\_\_ 。。。 \_\_\_\_ 。。。 \_\_\_

-12 --- 12 --- 12 --- 12 ---

-24-24-24-24-

-32—32—32—32—

•

 $\times$   $\times$   $\times$   $\times$   $\times$ 

<u>DESCRIPTION</u>

EXISTING SUNOCO PIPELINE

SUNOCO PIPELINES

MAJOR CONTOUR

MINOR CONTOUR

STREAM CENTERLINE

TOP/BOTTOM OF BANK

EXISTING VEGETATION

SOIL TYPE BOUNDARY

LIMIT OF DISTURBANCE

CONSTRUCTION FENCE

PROPOSED ROCK CONSTRUCTION

12-INCH COMPOST FILTER SOCK

18-INCH COMPOST FILTER SOCK

24-INCH COMPOST FILTER SOCK

32-INCH COMPOST FILTER SOCK

TEMPORARY EQUIPMENT CROSSING

PERMANENT WATER BAR

W/FILTER SOCK

TRENCH PLUG

SANDBAG DAM

SCREENED INLET

CULVERT PIPE

ENERGY DISSIPATER

DEWATERING FACILITY

EROSION CONTROL BLANKET

PUMP

EDGE OF WATER

WETLAND


ENTRANCE


PROPOSED 16-INCH & 20-INCH


PROPOSED SUNOCO RIGHT-OF-WAY


EXISTING EDGE OF PAVED ROADWAY

EXISTING EDGE OF UNPAVED ROADWAY

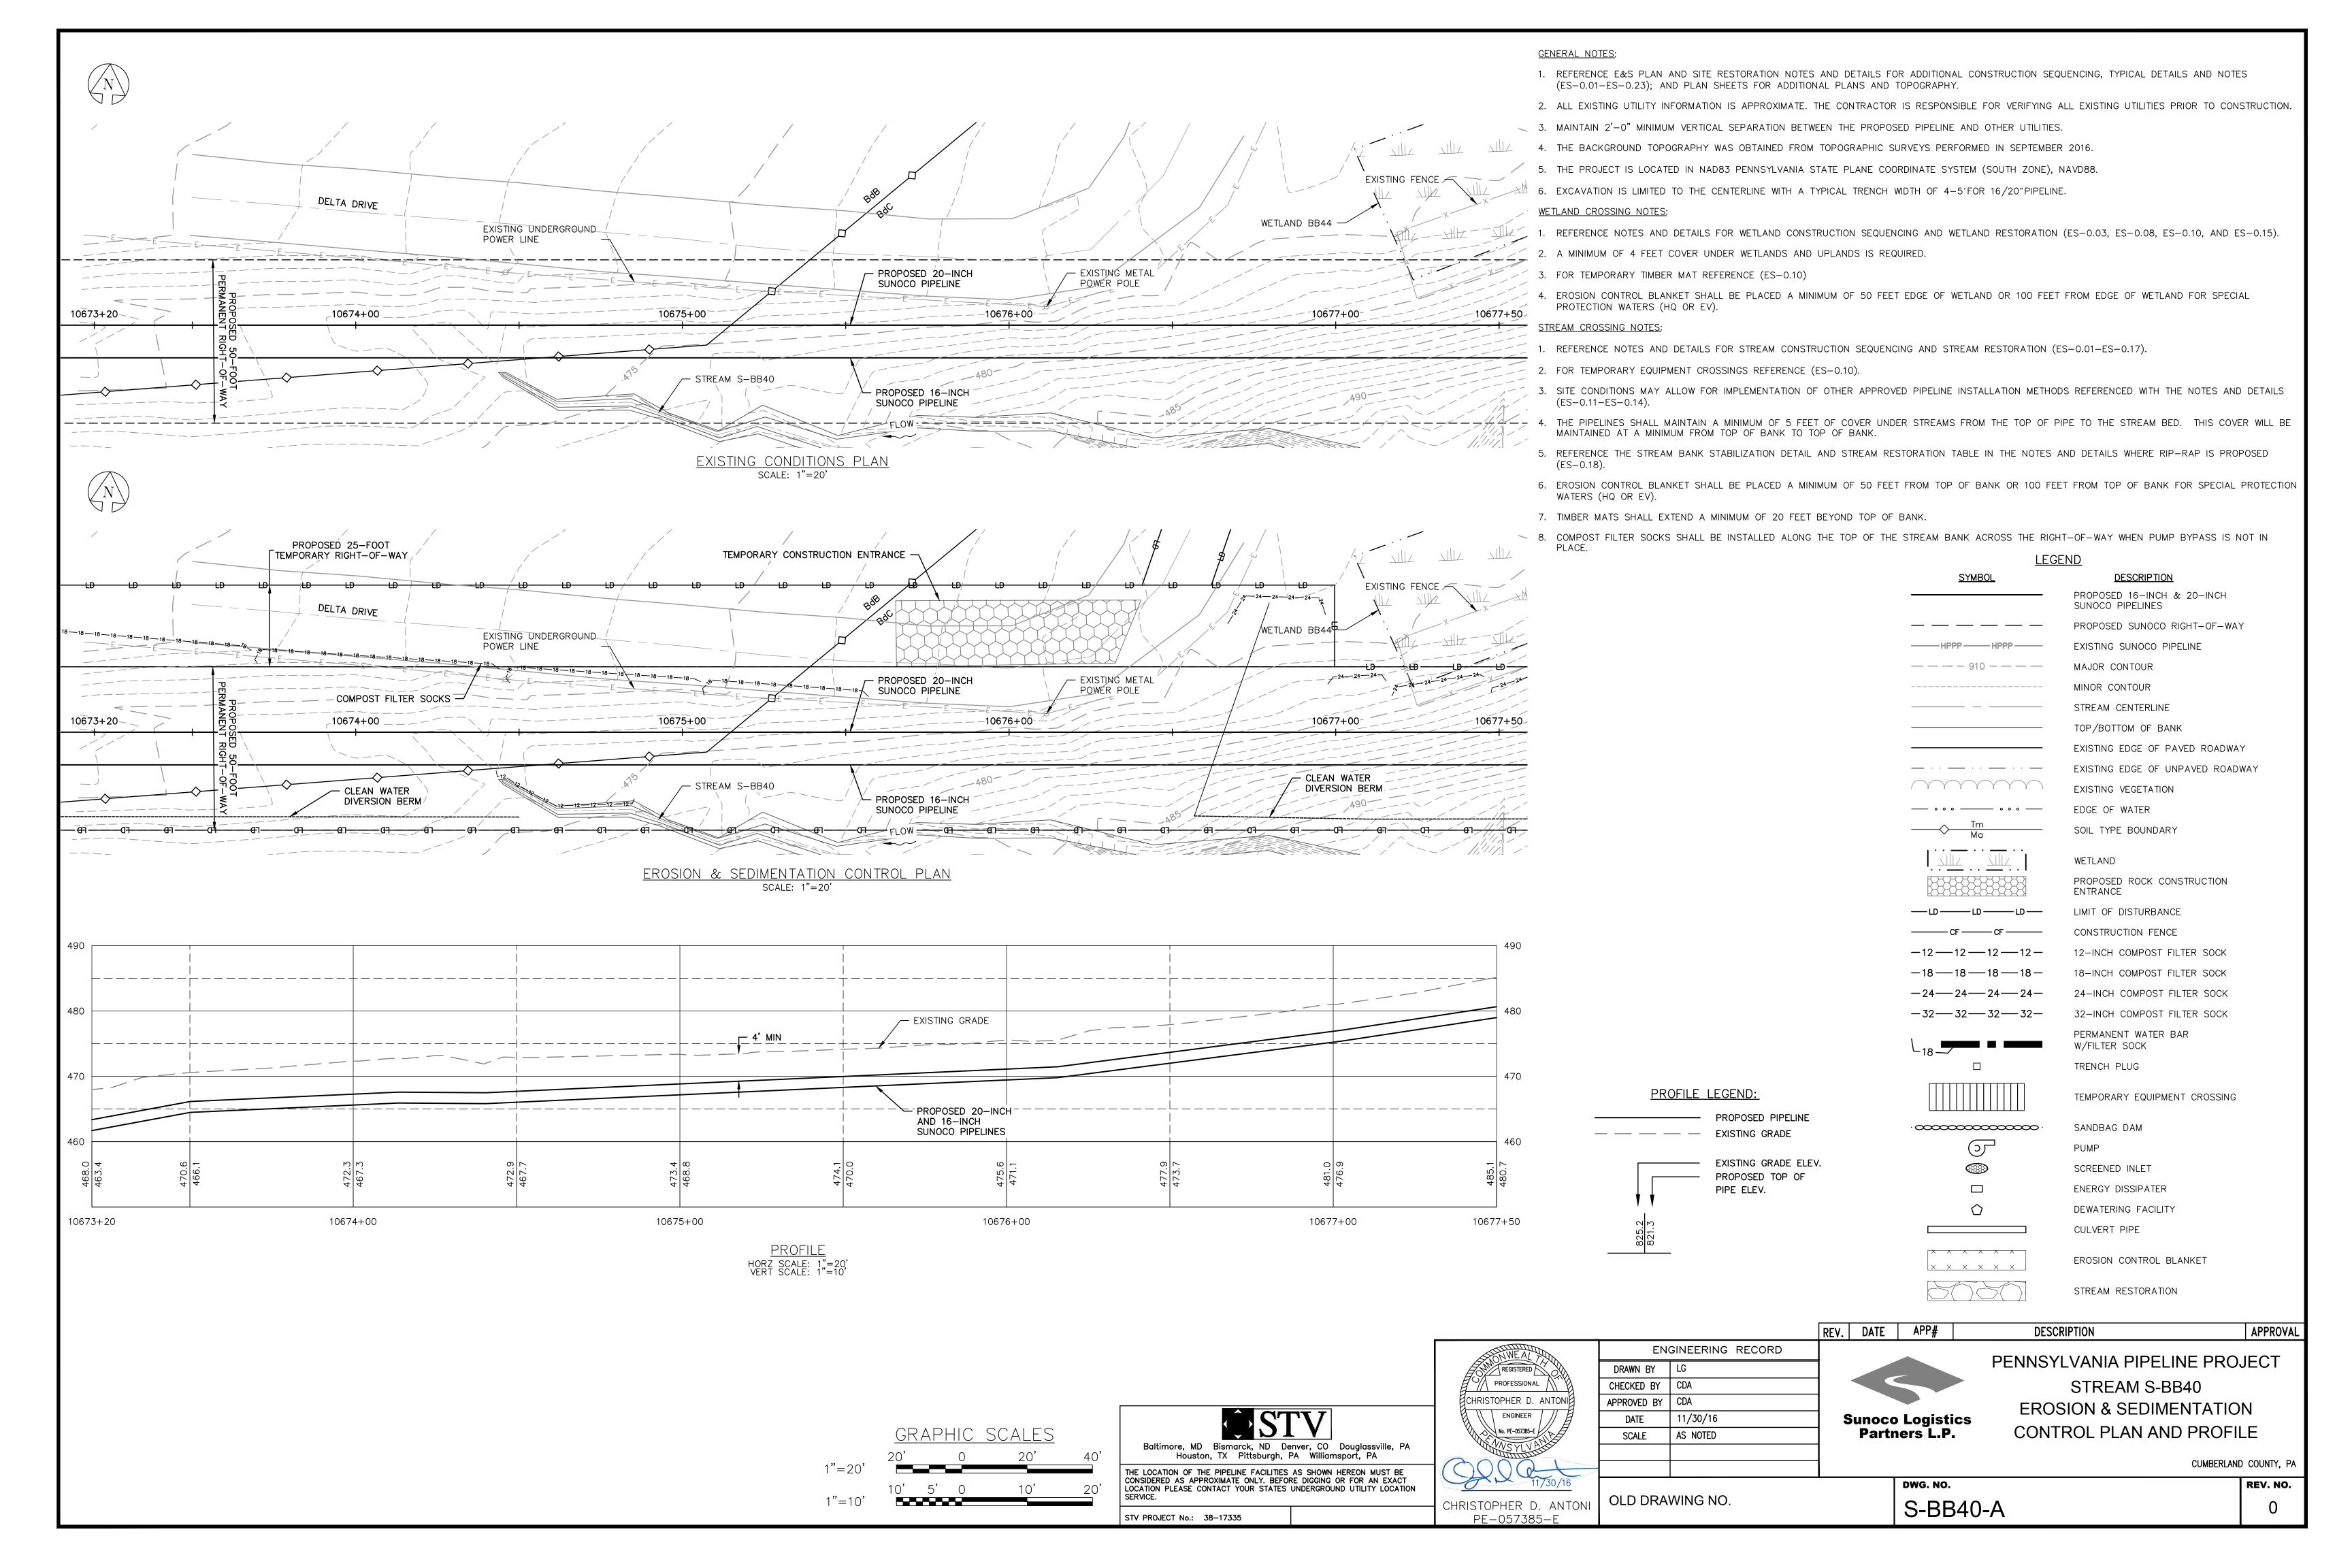


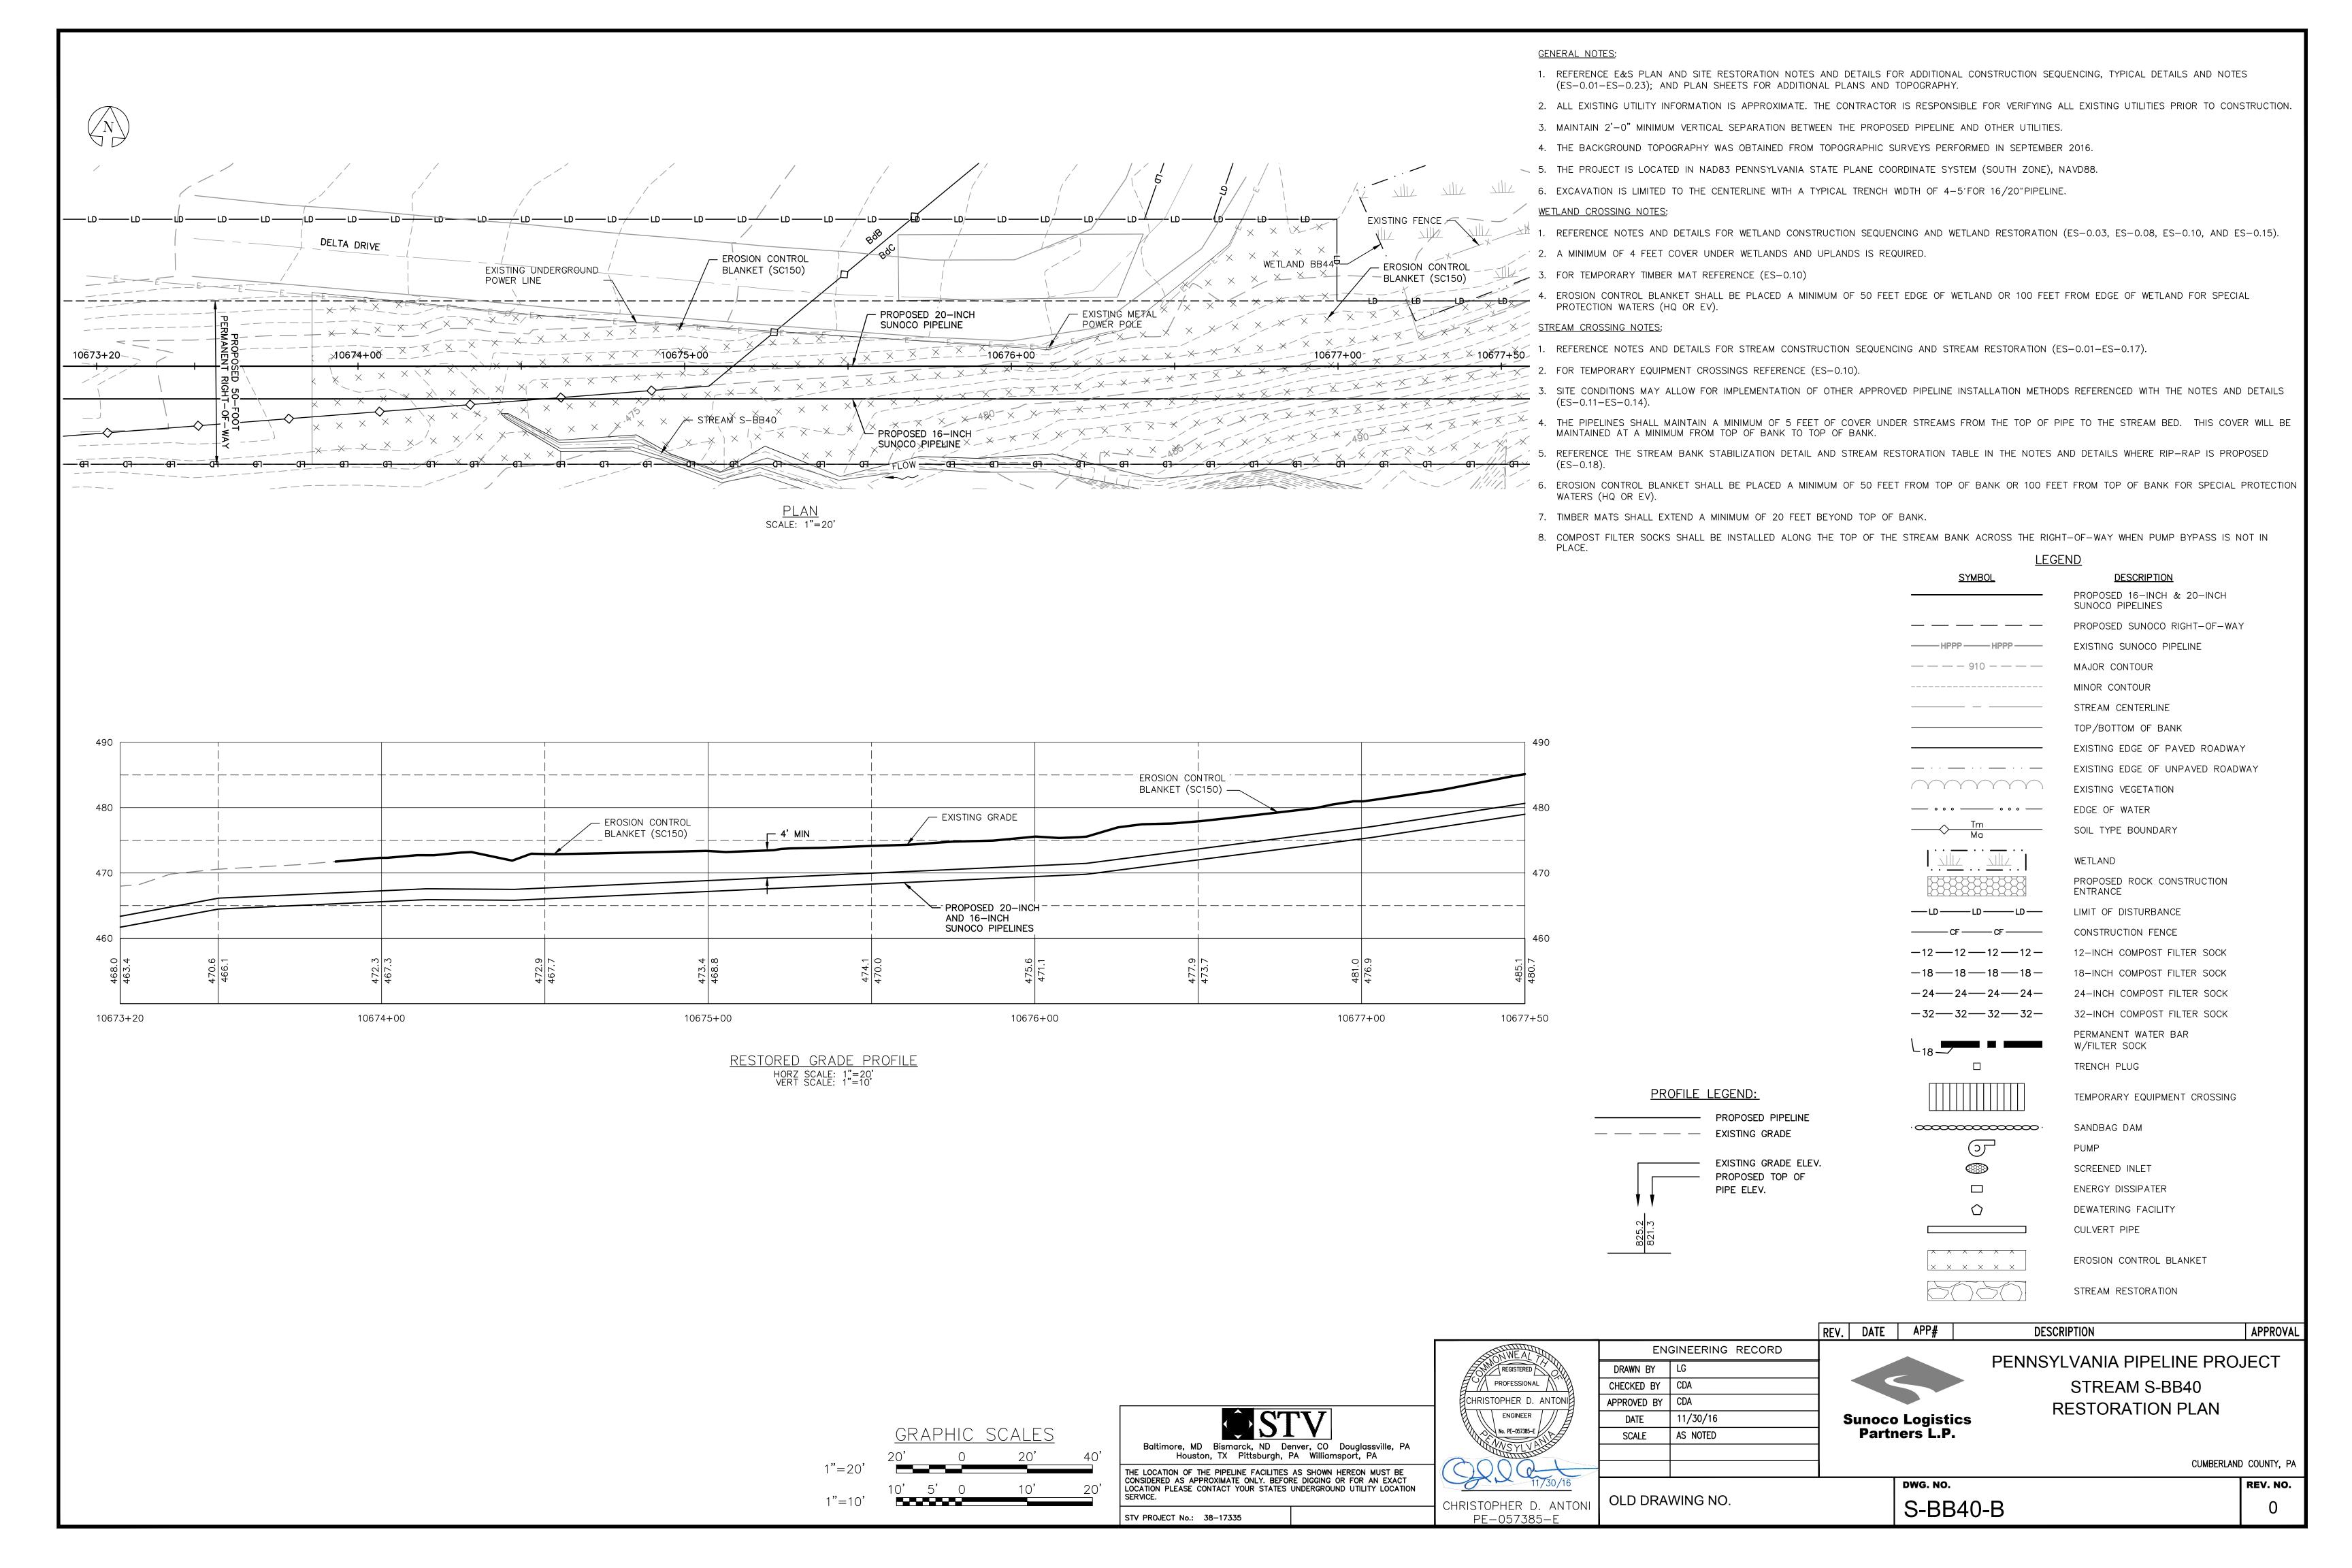

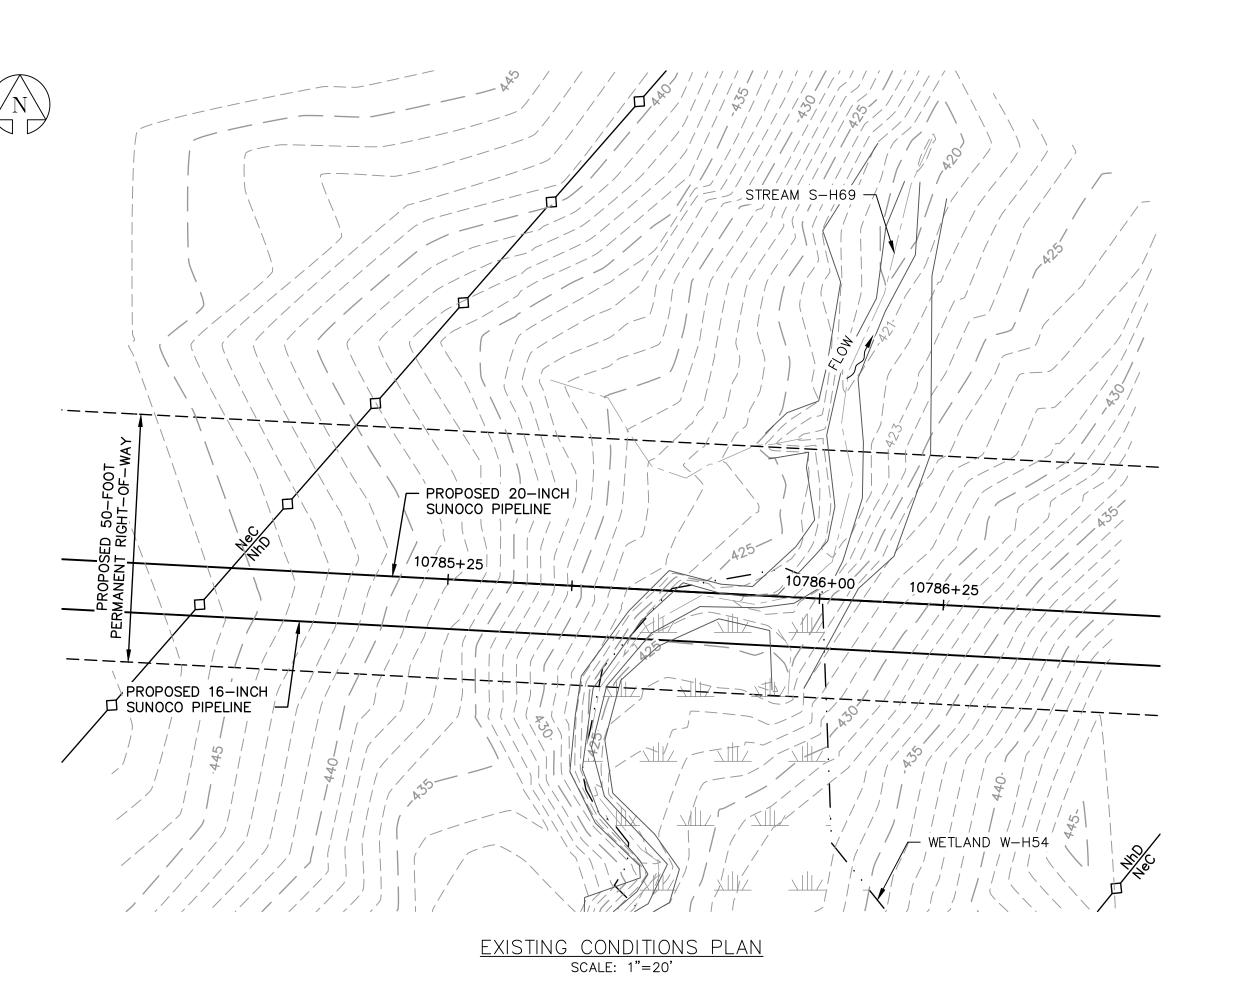

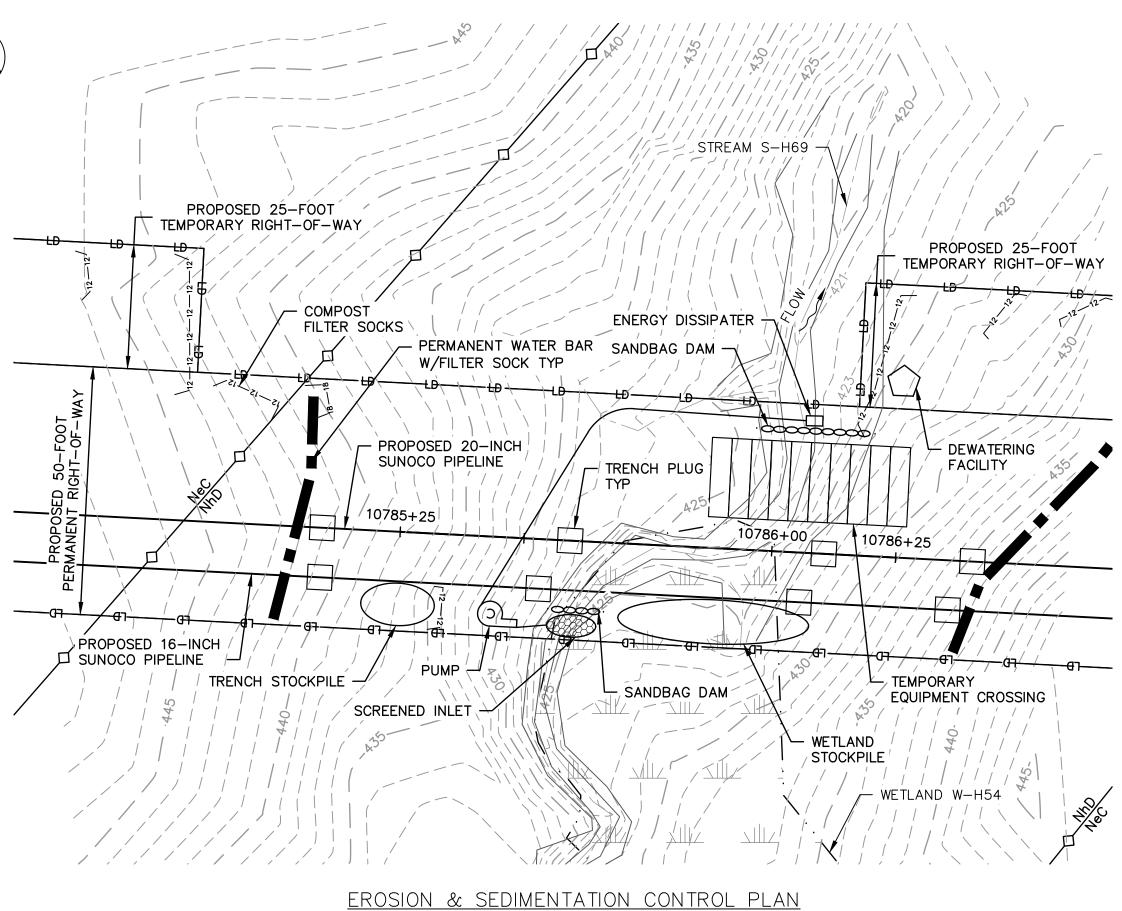

SCALE: 1"=20'

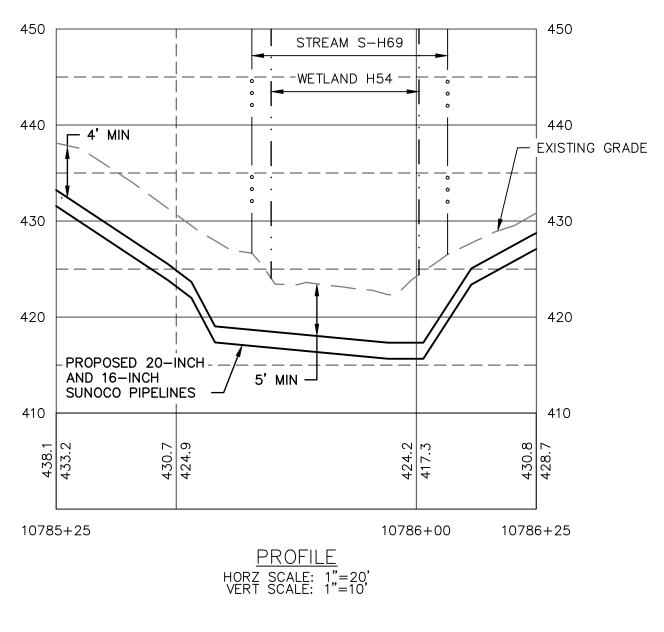

### **GENERAL NOTES:**


- 1. REFERENCE E&S PLAN AND SITE RESTORATION NOTES AND DETAILS FOR ADDITIONAL CONSTRUCTION SEQUENCING, TYPICAL DETAILS AND NOTES (ES-0.01-ES-0.23); AND PLAN SHEETS FOR ADDITIONAL PLANS AND TOPOGRAPHY.
- 2. ALL EXISTING UTILITY INFORMATION IS APPROXIMATE. THE CONTRACTOR IS RESPONSIBLE FOR VERIFYING ALL EXISTING UTILITIES PRIOR TO CONSTRUCTION.
- 3. MAINTAIN 2'-0" MINIMUM VERTICAL SEPARATION BETWEEN THE PROPOSED PIPELINE AND OTHER UTILITIES.
- 4. THE BACKGROUND TOPOGRAPHY WAS OBTAINED FROM TOPOGRAPHIC SURVEYS PERFORMED IN SEPTEMBER 2016.
- 5. THE PROJECT IS LOCATED IN NAD83 PENNSYLVANIA STATE PLANE COORDINATE SYSTEM (SOUTH ZONE), NAVD88.
- 6. EXCAVATION IS LIMITED TO THE CENTERLINE WITH A TYPICAL TRENCH WIDTH OF 4-5'FOR 16/20"PIPELINE.


### WETLAND CROSSING NOTES:

- 1. REFERENCE NOTES AND DETAILS FOR WETLAND CONSTRUCTION SEQUENCING AND WETLAND RESTORATION (ES-0.03, ES-0.08, ES-0.10, AND ES-0.15).
- 2. A MINIMUM OF 4 FEET COVER UNDER WETLANDS AND UPLANDS IS REQUIRED.
- 3. FOR TEMPORARY TIMBER MAT REFERENCE (ES-0.10)
- 4. EROSION CONTROL BLANKET SHALL BE PLACED A MINIMUM OF 50 FEET EDGE OF WETLAND OR 100 FEET FROM EDGE OF WETLAND FOR SPECIAL PROTECTION WATERS (HQ OR EV).

### STREAM CROSSING NOTES:


- 1. REFERENCE NOTES AND DETAILS FOR STREAM CONSTRUCTION SEQUENCING AND STREAM RESTORATION (ES-0.01-ES-0.17).
- 2. FOR TEMPORARY EQUIPMENT CROSSINGS REFERENCE (ES-0.10).
- 3. SITE CONDITIONS MAY ALLOW FOR IMPLEMENTATION OF OTHER APPROVED PIPELINE INSTALLATION METHODS REFERENCED WITH THE NOTES AND DETAILS (ES-0.11-ES-0.14).
- 4. THE PIPELINES SHALL MAINTAIN A MINIMUM OF 5 FEET OF COVER UNDER STREAMS FROM THE TOP OF PIPE TO THE STREAM BED. THIS COVER WILL BE MAINTAINED AT A MINIMUM FROM TOP OF BANK TO TOP OF BANK.
- 5. REFERENCE THE STREAM BANK STABILIZATION DETAIL AND STREAM RESTORATION TABLE IN THE NOTES AND DETAILS WHERE RIP-RAP IS PROPOSED (ES-0.18).
- 6. EROSION CONTROL BLANKET SHALL BE PLACED A MINIMUM OF 50 FEET FROM TOP OF BANK OR 100 FEET FROM TOP OF BANK FOR SPECIAL PROTECTION WATERS (HQ OR EV).
- 7. TIMBER MATS SHALL EXTEND A MINIMUM OF 20 FEET BEYOND TOP OF BANK.
- 8. COMPOST FILTER SOCKS SHALL BE INSTALLED ALONG THE TOP OF THE STREAM BANK ACROSS THE RIGHT-OF-WAY WHEN PUMP BYPASS IS NOT IN

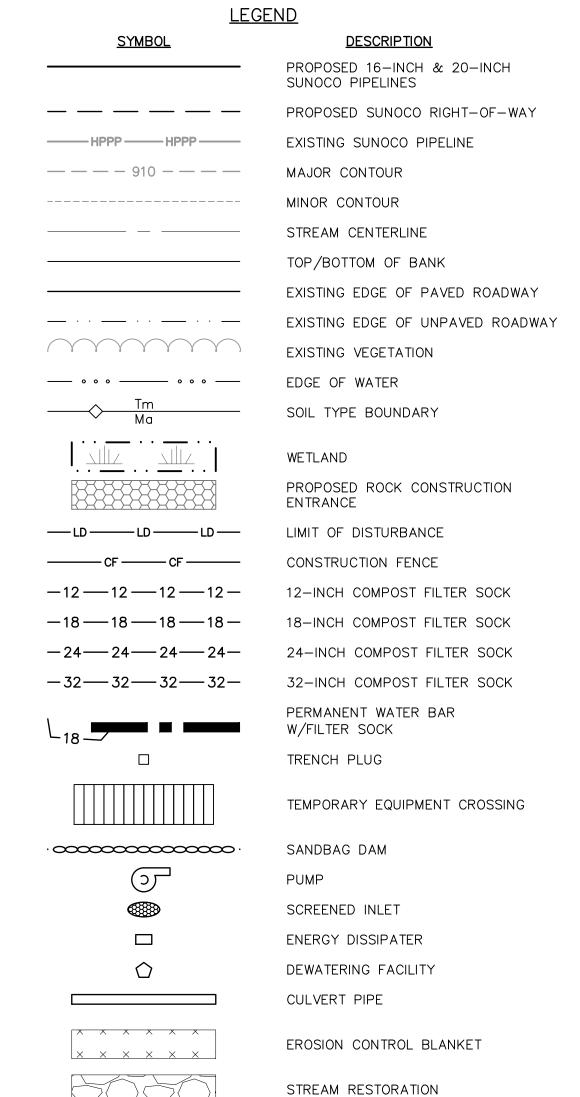

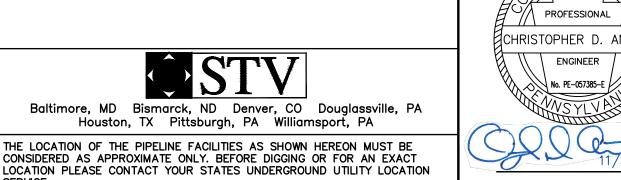

GRAPHIC SCALES

1"=20'

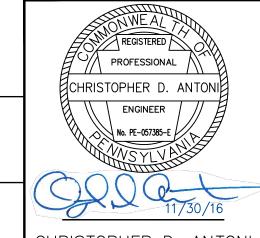

ENGINEERING RECORD DRAWN BY RFG CHECKED BY CDA APPROVED BY CDA 11/30/16 DATE AS NOTED SCALE

PROFILE LEGEND:

— — EXISTING GRADE

PROPOSED PIPELINE

EXISTING GRADE ELEV.

PROPOSED TOP OF

PIPE ELEV.



PENNSYLVANIA PIPELINE PROJECT STREAM S-H69 **EXISTING CONDITIONS/EROSION &** SEDIMENTATION CONTROL PLANS

> CUMBERLAND COUNTY, PA REV. NO.

APPROVA

0


OLD DRAWING NO.


CHRISTOPHER D. ANTONI STV PROJECT No.: 38-17335 PE-057385-E

DWG. NO. S-H69-A

Partners L.P.

**DESCRIPTION** 

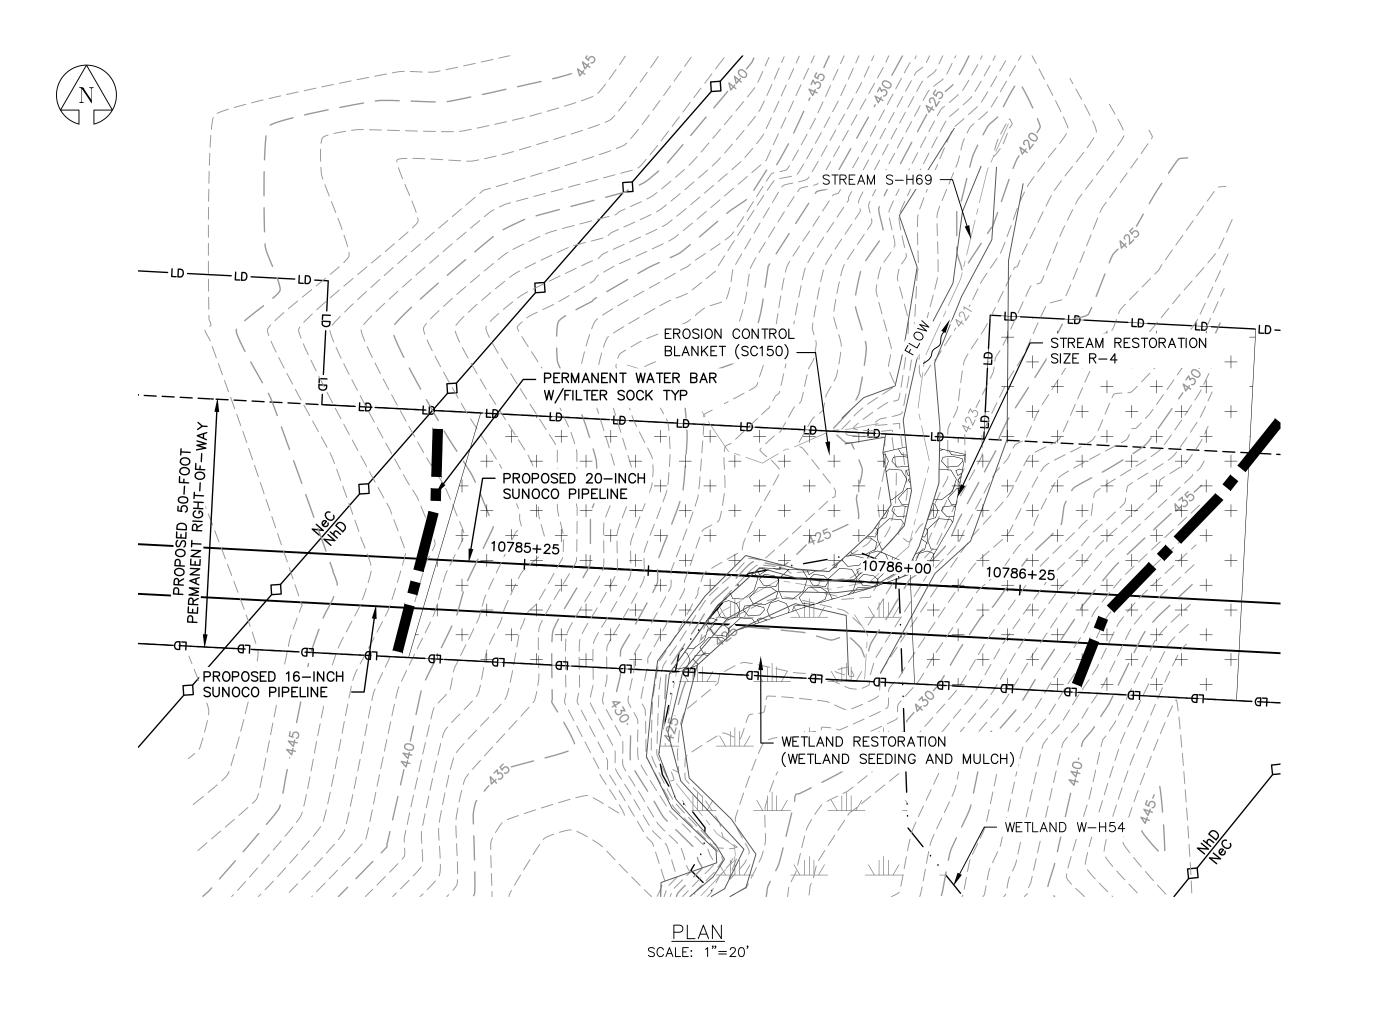

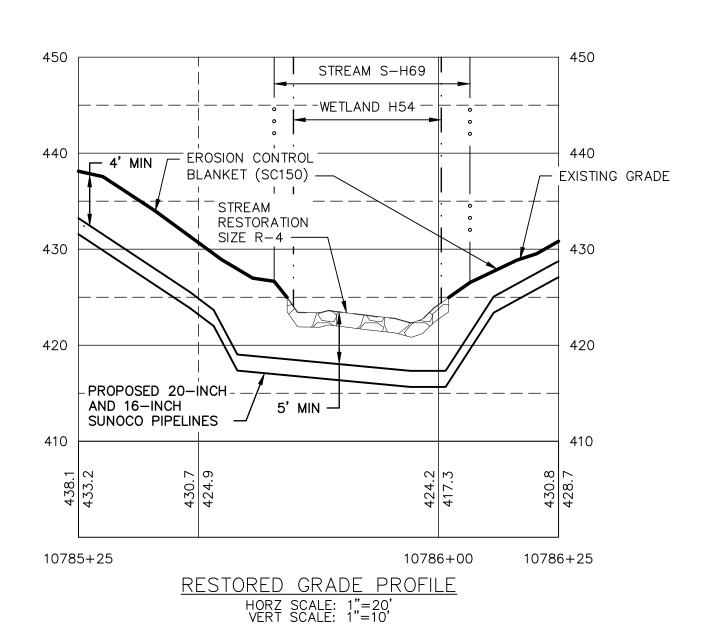

### GRAPHIC SCALES 1"=20'



THE LOCATION OF THE PIPELINE FACILITIES AS SHOWN HEREON MUST BE CONSIDERED AS APPROXIMATE ONLY. BEFORE DIGGING OR FOR AN EXACT LOCATION PLEASE CONTACT YOUR STATES UNDERGROUND UTILITY LOCATION STV PROJECT No.: 38-17335

### **GENERAL NOTES:**

- 1. REFERENCE E&S PLAN AND SITE RESTORATION NOTES AND DETAILS FOR ADDITIONAL CONSTRUCTION SEQUENCING, TYPICAL DETAILS AND NOTES (ES-0.01-ES-0.23); AND PLAN SHEETS FOR ADDITIONAL PLANS AND TOPOGRAPHY.
- 2. ALL EXISTING UTILITY INFORMATION IS APPROXIMATE. THE CONTRACTOR IS RESPONSIBLE FOR VERIFYING ALL EXISTING UTILITIES PRIOR TO CONSTRUCTION.
- 3. MAINTAIN 2'-0" MINIMUM VERTICAL SEPARATION BETWEEN THE PROPOSED PIPELINE AND OTHER UTILITIES.
- 4. THE BACKGROUND TOPOGRAPHY WAS OBTAINED FROM TOPOGRAPHIC SURVEYS PERFORMED IN SEPTEMBER 2016.
- 5. THE PROJECT IS LOCATED IN NAD83 PENNSYLVANIA STATE PLANE COORDINATE SYSTEM (SOUTH ZONE), NAVD88.


### 6. EXCAVATION IS LIMITED TO THE CENTERLINE WITH A TYPICAL TRENCH WIDTH OF 4-5'FOR 16/20"PIPELINE.


- 1. REFERENCE NOTES AND DETAILS FOR WETLAND CONSTRUCTION SEQUENCING AND WETLAND RESTORATION (ES-0.03, ES-0.08, ES-0.10, AND ES-0.15).
- 2. A MINIMUM OF 4 FEET COVER UNDER WETLANDS AND UPLANDS IS REQUIRED.
- 3. FOR TEMPORARY TIMBER MAT REFERENCE (ES-0.10)
- 4. EROSION CONTROL BLANKET SHALL BE PLACED A MINIMUM OF 50 FEET EDGE OF WETLAND OR 100 FEET FROM EDGE OF WETLAND FOR SPECIAL PROTECTION WATERS (HQ OR EV).

### STREAM CROSSING NOTES:

WETLAND CROSSING NOTES:

- 1. REFERENCE NOTES AND DETAILS FOR STREAM CONSTRUCTION SEQUENCING AND STREAM RESTORATION (ES-0.01-ES-0.17).
- 2. FOR TEMPORARY EQUIPMENT CROSSINGS REFERENCE (ES-0.10).
- 3. SITE CONDITIONS MAY ALLOW FOR IMPLEMENTATION OF OTHER APPROVED PIPELINE INSTALLATION METHODS REFERENCED WITH THE NOTES AND DETAILS (ES-0.11-ES-0.14).
- 4. THE PIPELINES SHALL MAINTAIN A MINIMUM OF 5 FEET OF COVER UNDER STREAMS FROM THE TOP OF PIPE TO THE STREAM BED. THIS COVER WILL BE MAINTAINED AT A MINIMUM FROM TOP OF BANK TO TOP OF BANK.
- 5. REFERENCE THE STREAM BANK STABILIZATION DETAIL AND STREAM RESTORATION TABLE IN THE NOTES AND DETAILS WHERE RIP-RAP IS PROPOSED (ES-0.18).
- 6. EROSION CONTROL BLANKET SHALL BE PLACED A MINIMUM OF 50 FEET FROM TOP OF BANK OR 100 FEET FROM TOP OF BANK FOR SPECIAL PROTECTION WATERS (HQ OR EV).
- 7. TIMBER MATS SHALL EXTEND A MINIMUM OF 20 FEET BEYOND TOP OF BANK.
- 8. COMPOST FILTER SOCKS SHALL BE INSTALLED ALONG THE TOP OF THE STREAM BANK ACROSS THE RIGHT-OF-WAY WHEN PUMP BYPASS IS NOT IN

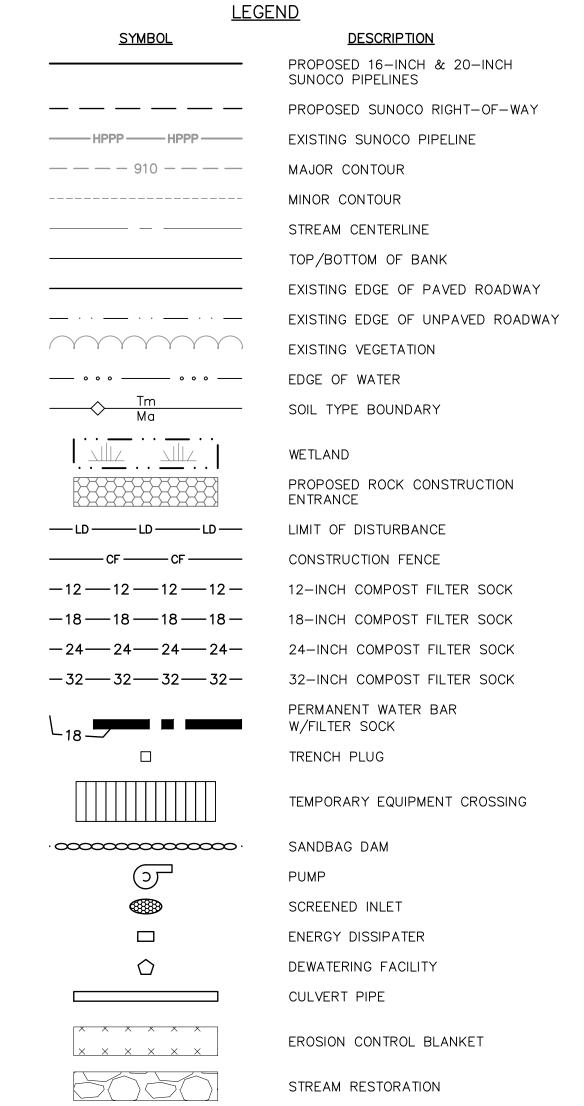

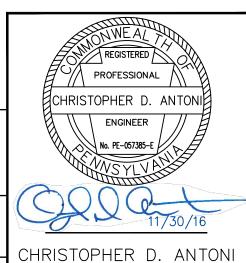

PE-057385-E

ENGINEERING RECORD DRAWN BY RFG CHECKED BY CDA APPROVED BY CDA 11/30/16 DATE SCALE AS NOTED

PROFILE LEGEND:

— — EXISTING GRADE

PROPOSED PIPELINE

EXISTING GRADE ELEV.

PROPOSED TOP OF

PIPE ELEV.

REV. DATE APP# Sunoco Logistics Partners L.P.

APPROVA **DESCRIPTION** PENNSYLVANIA PIPELINE PROJECT STREAM S-H69 **RESTORATION PLAN** 

CUMBERLAND COUNTY, PA

REV. NO.

0

DWG. NO. OLD DRAWING NO.

S-H69-B