


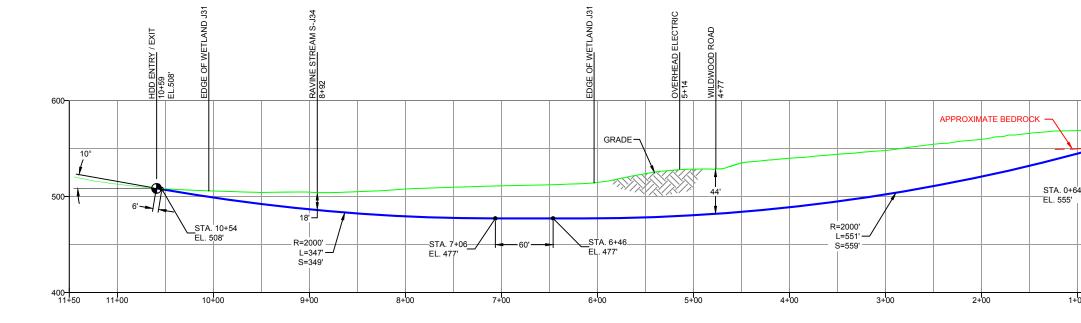

**PROFILE VIEW** 



DESIGN AND CONSTRUCTION:


- CONTRACTOR SHALL FIELD VERIFY DEPTH OF ALL EXITING UTILITIES SHOWN OR NOT SHOWN ON
  THIS DRAWING.
- THIS DRAWING. 2. THE MINIMUM SEPARATION DISTANCE FROM EXISTING SUBSURFACE UTILITIES SHALL NOT BE LESS THAN 10 FEET AS MEASURED FROM THE OUTSIDE EDGE OF THE UTILITY TO OUTSIDE OF PROPOSED PIPELINE. 3. DESIGNED IN ACCORDANCE WITH CFR 49 195 & ASME B31.4 4. CROSSING PIPE SPECIFICATION: HDD HORZ. LENGTH (L=):1021' HDD PIPE LENGTH (L=):1021' HDD PIPE LENGTH (S=):1032' 20'x 0.456' WT.X.\*65, APISL, PSL2, ERW, BFW COATING: 14-16 MILS FBE WITH 30-35 MIL ARO (POWERCRETE R95)

- 5. INTERNAL DESIGN PRESSURE 1480 PSIG (SEAM FACTOR 1.0, DESIGH FACTOR 0.50).
- INTERNAL DESIGNER HAD YOU GENERAL DIRECTIONAL DESIGN FACTOR U.S.). INSTALLATION METHOD: HORIZONTAL DIRECTIONAL DRILL (HDD). PIPELINE WARNING MARKERS SHALL BE INSTALLED ON BOTH SIDES OF ALL ROAD, RAILWAY, AND STREAM (FORSINGS.
- STREAM CROSSINGS. 8. CARRIER PIPE NOT ENCASED. 9. PIPE / AMBIENT TEMPERATURE MUST BE NO LESS THAN 30°F DURING PULLBACK WITHOUT PRIOR WRITTEN APPROVAL FROM THE ENGINEER. 10. CONDUCT 4-HOUR PRE-INSTALLATION HYDROTEST OF HDD PIPE STRING TO MINIMUM 1850 PSIG. 11. SEE SUNOCO PENNSYLVANIA PIPELINE PROJECT ESRI WEBMAP FOR ACCESS ROAD ALIGNMENT.



13. TIMES.

	NOTES	REF. DRAWING			REVISIONS								
2 3 4	2. STATIONING IS BASED ON HORIZONTAL DISTANCES.	ES-4.27	TO ES-4.27	EROSION & SEDIMENT PLAN									
		SHEET 17	TO SHEET 17	AERIAL SITE PLAN	EP2	REVISED PER PADEP COMMENTS RECEIVED 09-06-16	MRS	09/30/16	RMB	09/30/16	aaw	09/30/16	]
					EP1	REVISED PER PADEP COMMENTS	MRS	05/10/16	RMB	05/10/16	AAW	05/10/16	
					EP		JTW	03/15/16	RMB	03/15/16	aaw	03/15/16	
					В	ISSUED FOR BID	DLM	07/31/15	RMB	07/31/15	AAW	07/31/15	f=
					А	ISSUED FOR REVIEW	RTT	03/25/15	RMB	03/25/15	a AAW	03/25/15	
		DWG NO	DWG NO	DESCRIPTION	NO.	DESCRIPTION	BY	DATE	СНК	DATE	APP	DATE	<u> </u>

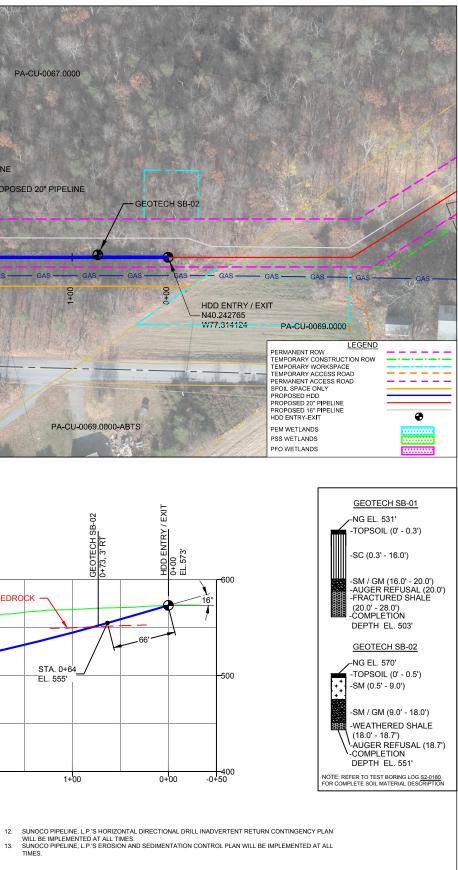

SUNOCO PIPELINE, L.P.									
20-INCH HORIZONTAL DIRECTIONAL DRILL WILDWOOD ROAD PENNSYLVANIA PIPELINE PROJECT									
SCALE:	1"=100'	DWG. NO: PA-CU-0067.0000-RD							
	SCALE:	20-INCH							