ATLANTIC SUNRISE PROJECT PROPOSED 30" NATURAL GAS PIPELINE

SOIL EROSION & SEDIMENT CONTROL AND LAYOUT PLANS FOR NORTH DIAMOND REGULATOR STATION & ASSOCIATED PERMANENT ACCESS ROADS

FACILITY NAME DRAWING NAME & TYPE (36-7935)MF-1A-11 1 of 13 | COVER SHEET REVISED EXISTING CONDITIONS MAP EXISTING CONDITIONS MAP (36-7935)MF-1A-11 (36-7935)MF-1A-11 (36-7935)MF-1A-11 NORTH DIAMOND REGULATOR (36-7935)MF-1A-3 ACCESS ROAD LU-013.1 LAYOUT PLAN STATION (36-7935)MF-1A-3 8 of 13 ACCESS ROAD LU-013.1 LAYOUT PLAN (36-7935)MF-1A-11 SOIL EROSION & SEDIMENT CONTROL NOTES (36-7935)MF-1A-11 SOIL EROSION & SEDIMENT CONTROL NOTES AND DETAILS (36-7935)MF-1A-11

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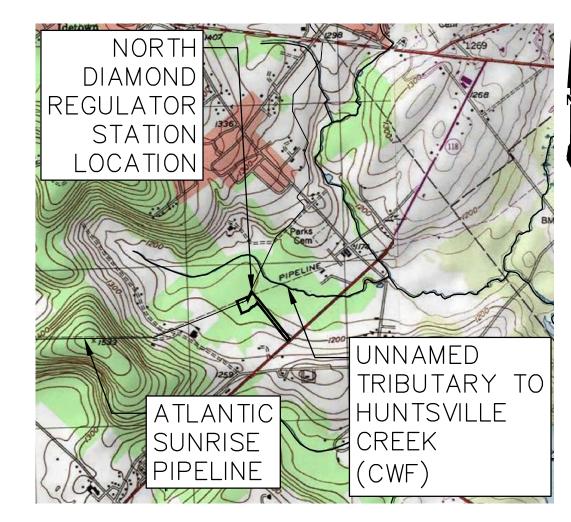
SOIL EROSION & SEDIMENT CONTROL DETAILS

13 of 13 | SOIL EROSION & SEDIMENT CONTROL DETAILS

PHASE 2

LEHMAN TOWNSHIP LUZERNE COUNTY

PENNSYLVANIA



VICINITY MAP

Know what's **below. Call** before you dig. PENNSYLVANIA ACT 287 (1974) AS AMENDED BY PENNSYLVANIÁ ACT 199 (2004) REQUIRES NO LESS THAN THREE (3) WORKING DAYS AND NO MORE THAN (10) WORKING DAYS NOTICE TO UTILITIES BEFORE YOU EXCAVATE,



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MESSAGRED, AND	0	08/28/
FROM FROM None	1	12/02/
ALARIC JAMES BUSHER	3	03/28/
Ball Grances 1/1	4	Oct. 2
100 PE-00320	5	April 2
VSYLVADOU	6	AUG. 2
- Carlotte		
ALARIC J. BUSHER REG NO. PE 60320		
ARCHITECTURE ENGINEERING ENVIRONMENTAL		

REVISIONS W.O. NO. CHK. APP. /2015 BL ISSUED FOR PADEP PERMIT SUBMITTAL /2015 BL ISSUED FOR PADEP RESUBMITTAL 2016 BL ISSUED FOR PADEP RESUBMITTAL 2016 BL PADEP TECHNICAL DEFICIENCY RESPONSE #1
2017 BL PADEP TECHNICAL DEFICIENCY RESPONSE #2 W01161499 AJB AJB W01161499 AJB AJB W01161499 AJB AJB 2017 | BL | PADEP TECHNICAL DEFICIENCY RESPONSE #3


TRANSCONTINENTAL GAS PIPE LINE COMPANY, LLC ATLANTIC SUNRISE PROJECT- PROPOSED 30" NATURAL GAS PIPELINE W01161499 DAK AJB SOIL EROSION & SEDIMENT CONTROL AND LAYOUT PLANS FOR NORTH | W01161499 DAK AJB | DIAMOND REGULATOR STATION & ASSOCIATED PERMANENT ACCESS ROADS | W01161499 AJB AJB | LEHMAN TOWNSHIP, LUZERNE COUNTY, PENNSYLVANIA


COVER SHEET DRAWN BY: JEC DATE: 04/03/15 ISSUED FOR BID: as noted APPROVED BY: AJB DATE: 07/17/15 DRAWING NUMBER: OF **13**

DRILL, BLAST OR DEMOLISH.

ENGINEER OF RECORD **BL COMPANIES** 4242 CARLISLE PIKE, SUITE 260 CAMP HILL, PA 17011 P:717-651-9850

F:717-651-9858

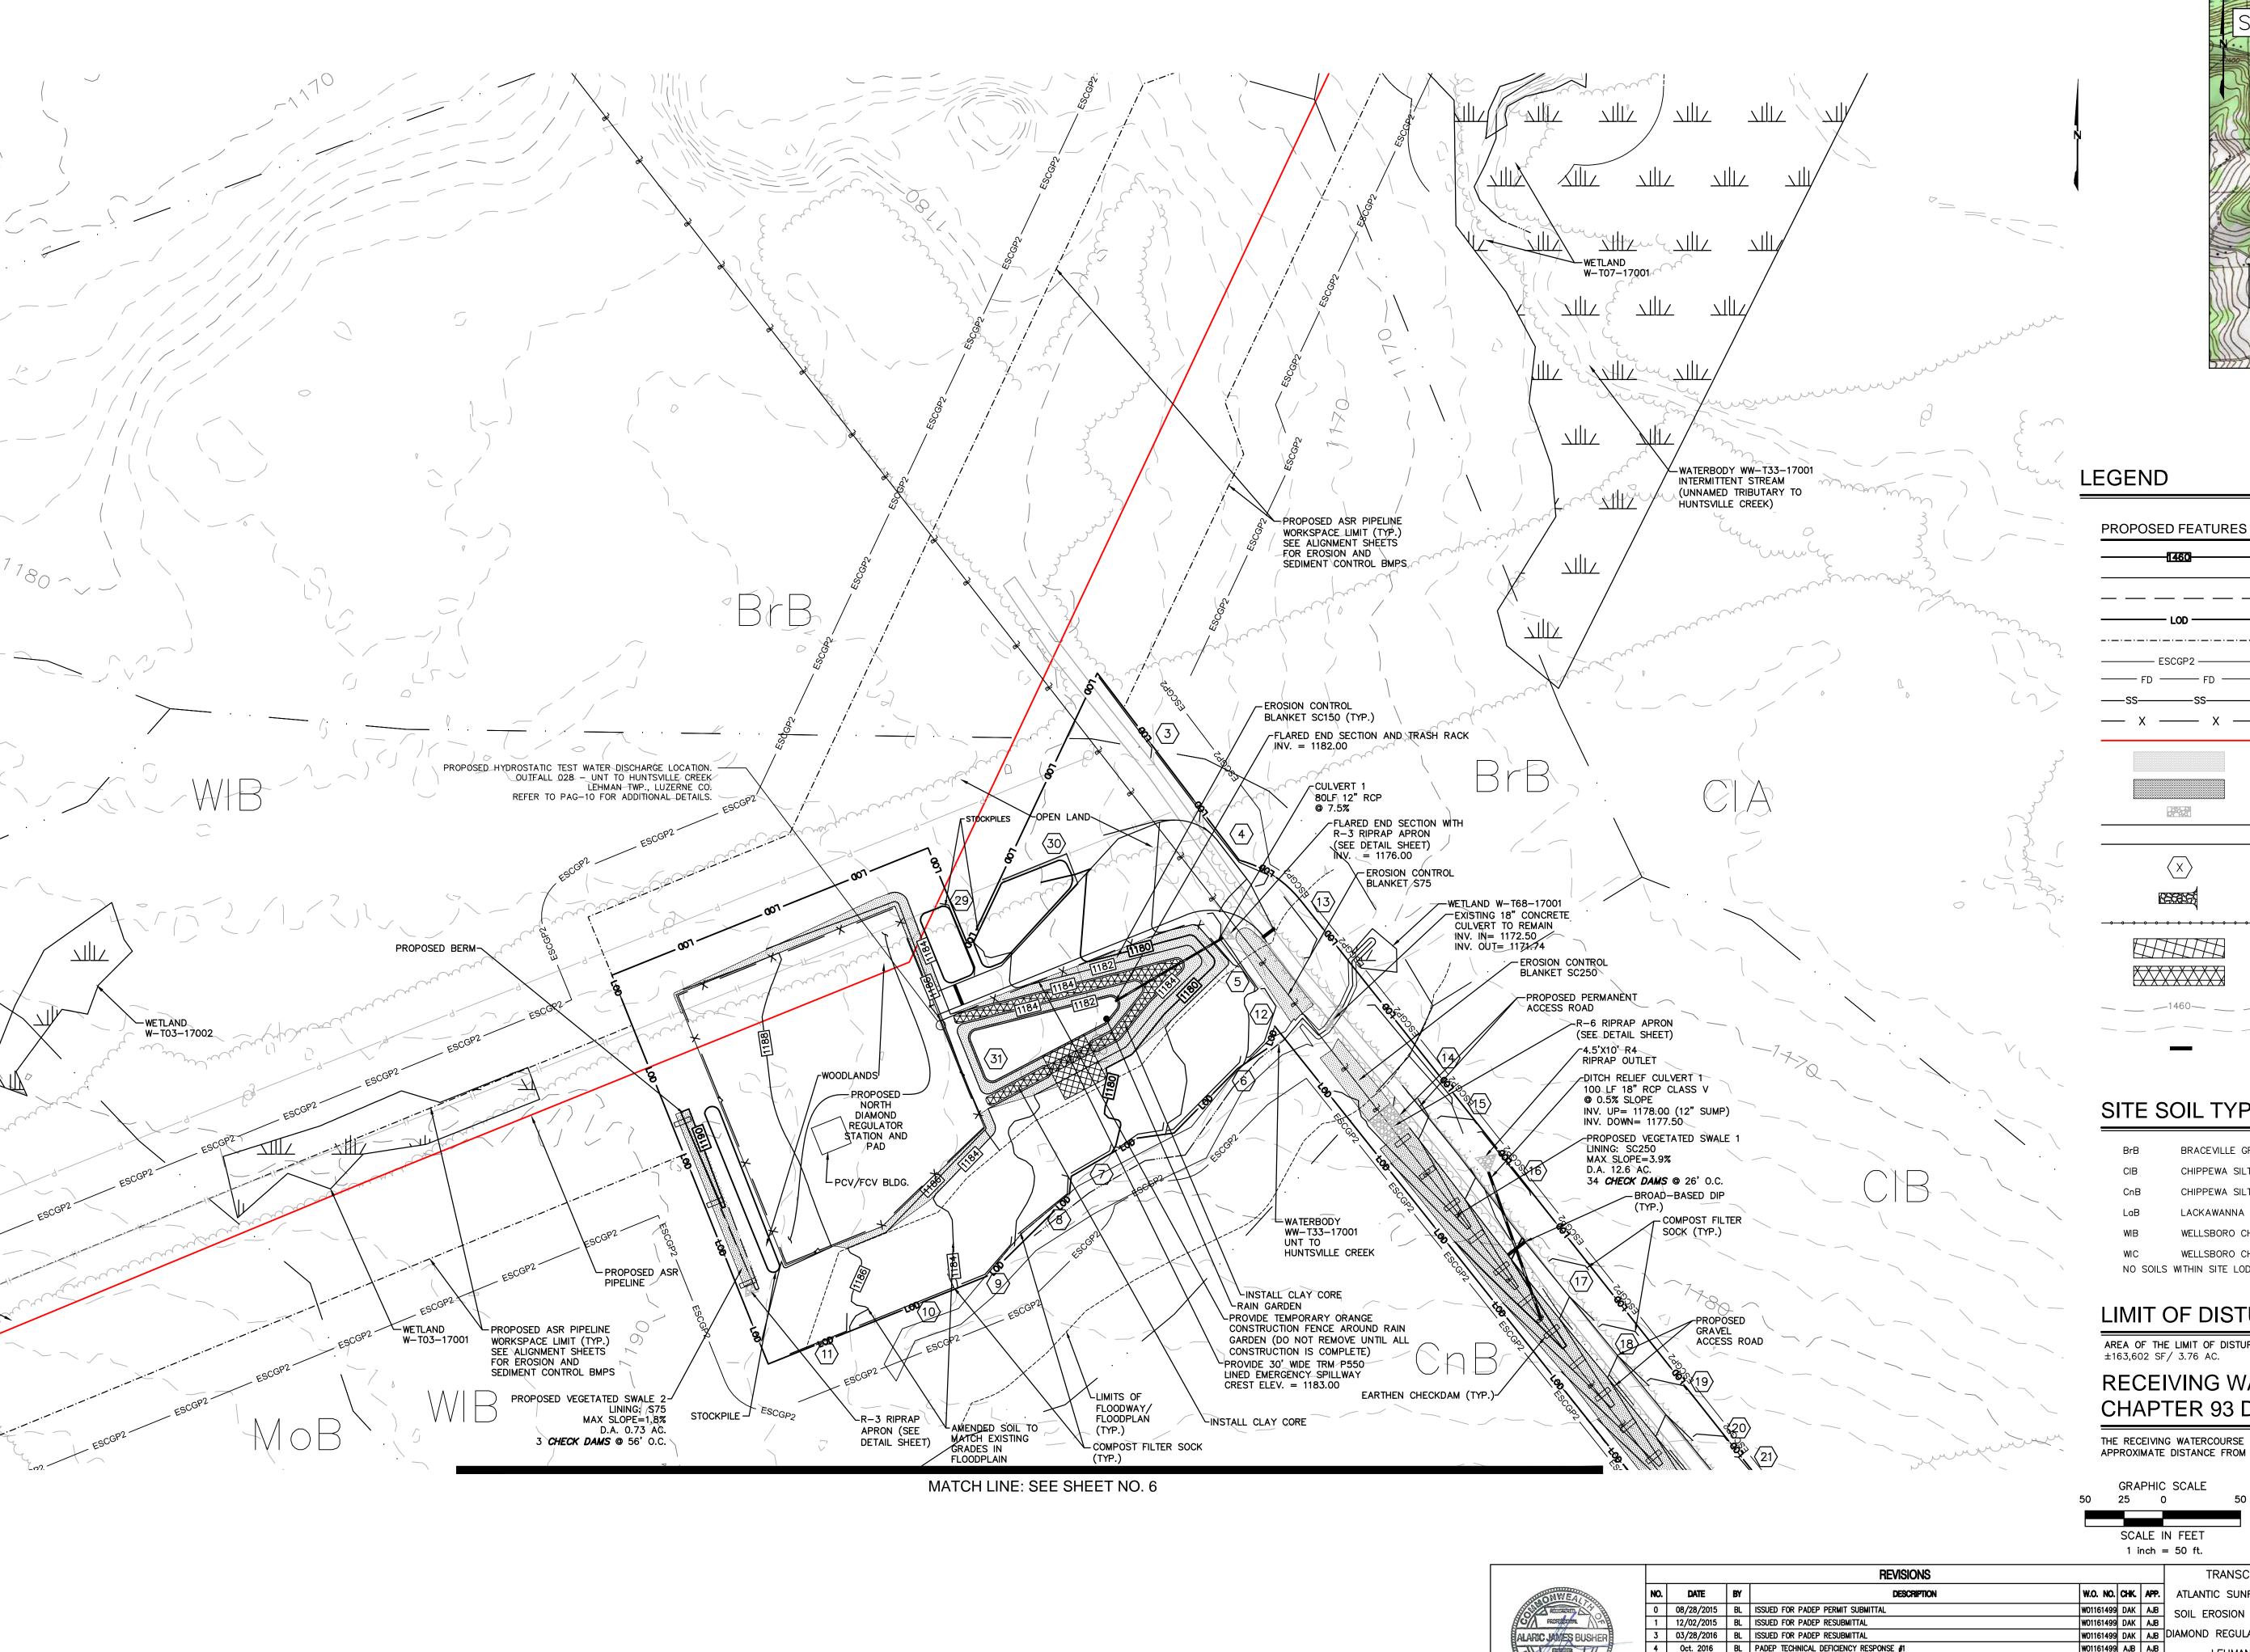

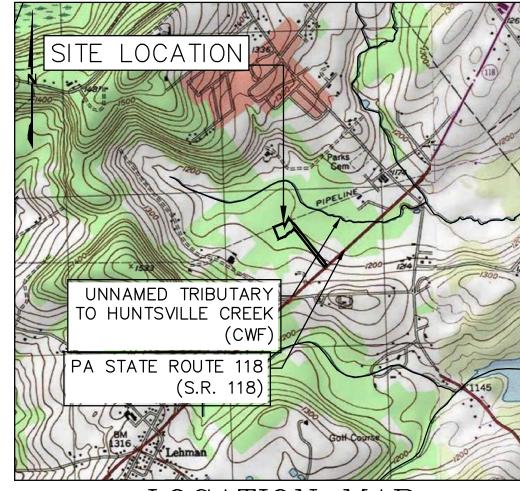

USGS HARVEYS LAKE QUADRANGLE SCALE: 1"=2,000'

PROPOSED MAJOR CONTOUR (10' INTERVAL) PROPOSED MINOR CONTOUR (2' INTERVAL) PROPOSED MINOR CONTOUR (1' INTERVAL)

LIMIT OF DISTURBANCE (NORTH DIAMOND REGULATOR STATION) ESCGP2 ESCGP-2 PERMIT BOUNDARY

—— FD ——— FD ——— FILTER SOCK DIVERSION ——SS———SS——— SEDIMENT BARRIER — χ — χ — ORANGE CONSTRUCTION FENCE CENTERLINE GAS PIPELINE

EROSION CONTROL BLANKET (SC150, OR APPROVED EQUAL) ROCK OUTLET/RIPRAP APRON

SWALE LINING

PROPOSED ACCESS ROAD

SEDIMENT BARRIER DESIGNATION (SEE SHEET 12) ROCK CONSTRUCTION ENTRANCE

BAFFLE TRM LINING $X \times X \times X \times X \times X$ CLAY CORE LIMITS

EXISTING MAJOR CONTOUR (10' INTERVAL) EXISTING MINOR CONTOUR (2' INTERVAL)

BROAD-BASED DIP

SITE SOIL TYPES

BRACEVILLE GRAVELLY LOAM, 3 TO 8 PERCENT SLOPES

CHIPPEWA SILT LOAM, 3 TO 8 PERCENT SLOPES

CHIPPEWA SILT LOAM, 0 TO 8 PERCENT SLOPES

LACKAWANNA CHANNERY SILT LOAM, 3 TO 8 PERCENT SLOPES WELLSBORO CHANNERY SILT LOAM, 3 TO 8 PERCENT SLOPES

WELLSBORO CHANNERY SILT LOAM, 8 TO 15 PERCENT SLOPES

NO SOILS WITHIN SITE LOD ARE KNOWN TO PRODUCE ACIDIC STORMWATER RUNOFF.

LIMIT OF DISTURBANCE

AREA OF THE LIMIT OF DISTURBANCE IS:

RECEIVING WATERCOURSE -CHAPTER 93 DESIGNATION


AJB DATE:

THE RECEIVING WATERCOURSE IS UNNAMED TRIBUTARY TO HUNTSVILLE CREEK CWF APPROXIMATE DISTANCE FROM SITE TO UNT TO HUNTSVILLE CREEK: ±500 FT (NORTHEAST)

SHEET 5


OF **13**


(36-7935)MF-1A-11

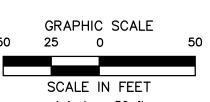

APPROVED BY:

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		REVISIONS						TRANSCONTINENTAL GAS PIPE LINE COMPANY, LLC							
	NO.	DATE	BY	DESCRIPTION	W.O. NO.	снк.	APP.	MPP. ATLANTIC SUNRISE PROJECT- PROPOSED 30" NATURAL GAS PIPELINE							
	0	08/28/2015	BL	ISSUED FOR PADEP PERMIT SUBMITTAL	W01161499	DAK	AJB	SOIL EROSION & SEDIMENT CONTROL AND LAYOUT PLANS FOR NORTH							
	1	12/02/2015	BL	ISSUED FOR PADEP RESUBMITTAL	W01161499			AJB							
	3	03/28/2016	BL	ISSUED FOR PADEP RESUBMITTAL	W01161499	DAK	AJB DIAMOND REGULATOR STATION & ASSOCIATED PERMANENT ACCESS ROADS						S Williame		
9	4	Oct. 2016	BL	PADEP TECHNICAL DEFICIENCY RESPONSE #1	W01161499	AJB	AJB	JB LEHMAN TOWNSHIP, LUZERNE COUNTY, PENNSYLVANIA							
7	5	April 2017	BL	PADEP TECHNICAL DEFICIENCY RESPONSE #2	W01161499	AJB	AJB								
	6	AUG. 2017	BL	PADEP TECHNICAL DEFICIENCY RESPONSE #3	W0116149	AJB	AJB	SOIL EROSION & SEDIMENT CONTROL PLAN							
								DRAWN BY: JFC	DATE:	04/03/15	ISSUED FOR BID:	SCALE:	AS NOTED		
												1			
E 60320								CHECKED BY: AJB	DATE:	04/03/15	ISSUED FOR CONSTRUCTION:	REVISION:	6		

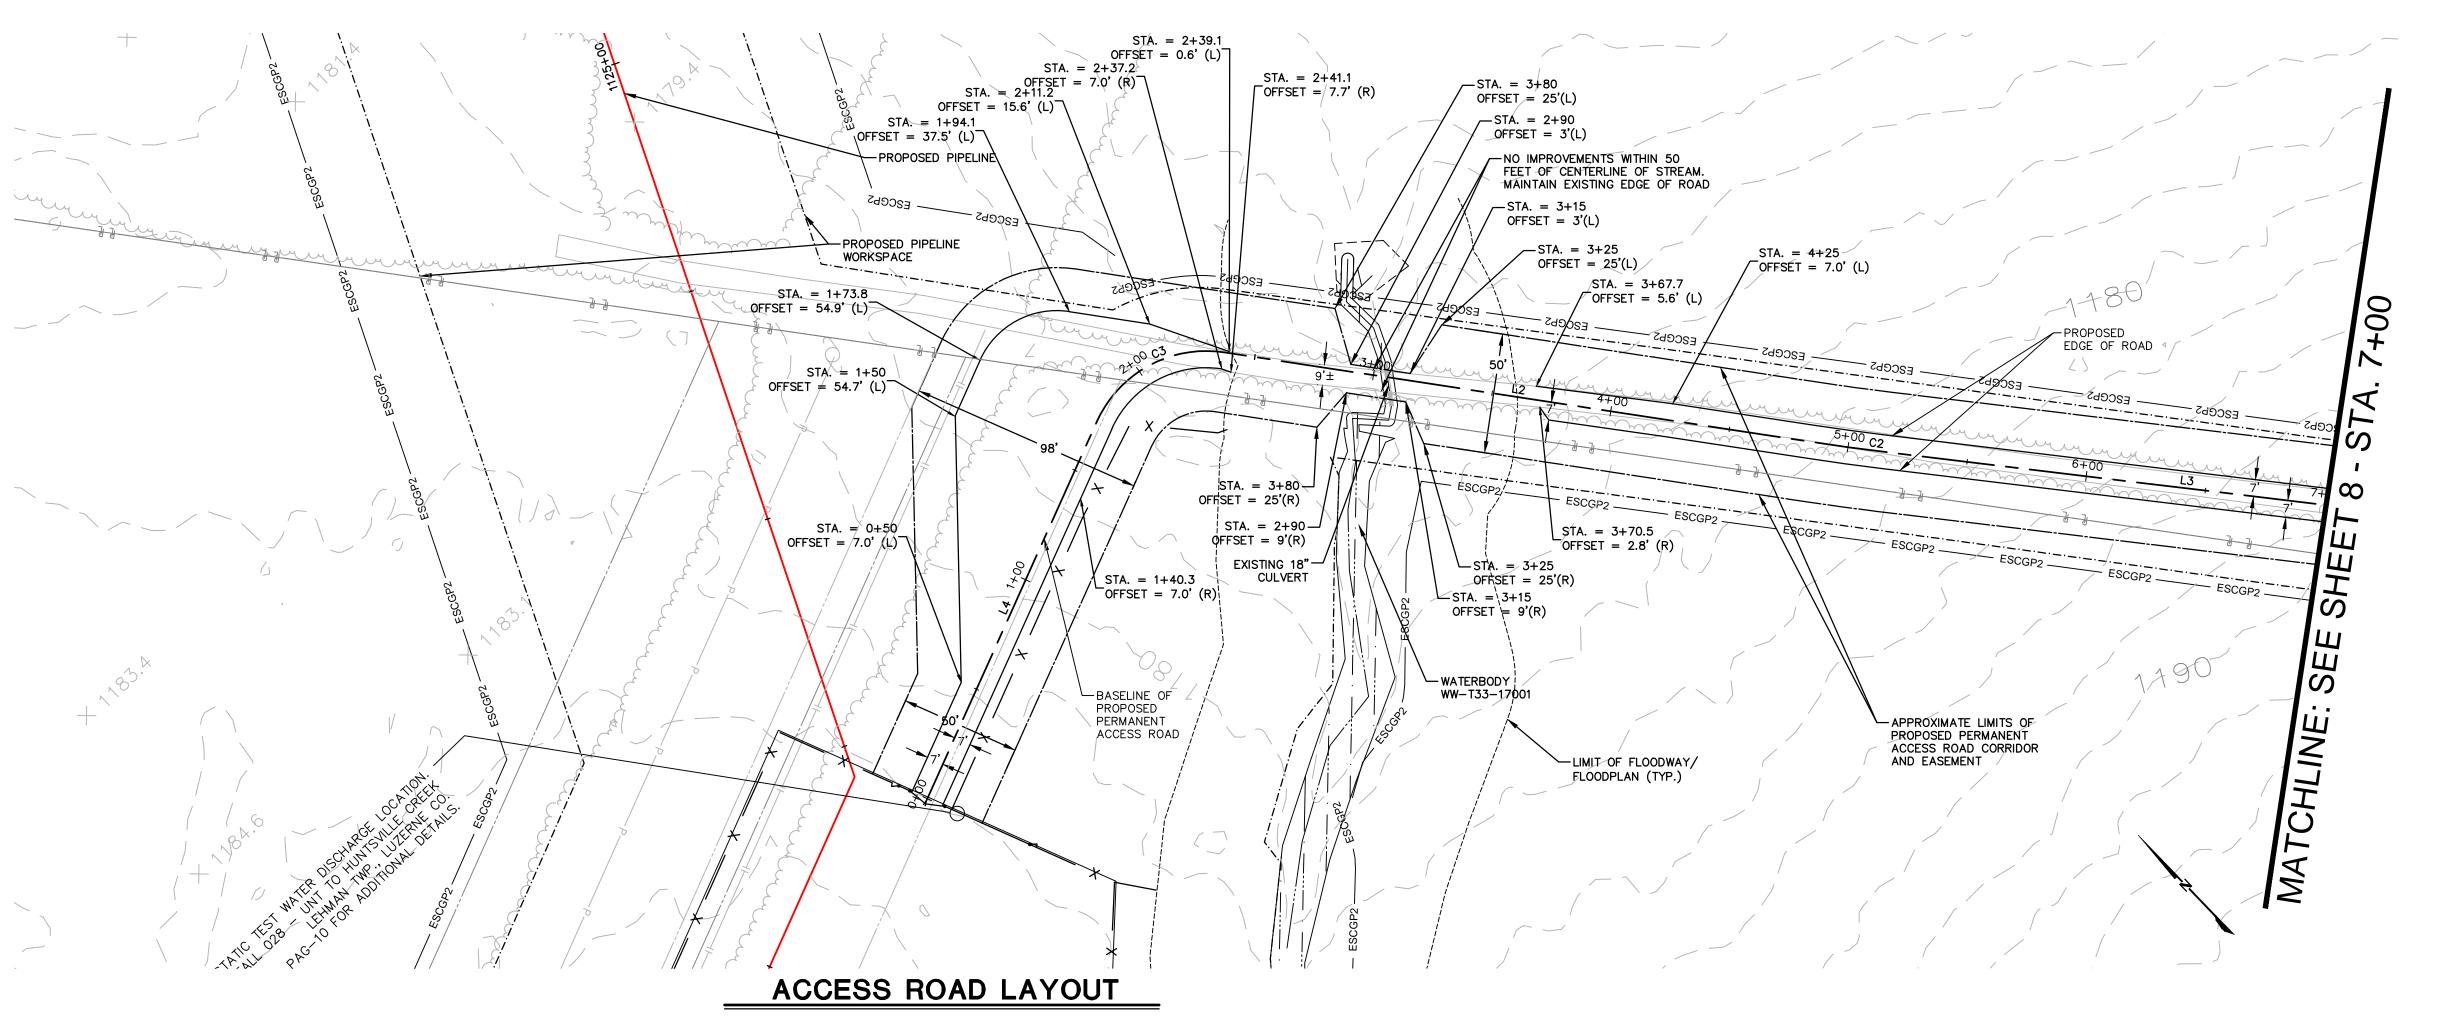

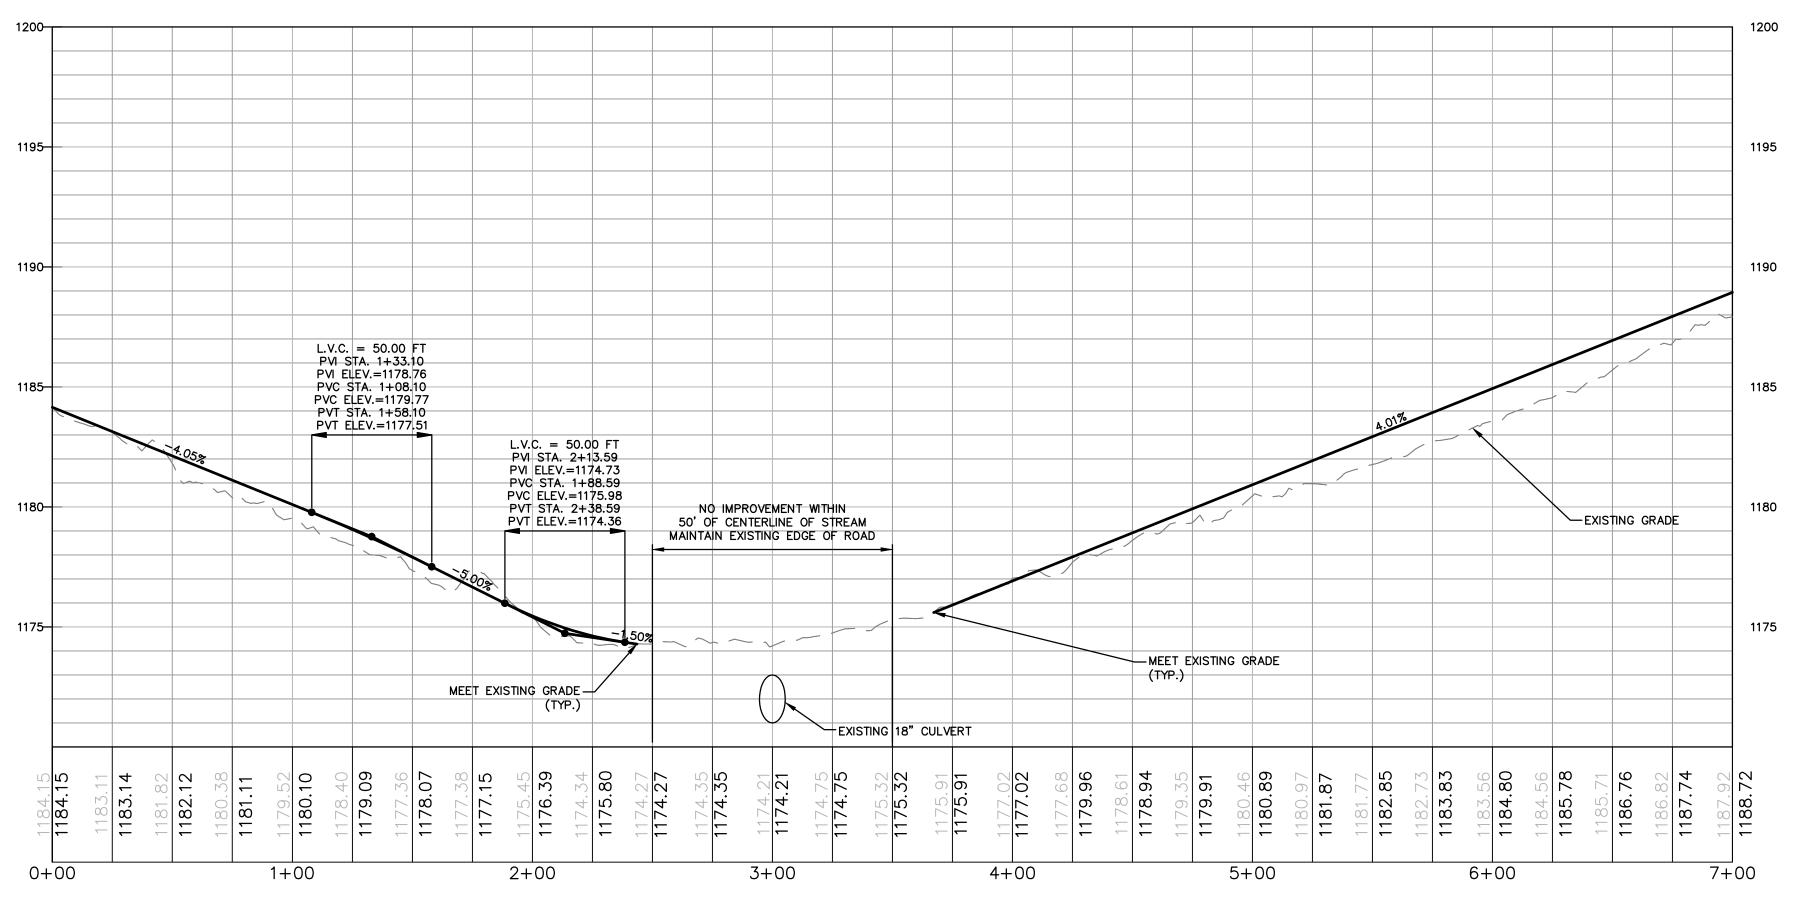

			LU013.1				
No.	Northing	Easting	Bearing	Delta(△)	Length	Tangent	Radius
L4	B 428259.10 E 428323.33	B 2446035.37 E 2446195.13	N68°05'47.80"E		172.18'		
С3	PC 428323.33 PI 428337.50 PT 428307.35	PC 2446195.13 PI 2446230.37 PT 2446253.47		74*26'52"	64.97'	37.98'	50.0'
L2	B 428307.35 E 428111.10	B 2446253.47 E 2446403.82	S37°27'20.31"E		247.22'		
C2	PC 428111.10 PI 428098.75 PT 428086.69	PC 2446403.82 PI 2446413.28 PT 2446423.12		1*46'59"	31.12'	15.56'	1000.0
L3	B 428086.69 E 427890.79	B 2446423.12 E 2446583.12	S39"14'19.12"E		252.93'		
C1	PC 427890.79 PI 427879.24 PT 427867.40	PC 2446583.12 PI 2446592.56 PT 2446601.65		1*42'36"	29.84'	14.92'	1000.0
L1	B 427867.40 E 427455.58	B 2446601.65 E 2446917.98	S37°31'43.19"E		519.29'		

AR-LU-013.	1 TYPICAL SECT	ION TABLE		
BEGIN STA	END STA	TYPICAL SECTION		
0+00	2+50	E		
2+50	3+50	N/A		
3+50	12+95	G		

GENERAL ACCESS ROAD NOTES

- 1. THE CONTRACTOR SHALL CONTACT PA ONE CALL A MINIMUM OF 72 HOURS PRIOR TO BEGINNING
- 2. TRANSITIONS BETWEEN TYPICAL ACCESS ROAD SECTIONS SHALL OCCUR OVER 50 FEET.
- 3. NO EARTH DISTURBING IMPROVEMENTS ARE PROPOSED WITHIN FLOODWAYS TO MINIMIZE IMPACTS.
- 4. DISTURBANCE OUTSIDE THE PROPOSED LIMITS OF GRADING (WHERE APPLICABLE) SHALL BE LIMITED TO USE OF EXISTING ROADS TO ACCESS THE PIPELINE ROW, TOPSOIL STOCKPILING, INSTALLATION OF SEDIMENT BARRIERS, AND MATERIAL STORAGE IN ACCORDANCE WITH THE LAND OWNER
- 5. EROSION & SEDIMENTATION CONTROLS SHALL BE LEFT IN PLACE UNTIL SUCH TIME AS THE DISTURBED AREAS HAVE PERMANENT STABILIZATION. AN AREA SHALL BE CONSIDERED TO HAVE ACHIEVED FINAL STABILIZATION WHEN IT HAS A MINIMUM UNIFORM 70% PERENNIAL VEGETATIVE COVER OR OTHER PERMANENT NON-VEGETATIVE COVER WITH A DENSITY SUFFICIENT TO RESIST ACCELERATED SURFACE EROSION AND SUBSURFACE CHARACTERISTICS SUFFICIENT TO RESIST
- 6. ALL SLOPES THAT ARE EQUAL TO OR STEEPER THAN 1(V): 3(H) SHALL BE SEEDED AND THEN COVERED WITH EROSION CONTROL BLANKET. THE BLANKET SHALL BE NORTH AMERICAN GREEN SC150 OR APPROVED EQUAL AND INSTALLED IN ACCORDANCE WITH THE MANUFACTURERS
- 7. ALL NONWOVEN GEOTEXTILE SHALL BE MIRAFI 140N OR EQUAL.

SLIDING AND OTHER MOVEMENTS.

SPECIFICATIONS.

8. FOR PERMANENT ROADS **WITH PERMANENT IMPROVEMENTS, BROAD-BASED DIPS** SHALL REMAIN AS PART OF THE PERMANENT IMPROVEMENTS.


105 COORDINATION NOTE:

THE CALCULATION OF FILL VOLUMES PROVIDED WITHIN THE CHAPTER 105
APPLICATION IS BASED ON THE EXTENT OF THE ACCESS ROAD LOD WITHIN THE FLOODPLAIN/FLOODWAY TO ACCOUNT FOR WORST-CASE FIELD SCENARIOS REQUIRING THE ADDITION OF A ONE FOOT—DEPTH OF GRAVEL FOR MAINTENANCE AND/OR MINOR ACCESS ROAD WIDENING FOR IMPROVED ACCESS. AS SUCH, THE FILL VOLUME IS AN OVERESTIMATION AND DOES NOT REFLECT THE ACTUAL VOLUME OF VOLUME IS AN OVERESTIMATION AND DOES NOT REFLECT THE ACTUAL VOLUME OF FILL REQUIRED BY THE CURRENT ACCESS ROAD DESIGN, AS PRESENTED WITHIN THE CHAPTER 102 PERMIT. THE INCLUSION OF THE OVERESTIMATED FILL VOLUMES WITHIN THE CHAPTER 105 APPLICATION LIMITS FUTURE REVISIONS TO THE CHAPTER 105 APPLICATION DUE TO MINOR FIELD ADJUSTMENTS; CONVERSELY, REVISIONS TO ACCESS ROAD DESIGN AFTER THE 102 PERMIT ISSUANCE WILL BE COORDINATED WITH

> 40 20 0 SCALE IN FEET VERTICAL SCALE 1"=4" GRAPHIC SCALE 4 2 0 SCALE IN FEET

HORIZONTAL SCALE 1"=40'

PERMANENT ACCESS ROAD LU-013.1 @ MP 21.24

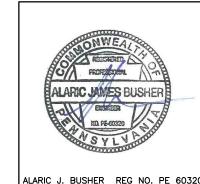

	REVISIONS									
10 .	DATE	BY	DESCRIPTION	W.O. NO.	снк.	APP.	/			
0	08/28/2015	BL	ISSUED FOR PADEP PERMIT SUBMITTAL	W01161499	DAK	AJB	l s			
1	12/02/2015	BL	ISSUED FOR PADEP RESUBMITTAL	W01161499	DAK	AJB] ~			
3	03/28/2016	BL	ISSUED FOR PADEP RESUBMITTAL	W01161499	DAK	AJB]DIA			
4	Oct. 2016	BL	PADEP TECHNICAL DEFICIENCY RESPONSE #1	W01161499	AJB	AJB]			
5	April 2017	BL	PADEP TECHNICAL DEFICIENCY RESPONSE #2	W01161499	AJB	AJB]			
6	AUG. 2017	BL	PADEP TECHNICAL DEFICIENCY RESPONSE #3	W01161499	AJB	AJB]			
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ATLANTIC SUNRISE PROJECT- PROPOSED 30" NATURAL GAS PIPELINE SOIL EROSION & SEDIMENT CONTROL AND LAYOUT PLANS FOR NORTH DIAMOND REGULATOR STATION & ASSOCIATED PERMANENT ACCESS ROADS

LEHMAN TOWNSHIP, LUZERNE COUNTY, PENNSYLVANIA

TRANSCONTINENTAL GAS PIPE LINE COMPANY, LLC

ACCESS ROAD LU-013.1 LAYOUT PLAN										
/N BY:	JO	DATE:	04/03/15	ISSUED FOR BID:	SCALE:	as notei)			
KED BY:	AJB	DATE:	04/03/15	ISSUED FOR CONSTRUCTION:	REVISION:	6				
OVED BY:	AJB	DATE:	07/17/15	DRAWING NUMBER: (36-7935)MF-1A-	(36-7935)MF-1A-3		7			
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ACCESS ROAD PROFILE

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